


three inches = one foot
one and one half inches = one foot
one inch = one foot
three quarters inch = one foot
one half inch = one foot
three eighths inch = one foot
one quarter inch = one foot
one eighth inch = one foot

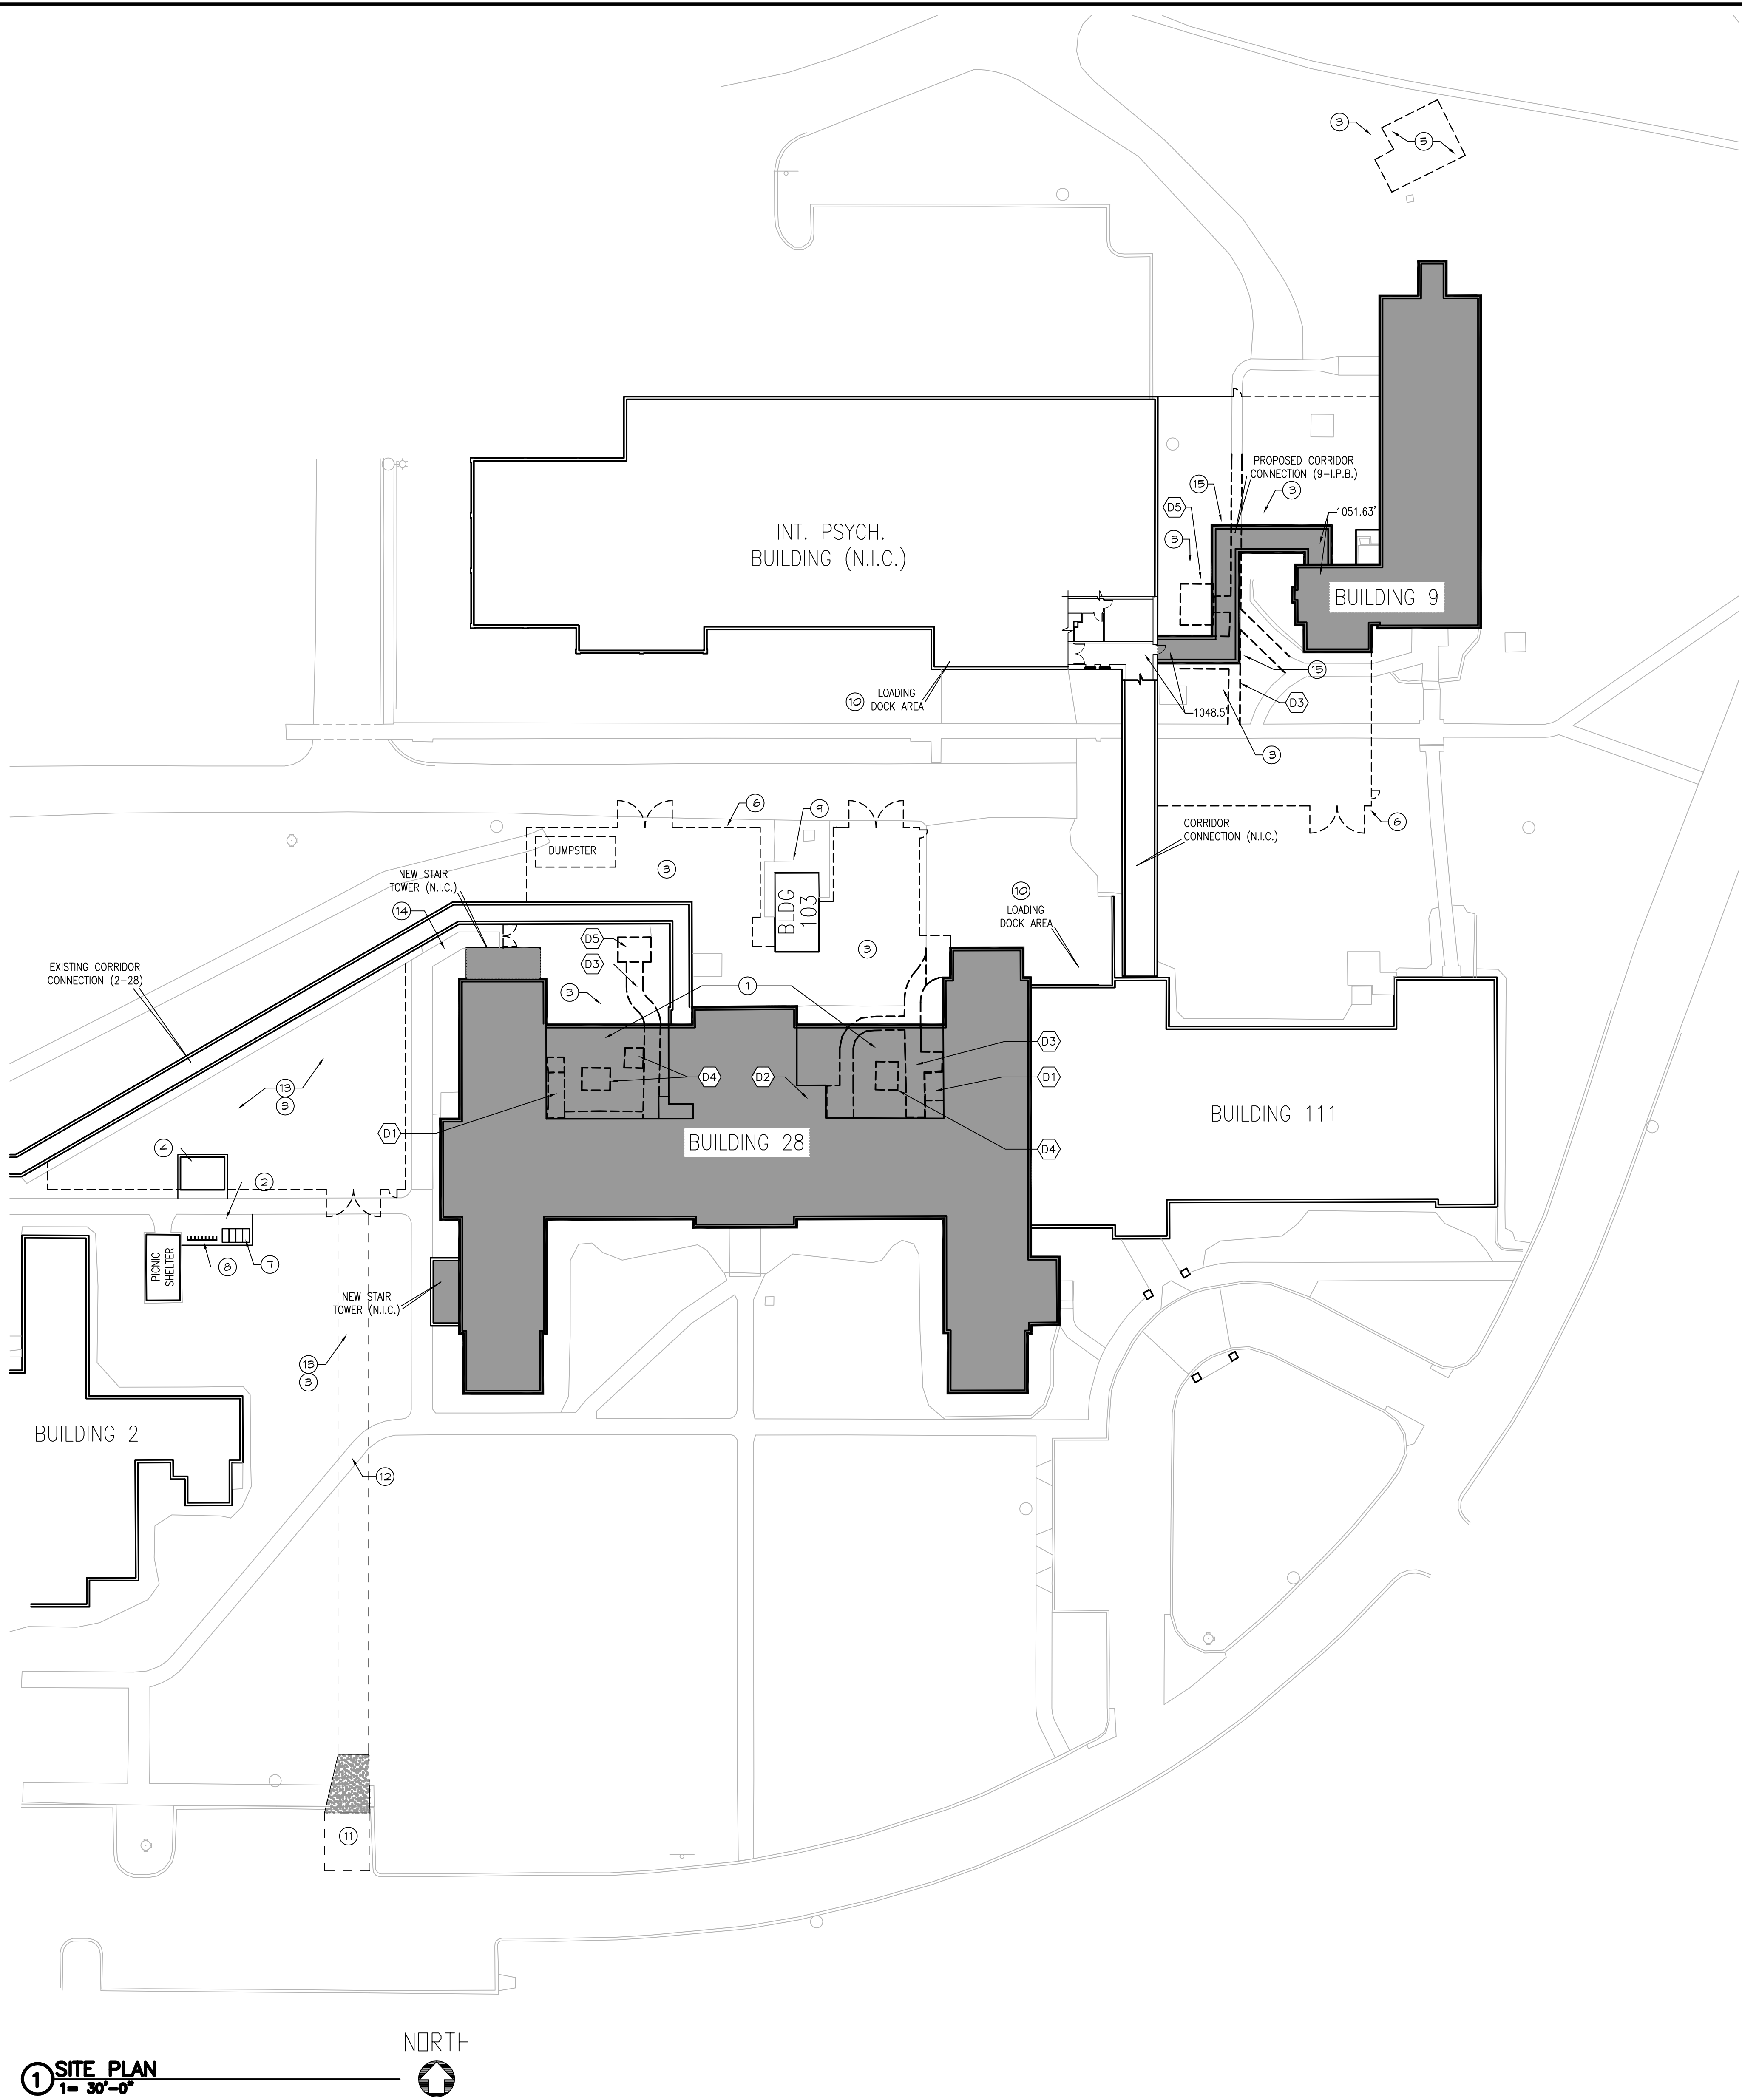

CONTRACTOR PARKING & STAGING NOTES

CONSTRUCTION FENCE TO BE 6' TALL CHAIN LINK. SEE GENERAL CONDITIONS NOTES. UTILITY LOCATES/CHECKS REQUIRED PRIOR TO CONSTRUCTION FENCE PLACEMENT

CONTRACTOR PARKING:
(10) PARKING STALLS ALLOWED AT THE EAST CONTRACTOR PARKING LOT

CONTRACTOR STORAGE TRAILER:
(1) STORAGE TRAILER ALLOWED AT EAST CONTRACTOR PARKING LOT

VA IS NOT RESPONSIBLE FOR ITEMS LOST OR STOLEN FROM CONTRACTOR VEHICLES OR STORAGE TRAILER

WEST CONSTRUCTION STAGING AREA TO BE REMOVED FOLLOWING COMPLETION OF PHASE 2 SHELL. RESTORE AND RE-ESTABLISH GRASS PER PROJECT GENERAL NOTES AND SPECIFICATIONS.

SITE DEMO NOTES

- (D1) EXTERIOR STAIR AND ROOF CANOPY STRUCTURE TO BE REMOVED
- (D2) AT GRADE ELEVATOR LOBBY STRUCTURE TO BE REMOVED
- (D3) EXISTING SIDEWALKS TO BE REMOVED
- (D4) MECHANICAL EQUIPMENT TO BE RELOCATED
- (D5) SMOKE SHACK TO BE RELOCATED

SITE PLAN NOTES

- (1) NEW 2-STORY INFILL ADDITION
- (2) NEW SIDEWALK AREA FOR BIKE RACKS
- (3) RE-ESTABLISH GRASS AFTER CONSTRUCTION
- (4) NEW LOCATION FOR EXISTING RELOCATED SMOKE SHACK. VERIFY LOCATION WITH C.O.R.
- (5) PROPOSED UNDERGROUND STORMWATER DETENTION SYSTEM, SEE CIVIL
- (6) PROPOSED CONSTRUCTION FENCING WITH ACCESS GATES
- (7) NEW COVERED BIKE STORAGE UNITS (4)
- (8) NEW BIKE RACK (8 SPACES)
- (9) MAINTAIN ACCESS TO BUILDING 103 GENERATOR
- (10) MAINTAIN ACCESS TO LOADING DOCKS AT BUILDING 111 AND INTERMEDIATE PSYCHOLOGY BUILDING
- (11) (2) STALLS ALLOWED TO BE BLOCKED OFF FOR ACCESS TO STAGING AREA
- (12) MAINTAIN SIDEWALK FOR DURATION OF PROJECT
- (13) RESTORE AFTER PHASE 2 SHELL COMPLETE
- (14) MAINTAIN SIDEWALK ACCESS TO NW STAIR TOWER
- (15) SEE CIVIL FOR NEW SIDEWALK PLAN

1 SITE PLAN
1" = 30'-0"



100% CD Set

**FOR
CONSTRUCTION**

No	REVISION	DATE



Alexandria
525 Broadway Street
Alexandria, MN 56008
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facsimile 320.759.9062
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JLG 11129 JLG 11129


DESIGNED BY
DANIEL J. MILLER, AIA
DATE: 12-20-2013
REVISION
RES. NO.

DRAWING TITLE
**BUILDING 28 & 9 OVERALL SITE
PLAN**


PROJECT TITLE
**RECONFIGURE/EXPAND
BUILDINGS 28 & 9 FOR
RESIDENTIAL REHABILITATION
TREATMENT PROGRAM**

DATE
12.20.2013
PROJECT NO.
896-12-339
DRAWING NO.
AS001



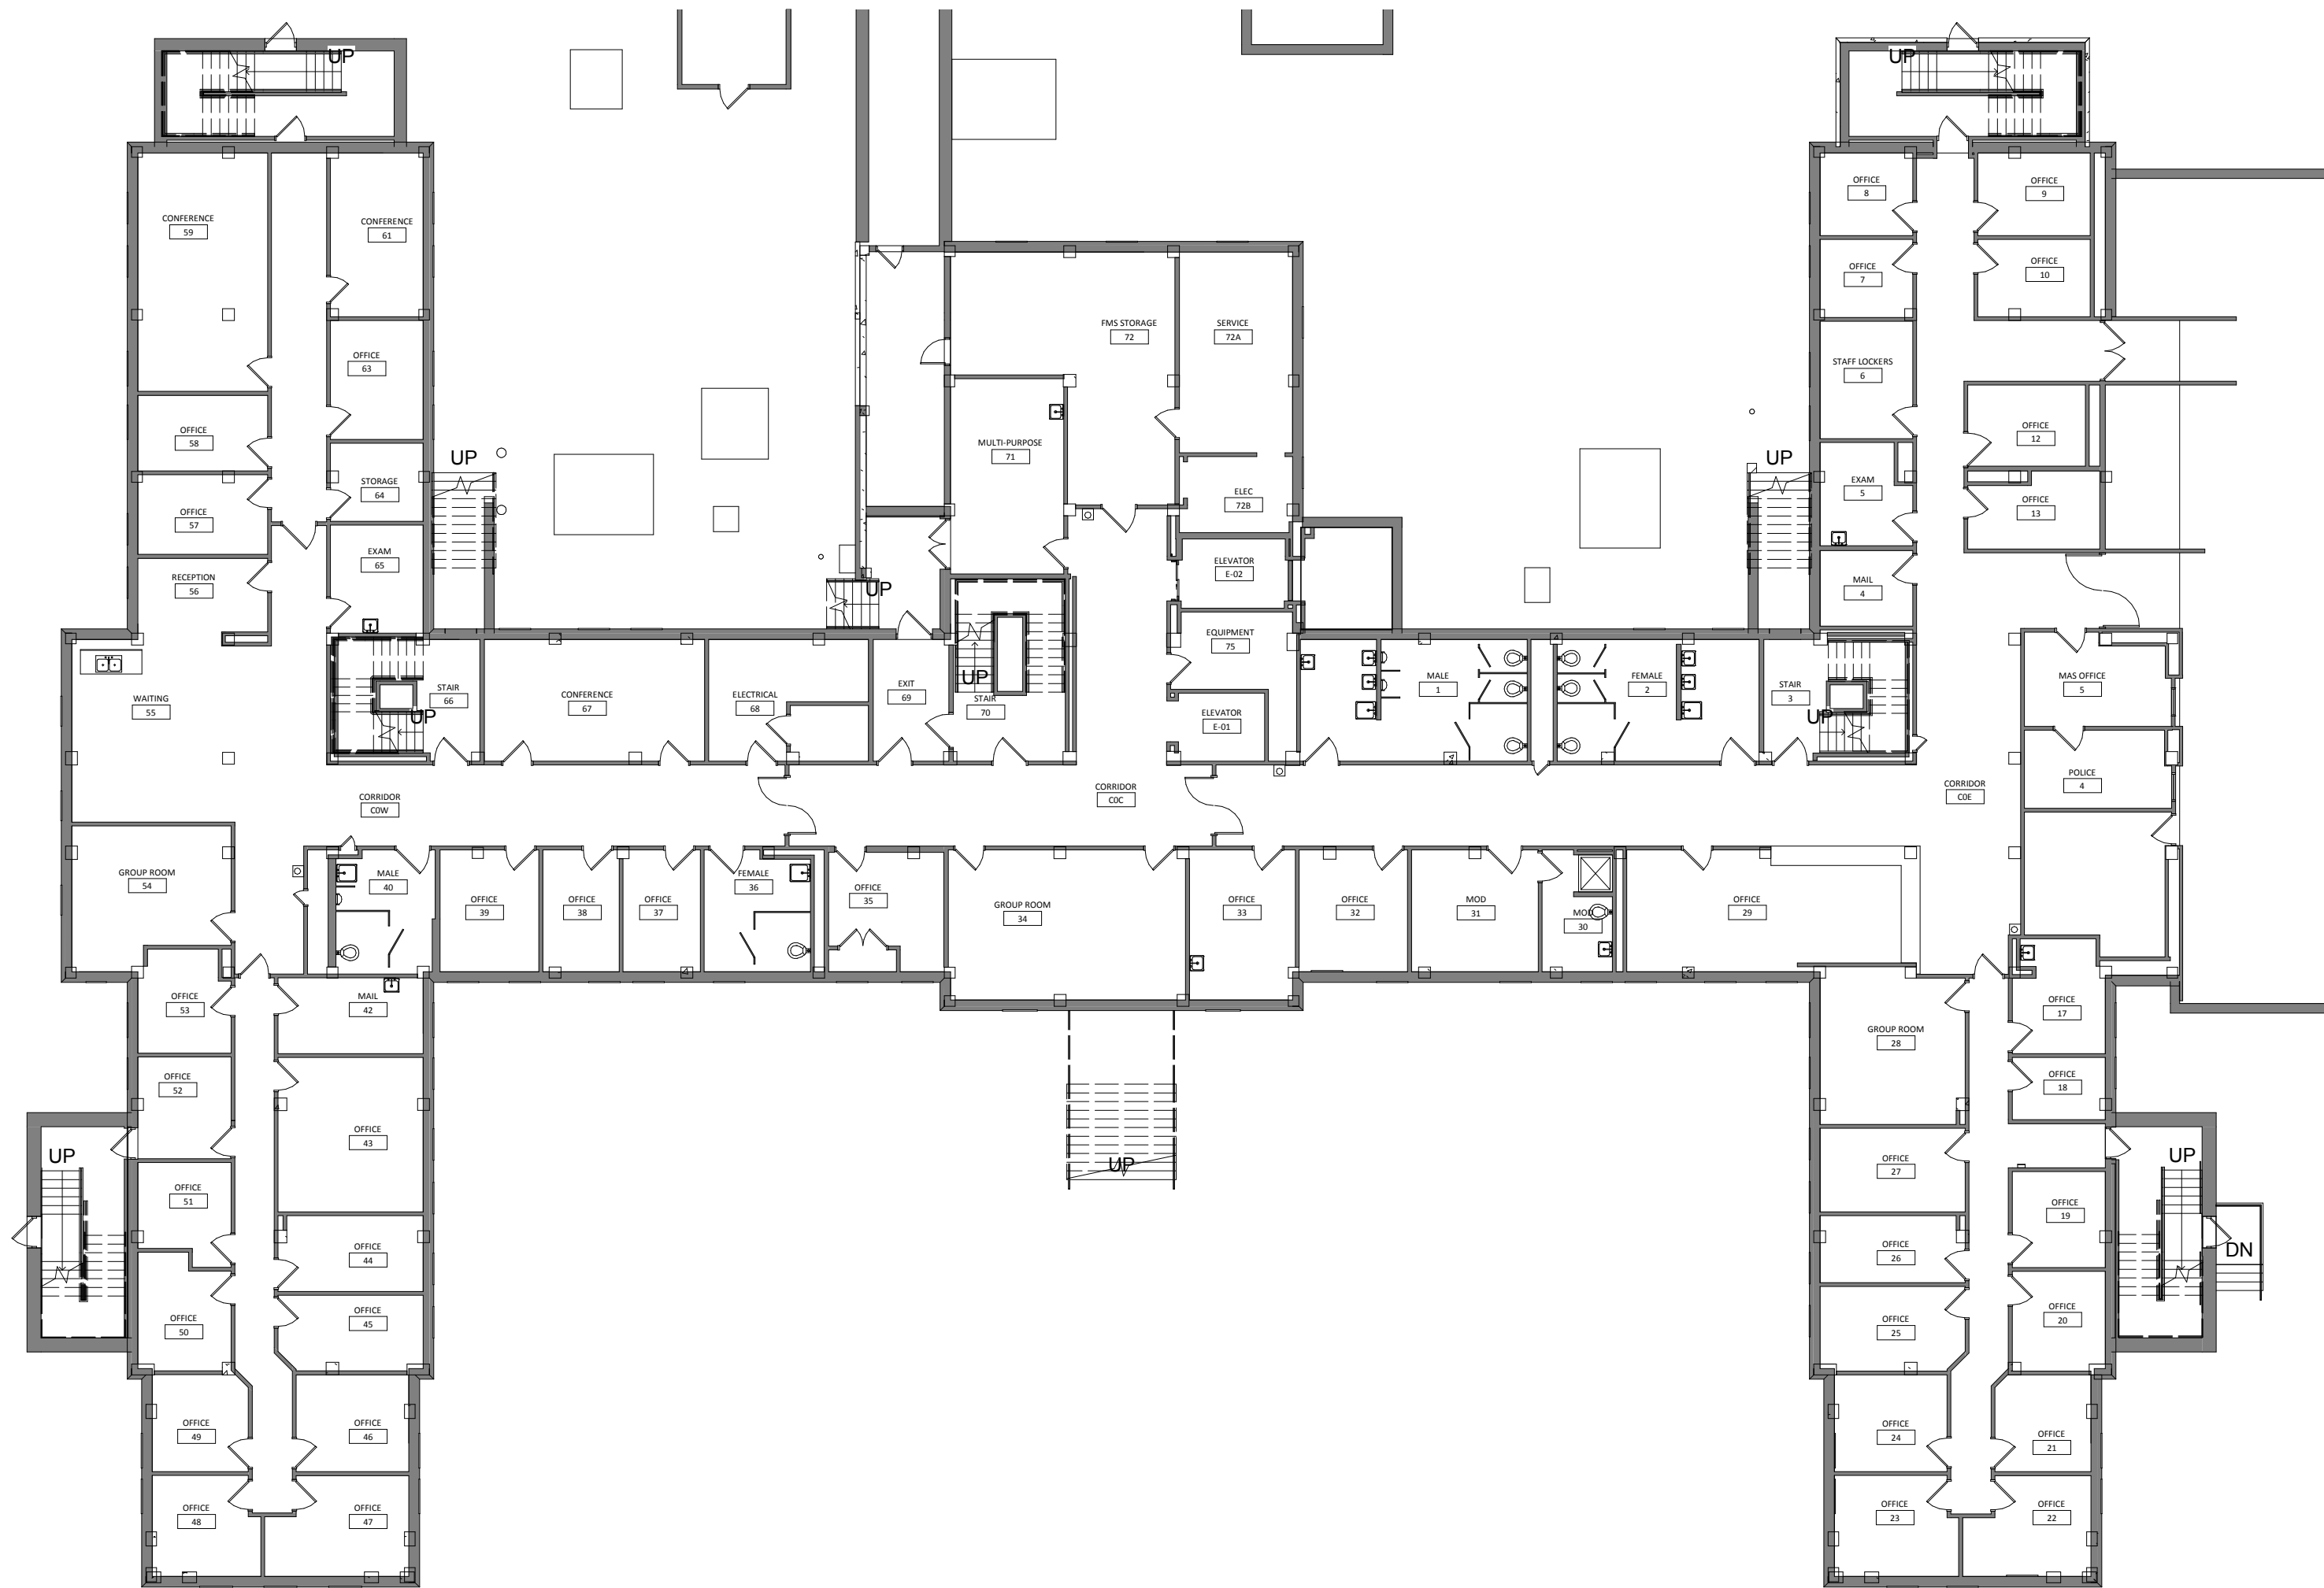


3 BASEMENT PLAN - PHASING
1/16" = 1'-0"

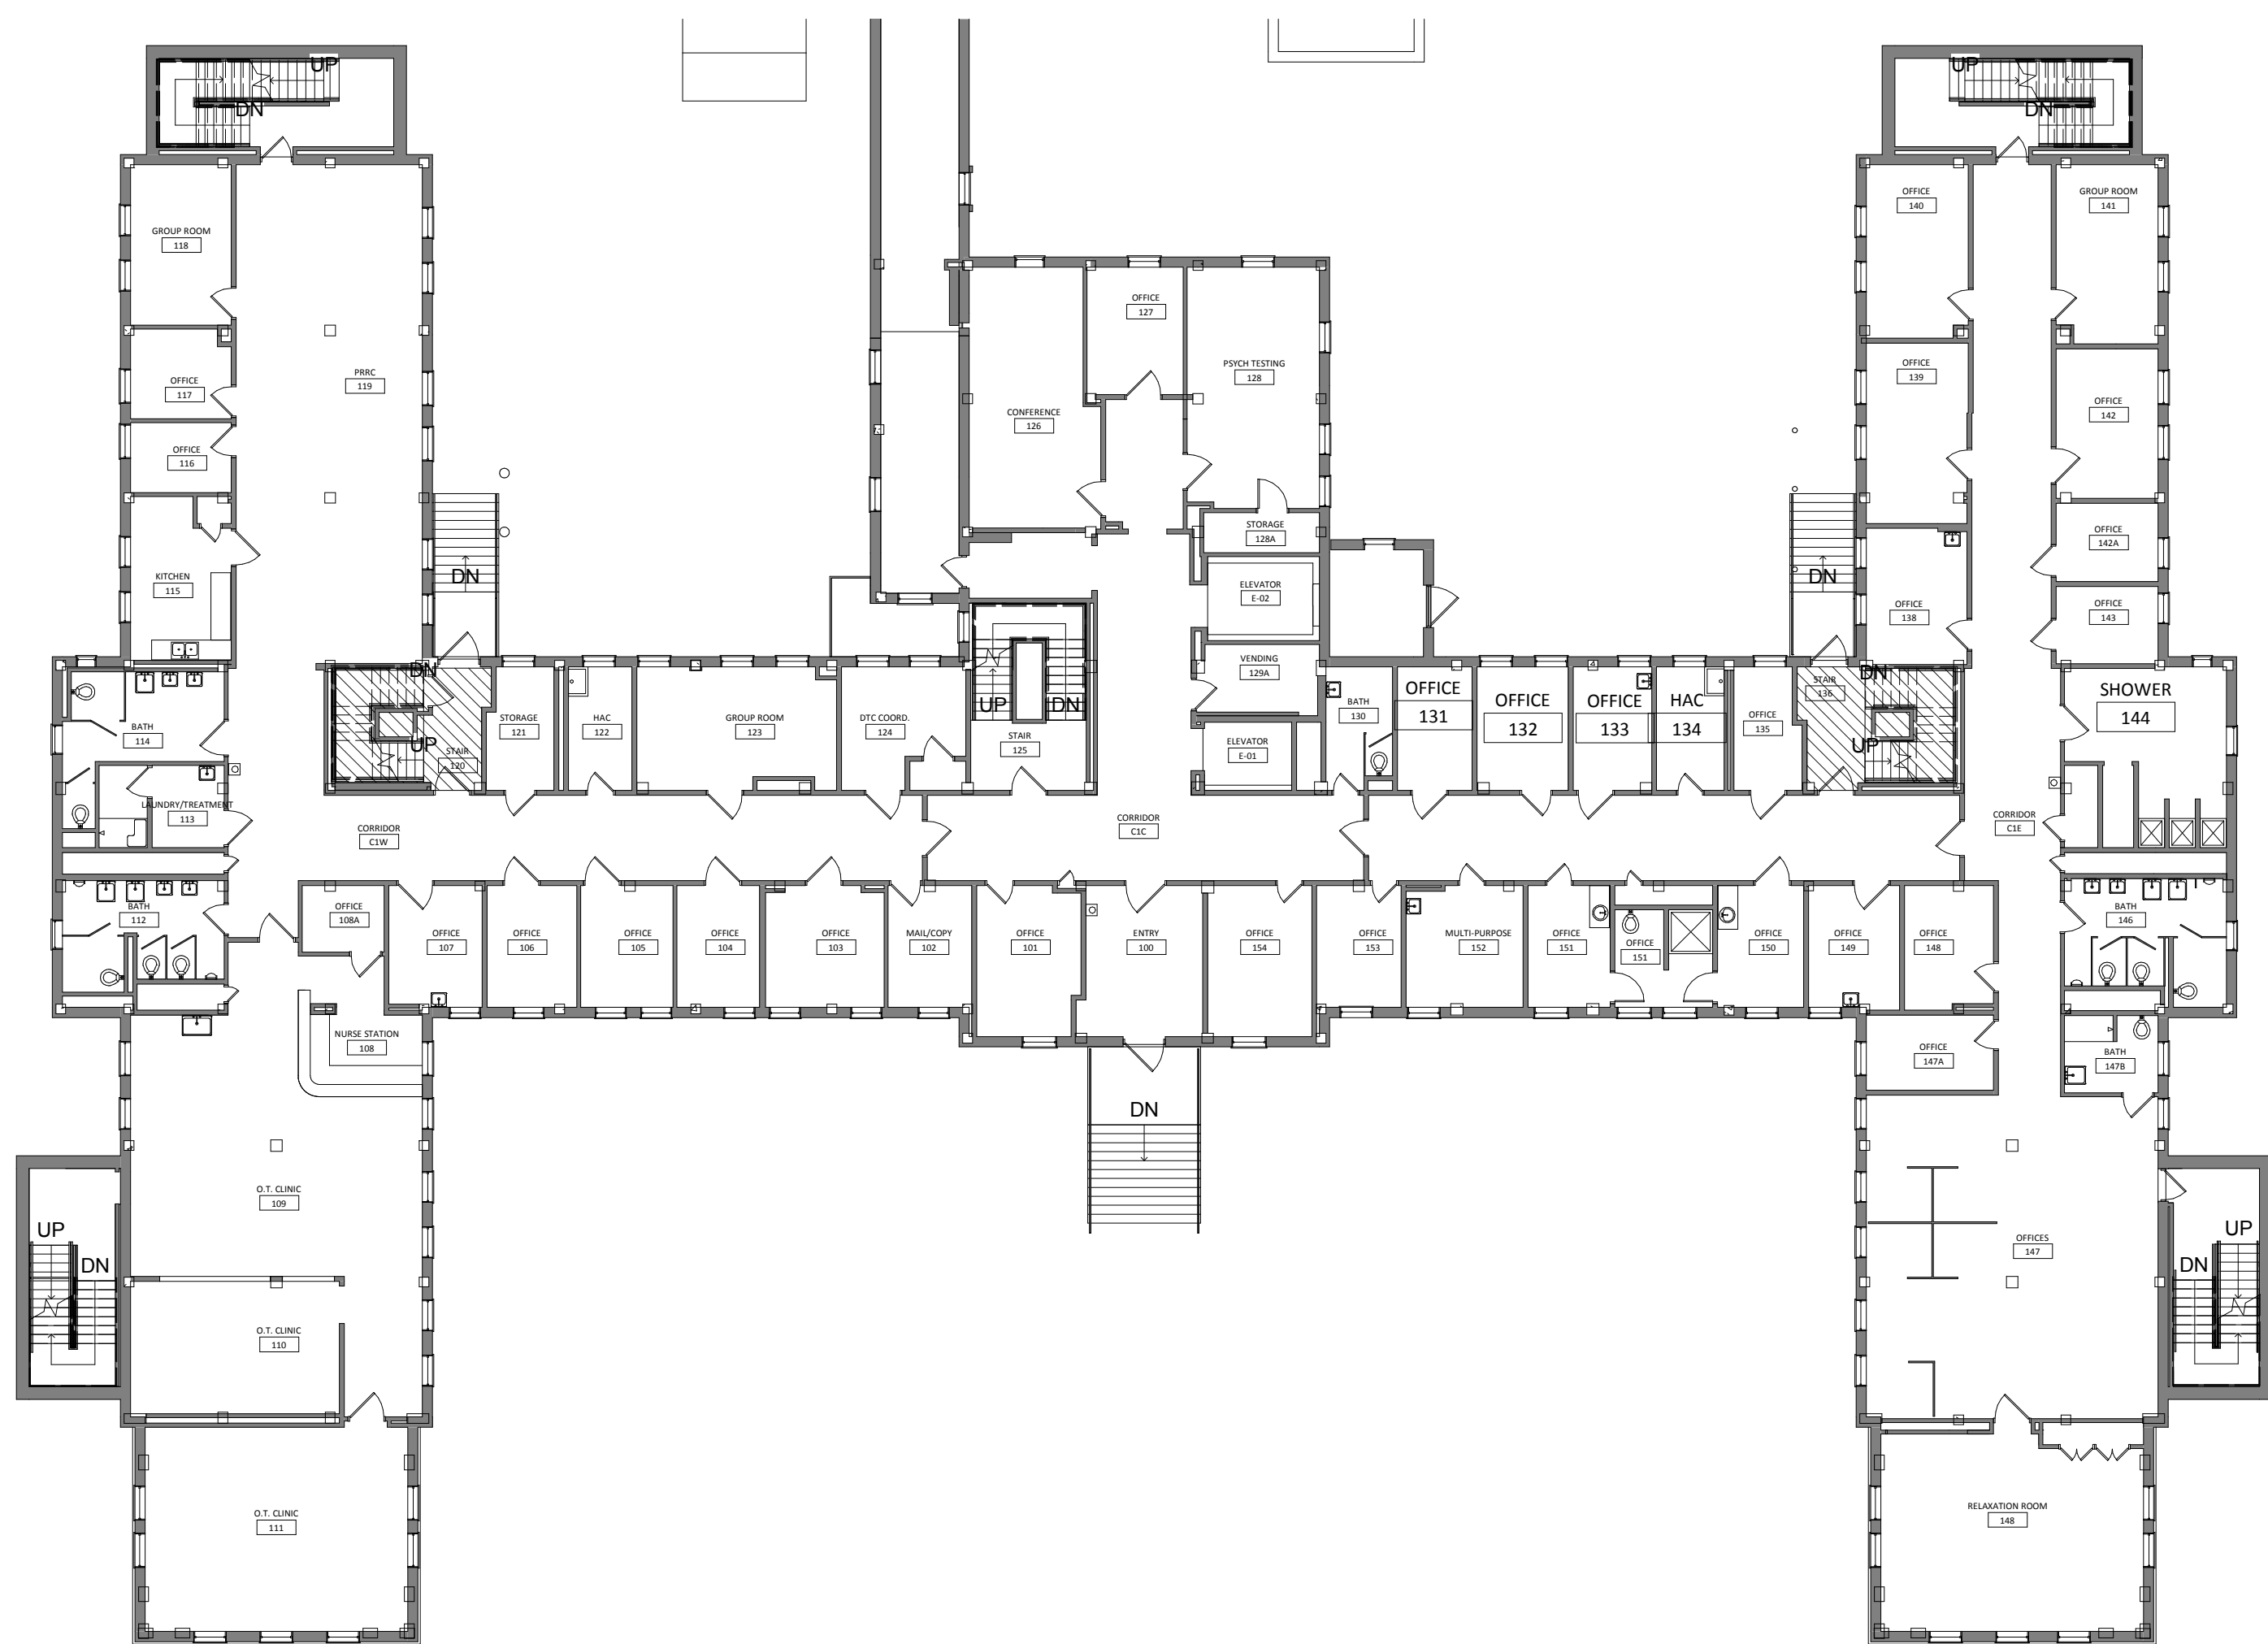

2 FIRST FLOOR PLAN - PHASING
1/16" = 1'-0"

ASBESTOS ABATEMENT LEGEND

- ASBESTOS CONTAINING MASTIC UNDER 12"x12" FLOOR TILE
- SYMBOL INDICATES LOCATION OF EXIST. CONVECTOR HEATER WITH TRANSITE PANEL TO BE ABATED.

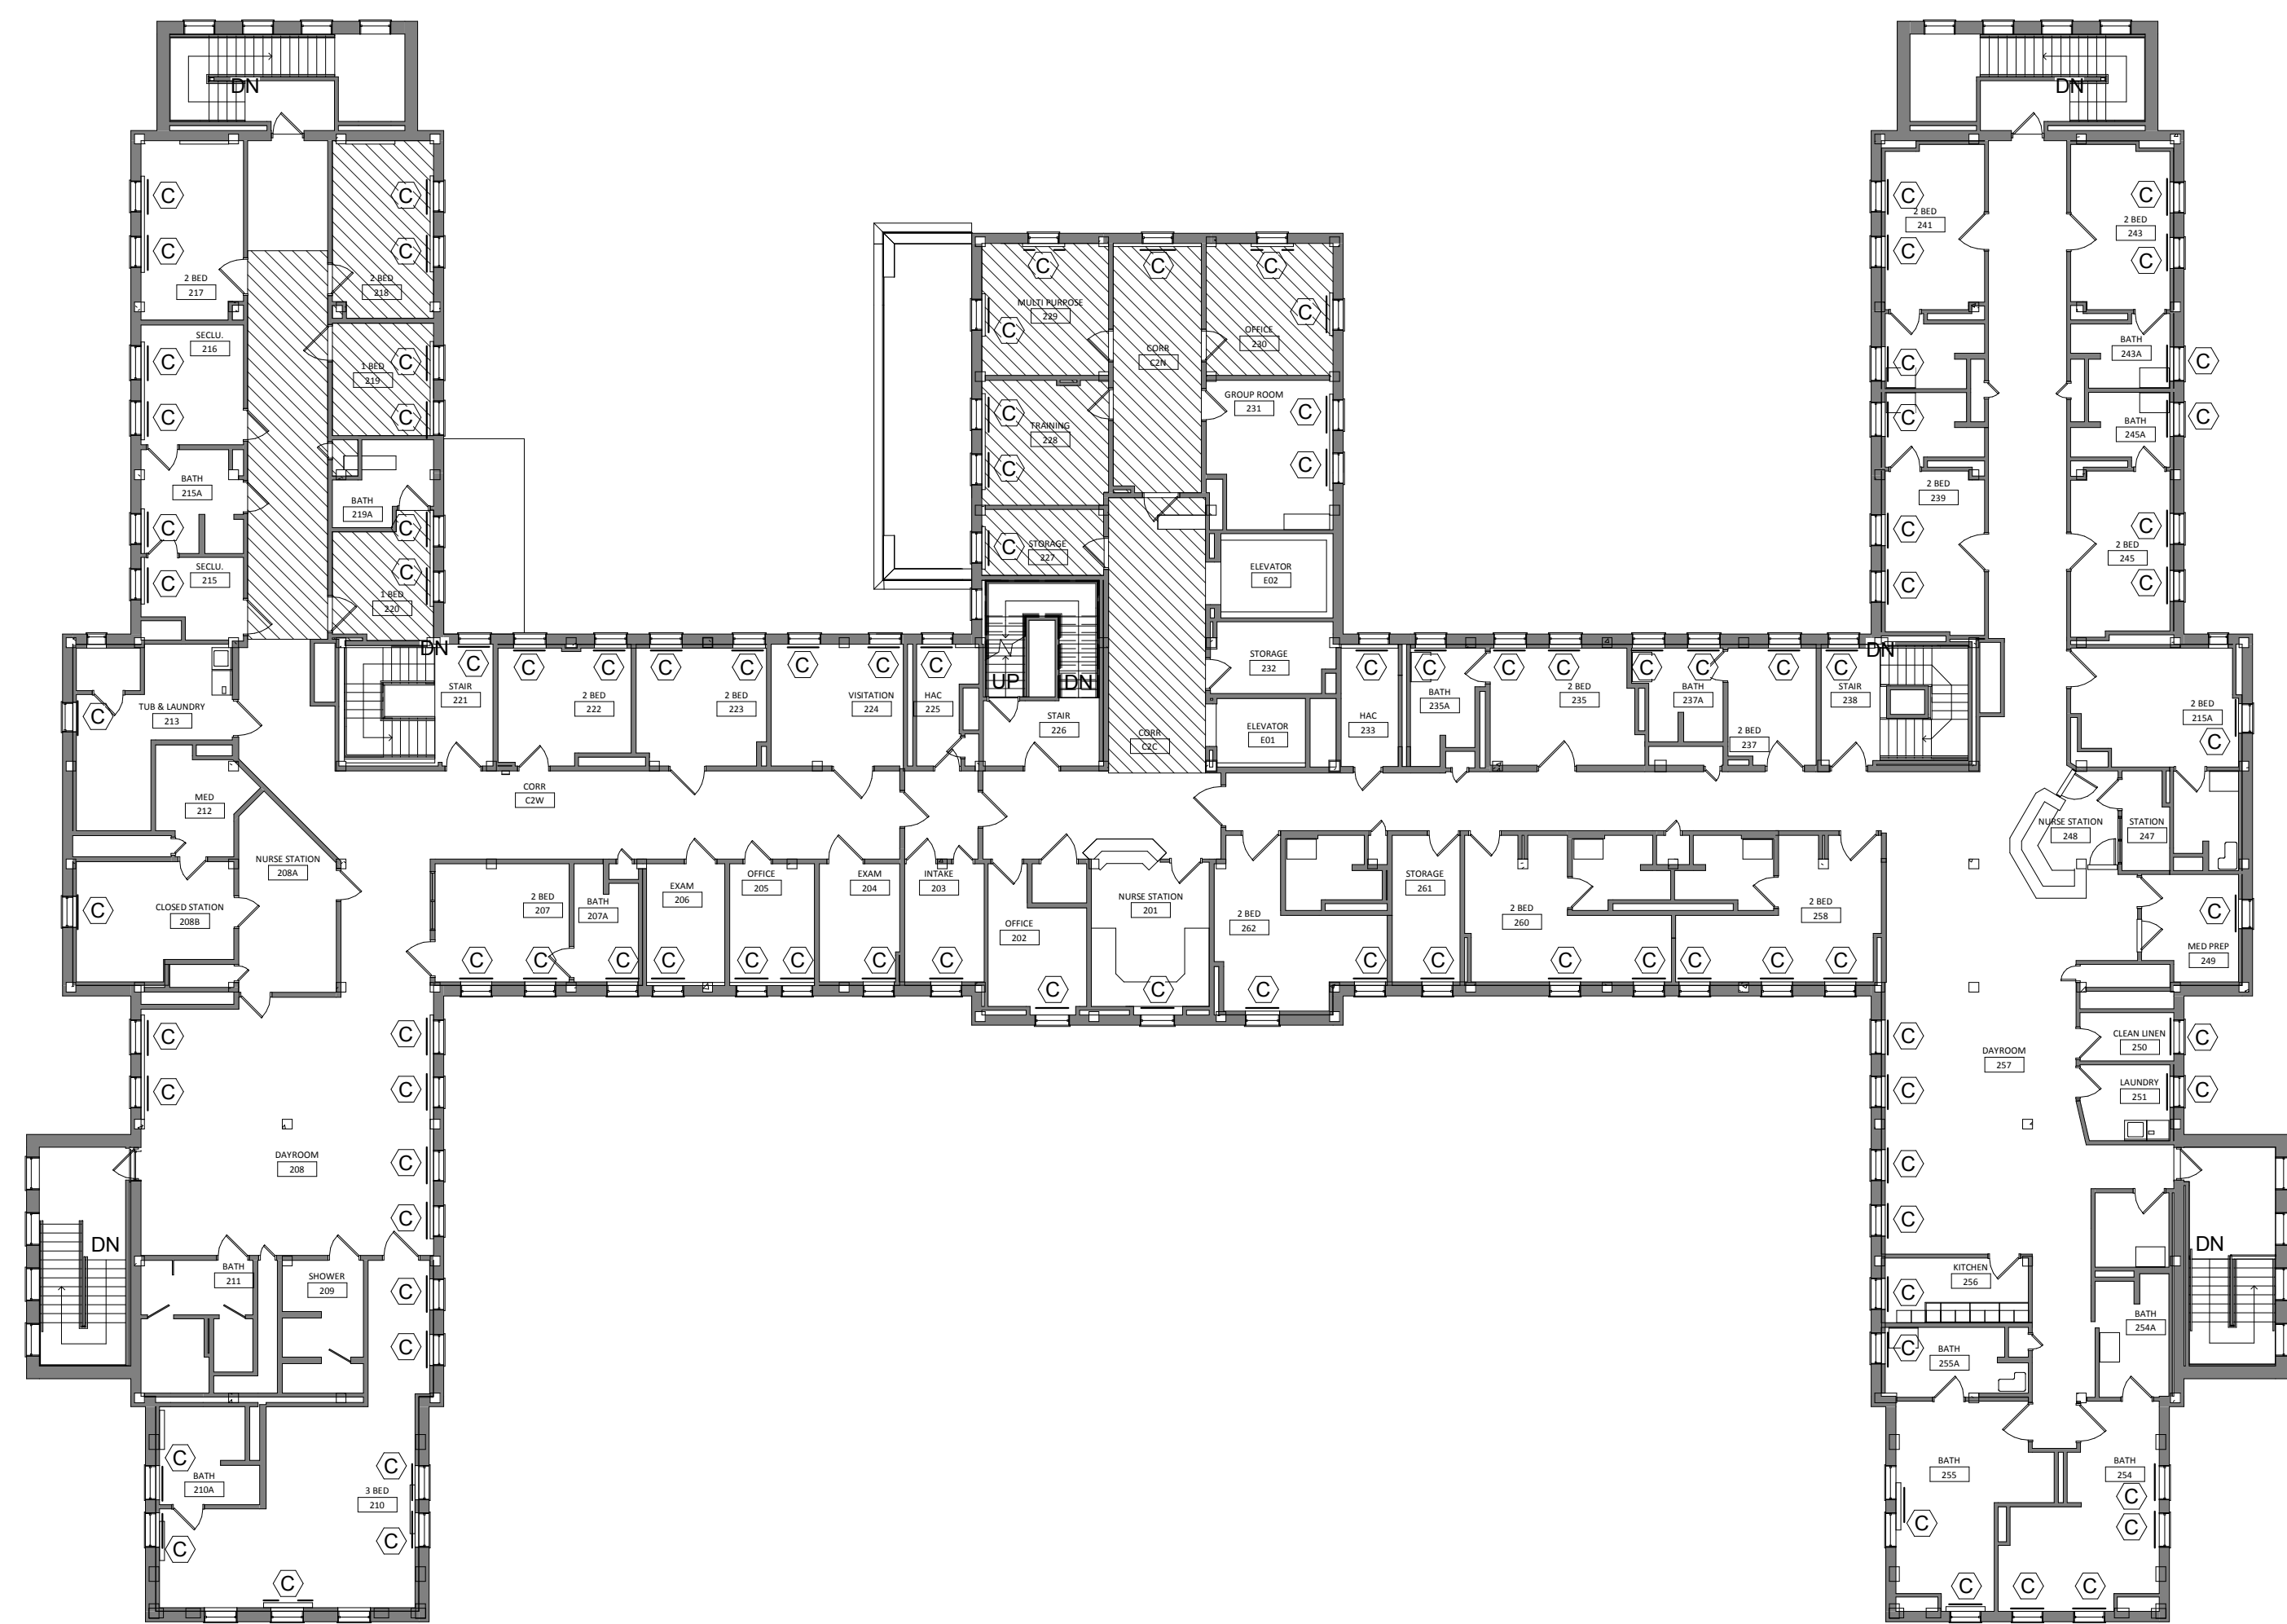

1 SECOND FLOOR PLAN - PHASING
1/16" = 1'-0"

100% CD SET

FOR CONSTRUCTION

NO	REVISION	DATE

VA FORM 08-6231



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Alexandria, MN 56308
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facsimile 320.759.9062
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STAMPED:
DANIEL J. MILLER, AIA
DATE: 12-20-2013
MIN. 08-19
REG. NO.

DRAWING TITLE
ABATEMENT PLANS

PROJECT TITLE
RECONFIGURE/EXPAND
BUILDINGS 28 & 9 FOR
RESIDENTIAL REHABILITATION
TREATMENT PROGRAM

BUILDING No. 28
CHECKED BY DJM
DRAWN ADB

LOCATION
ST. CLOUD VA MEDICAL CENTER
ST. CLOUD, MN 56303


DATE
12.20.13
FIRST SCALE
AS NOTED
PROJECT NO.
656-12-339

DWG FILE

DRAWING NO.
HA100



three eighths inch = one foot
one eighth inch = one foot
one quarter inch = one foot
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one hundred inches = one foot

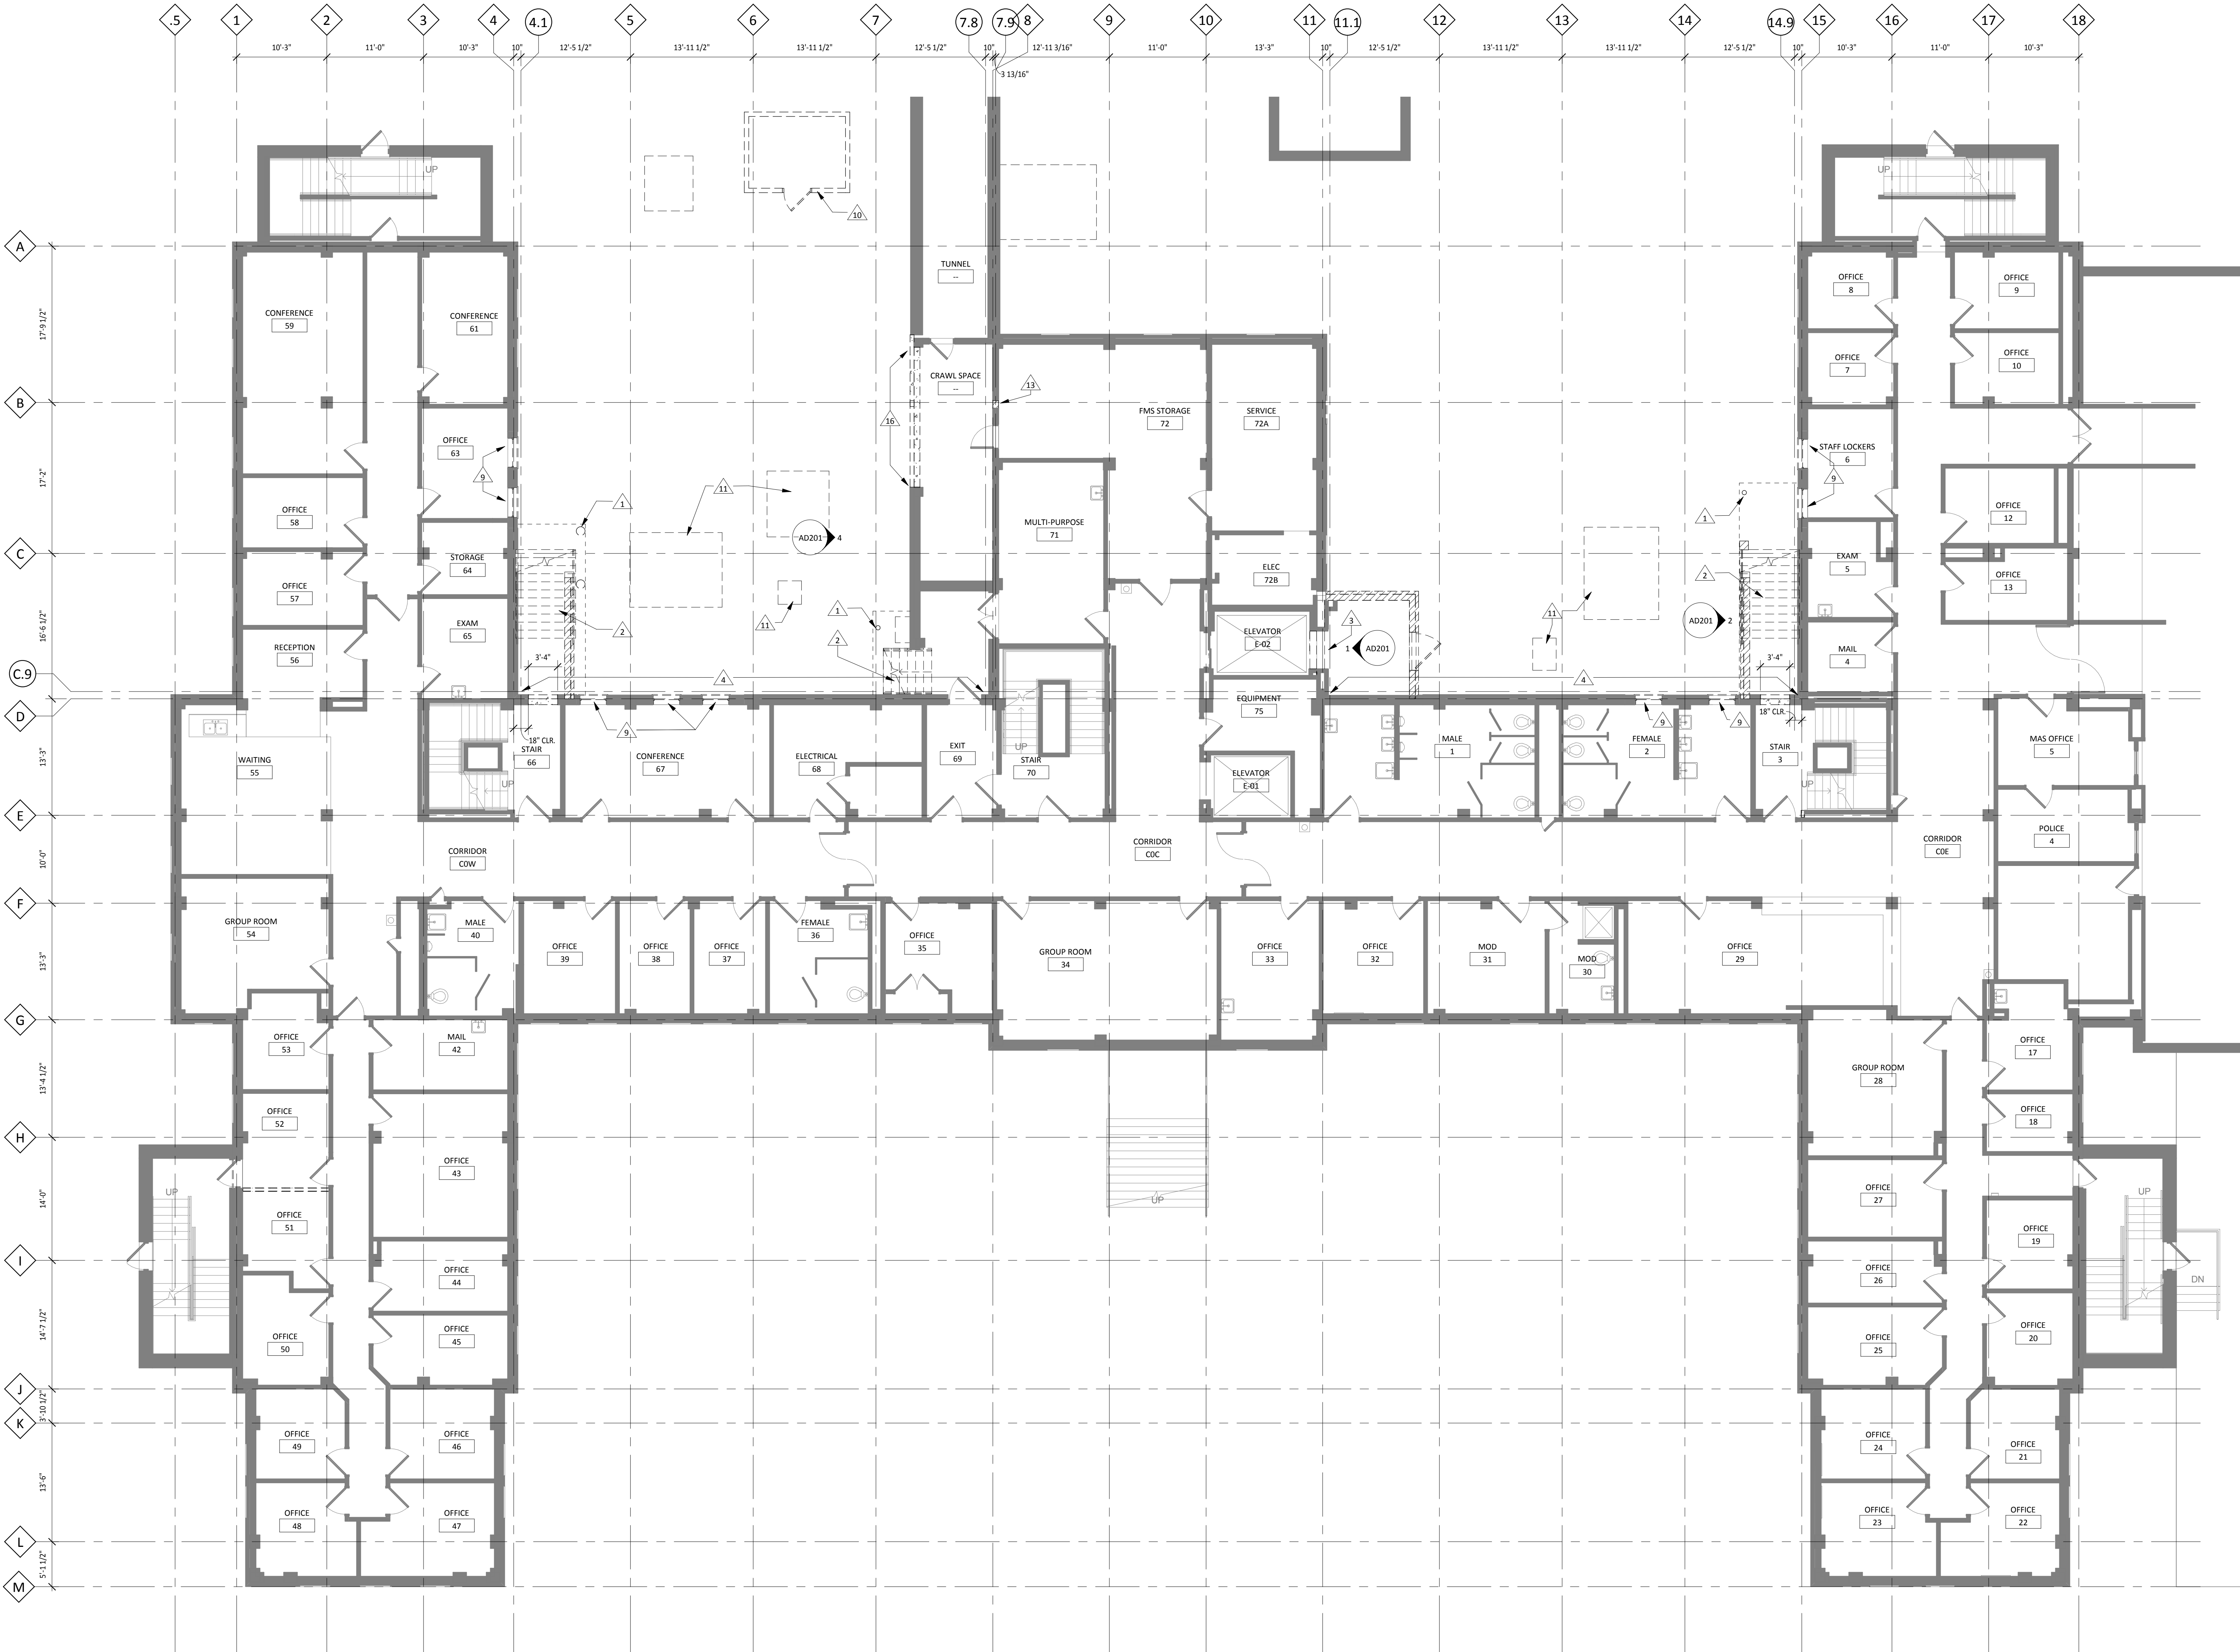

1 BASEMENT DEMOLITION PLAN
1/8" = 1'-0"

DEMOLITION KEYNOTES	
NO.	NOTE
1	DEMOLITION EXISTING CANOPY ABOVE INCLUDING COLUMNS, FOOTINGS, AND ANY OTHER ASSOCIATED ELEMENTS
2	DEMOLITION EXISTING STAIRS AT THIS LEVEL
3	DEMOLITION EXISTING ELEVATOR DOOR AT GRADE. INSTALL NEW ELEVATOR DOOR AT BASEMENT LEVEL
4	DEMOLITION FACE BRICK - BACK UP TO REMAIN
5	NOT USED.
6	EXISTING CASEWORK TO BE DEMOLISHED
7	DEMOLITION FACE BRICK & BACK UP MASONRY. CONCRETE STRUCTURE TO REMAIN.
8	DEMOLITION EXIST. ROOF, GUTTER, CORNICE, FASCIA.
9	DEMOLITION EXISTING WINDOW. INFILL WITH CMU BLOCK, MTL STUDS AND GWB. PATCH TO MATCH EXISTING INTERIOR. REF. TO DETAIL 12/AS501. SALVAGE AND GIVE WINDOW SASHES TO VA.
10	EXISTING OUTBUILDING TO BE REMOVED - SEE SITE PLAN
11	EXISTING CONCRETE EQUIPMENT PAD TO BE DEMOLISHED
12	DEMOLITION PORTION OF WALL FOR NEW DOOR OPENING, COORDINATE WITH DOOR SCHEDULE.
13	DEMOLITION PORTION OF WALL FOR NEW STEEL INFILL COLUMN. SEE STRUCT.
14	DEMOLITION NEW PENETRATION IN FLOOR FOR MECH. EQUIPMENT. COORDINATE LOCATIONS WITH MECHANICAL AND EXIST. CONCRETE STRUCTURE
15	TEMPORARY DOOR OPENING. REFER TO PHASING PLAN
16	DEMOLITION EXISTING GRADE BEAM AND MASONRY WALL FROM GRADE BEAM UP TO LEVEL 1. CONSTRUCT NEW FOUNDATION WALL AND INFILL MASONRY WALL TO MATCH EXISTING. REF. TO STRUCTURAL.
17	REMOVE EXISTING ACT CEILING AS REQUIRED, SALVAGE FOR RE-USE. ALL EXISTING LIFE SAFETY SYSTEMS TO REMAIN FULLY FUNCTIONAL DURING CONSTRUCTION. REINSTALL CEILING FOLLOWING COMPLETION OF WORK IN AREA.
18	DEMOLITION EXISTING GWB CEILING. ALL EXISTING LIFE SAFETY SYSTEMS TO REMAIN FULLY FUNCTIONAL DURING CONSTRUCTION.
19	DEMOLITION OPENING IN ROOF FOR NEW DUCTWORK. COORDINATE SIZE AND LOCATION WITH MECH. REFER TO STRUCT. FOR FRAMING.

DEMOLITION GENERAL NOTES

- THE OWNER'S NORMAL OPERATIONS WILL BE CONTINUED DURING DEMOLITION. DEMOLITION CONTRACTOR SHALL NOT INTERFERE WITH THESE OPERATIONS IN ANY WAY WITHOUT THE OWNER'S EXPRESSED CONSENT.
- OWNER WILL OCCUPY PORTIONS OF THE BUILDING IMMEDIATELY ADJACENT TO AREAS OF SELECTIVE DEMOLITION. CONDUCT SELECTIVE DEMOLITION WORK IN MANNER THAT WILL MINIMIZE NEED FOR DISRUPTION OF OWNER'S NORMAL OPERATIONS. REFER TO SPECIFICATIONS FOR MINIMUM ADVANCE NOTICE TO OWNER.
- PROVIDE TEMPORARY BARRICADES AND OTHER FORMS OF PROTECTION TO PROTECT OWNER'S PERSONNEL AND GENERAL PUBLIC FROM INJURY DUE TO SELECTIVE DEMOLITION WORK. REFER TO PHASING SHEET FOR MORE INFORMATION.
- PROVIDE 1 - HOUR FIRE RESISTANT CONSTRUCTION BARRIERS WHERE REQ'D TO PROTECT EXISTING CONSTRUCTION AND OWNER'S OPERATIONS.
- PROTECT FROM DAMAGE EXISTING FINISH WORK THAT IS TO REMAIN IN PLACE AND BECOME EXPOSED DURING DEMOLITION OPERATIONS.
- PROTECT FLOORS WITH SUITABLE COVERING WHEN NECESSARY.
- COVER AND PROTECT FURNITURE, EQUIPMENT, AND FIXTURES FROM SOLAGE OR DAMAGE WHEN DEMOLITION WORK IS PERFORMED IN AREAS WHERE SUCH ITEMS HAVE NOT BEEN REMOVED.
- PRIOR TO CUTTING EXISTING CONSTRUCTION, LOCATE AND IDENTIFY SERVICES TO REMAIN IN OPERATION, INCLUDING ALL FLOOR PENETRATIONS. UNDOCUMENTED CONDITIONS, UTILITY RISERS, ETC. AND ANY WALLS THAT CONTAIN LIFE SAFETY VERTICAL RISERS THAT MUST REMAIN IN OPERATION DURING THE DEMOLITION WORK.
- CONTRACTOR SHALL VERIFY ALL EXISTING BUILDING DIMENSIONS, PARTITION AND WALL LOCATIONS AND FLOOR ELEVATIONS IN FIELD AND NOTIFY THE OWNER'S REPRESENTATIVE OF ANY DISCREPANCIES BEFORE THE START OF WORK.
- WHEN UNANTICIPATED MECHANICAL, ELECTRICAL, OR STRUCTURAL ELEMENTS THAT CONFLICT WITH INTENDED FUNCTION OF DESIGN ARE ENCOUNTERED, INVESTIGATE AND MEASURE BOTH NATURE AND EXTENT OF THE CONFLICT AND NOTIFY OWNER'S REPRESENTATIVE.
- MAINTAIN EXISTING UTILITIES INDICATED TO REMAIN IN SERVICE AND PROTECT THEM AGAINST DAMAGE DURING DEMOLITION OPERATIONS. DO NOT INTERRUPT UTILITIES SERVING OCCUPIED OR USED FACILITIES, EXCEPT WHEN AUTHORIZED IN WRITING BY AUTHORITIES HAVING JURISDICTION.
- WHERE DEMOLITION IS REQ'D BEYOND THE LIMITS OF THE CONTRACT TO ROUTE NEW DUCTWORK, PIPING, CONDUITS ETC., RATED WALLS AND SMOKE BARRIERS SHALL BE PATCHED BY CONTRACTOR REQUIRING PENETRATIONS, ALL FINISHES DAMAGED BY THE WORK SHALL BE RESTORED TO THEIR ORIGINAL CONDITION.
- REPAIR DEMOLITION PERFORMED IN EXCESS OF THAT REQ'D. RETURN ELEMENTS OF CONSTRUCTION AND SURFACES TO REMAIN, TO THE CONDITION EXISTING PRIOR TO START OF OPERATIONS. REPAIR ADJACENT CONSTRUCTION OR SURFACES SOILED OR DAMAGED BY SELECTIVE DEMOLITION.
- PROVIDE SHORING, BRACING AND ANY OTHER MEANS REQ'D TO PROTECT AND MAINTAIN THE SAFETY, INTEGRITY AND STABILITY OF ALL EXISTING AND NEW CONSTRUCTION.
- WHEN ROOFING, GLAZING, FLASHING, COPING OR PORTIONS OF EXTERIOR WALLS ARE REMOVED OR OPENED, SUITABLE WEATHER PROTECTION SHALL BE PROVIDED AND MAINTAINED FOR THE DURATION OF WORK.
- REMOVAL OF ITEMS NOTED INCLUDES REMOVAL OF ANCHORS, ADHESIVES, HARDWARE, CONDUIT, WIRE, PIPING, ETC. FOR A COMPLETE REMOVAL OF THE ITEMS OR SYSTEMS.
- WHEREVER WATER CLOSETS, FLOOR SINKS OR OTHER EQUIPMENT AND RELATED PIPING ARE TO BE REMOVED, PATCH FLOOR SLAB W/ CONCRETE AS REQUIRED.
- ALL CONCRETE FLOOR SLABS NOT TO BE REMOVED SHALL BE SAWCUT TO PROVIDE A NEAT JOINT. REF. TO UNIT PLAN SHEET AS111 FOR MORE INFORMATION ON SLAB DEMOLITION AT NEW PATIENT UNIT TOILET ROOMS.
- SEE MECHANICAL, CIVIL, AND ELECTRICAL DEMOLITION DRAWINGS FOR ADDITIONAL SCOPE OF DEMOLITION WORK.
- SALVAGE ALL EXISTING REMOVED BRICK FOR PATCHING AND FINISH WORK AS REQ'D - TYPICAL.
- DEMOLITION OF ANY EXISTING CONSTRUCTION SHALL INCLUDE WHAT IS NECESSARY AND REQ'D TO ACCOMMODATE THE REQUIREMENTS OF NEW CONSTRUCTION. REFER TO THE APPROPRIATE DRAWINGS AS TO THE EXTENT OF NEW CONSTRUCTION TO REMAIN.
- SURFACES SHALL BE CLEANED AND PREPPED WITHIN THE NEW MATERIALS GUIDELINES OF INSTALLATION OF THEIR PRODUCT IN EXISTING CONSTRUCTION.
- ALL DEMOLITION SHALL COMPLY WITH APPLICABLE LOCAL CODES AND STATE CODES AND ORDINANCES.

100% CD SET FOR CONSTRUCTION

NO.	REVISION	DATE

VA FORM 28-6231



JLG 11129


STAMPED:
I HAVE REVIEWED THIS PLAN AND APPROVE IT FOR CONSTRUCTION. I AM AN ARCHITECT REGISTERED IN THE STATE OF MINNESOTA.
DANIEL J. MILLER, AIA
DATE: 12-20-2013
REG. NO. 12-20-2013

DRAWING TITLE
BASEMENT DEMOLITION PLAN
PROJECT TITLE
RECONFIGURE/EXPAND BUILDINGS 28 & 9 FOR RESIDENTIAL REHABILITATION TREATMENT PROGRAM
BUILDING No. 28
DESIGNED BY DJM
DRAWN BY ADB
DATE: 12-20-2013
REG. NO. 12-20-2013

DATE 12.20.13
PROJECT NO. 656-12-339
DRAWING NO. AD100
LOCATION: ST. CLOUD VA MEDICAL CENTER ST. CLOUD, MN 56303



three eighths inch = one foot
one eighth inch = one foot
one quarter inch = one foot
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one hundred inches = one foot

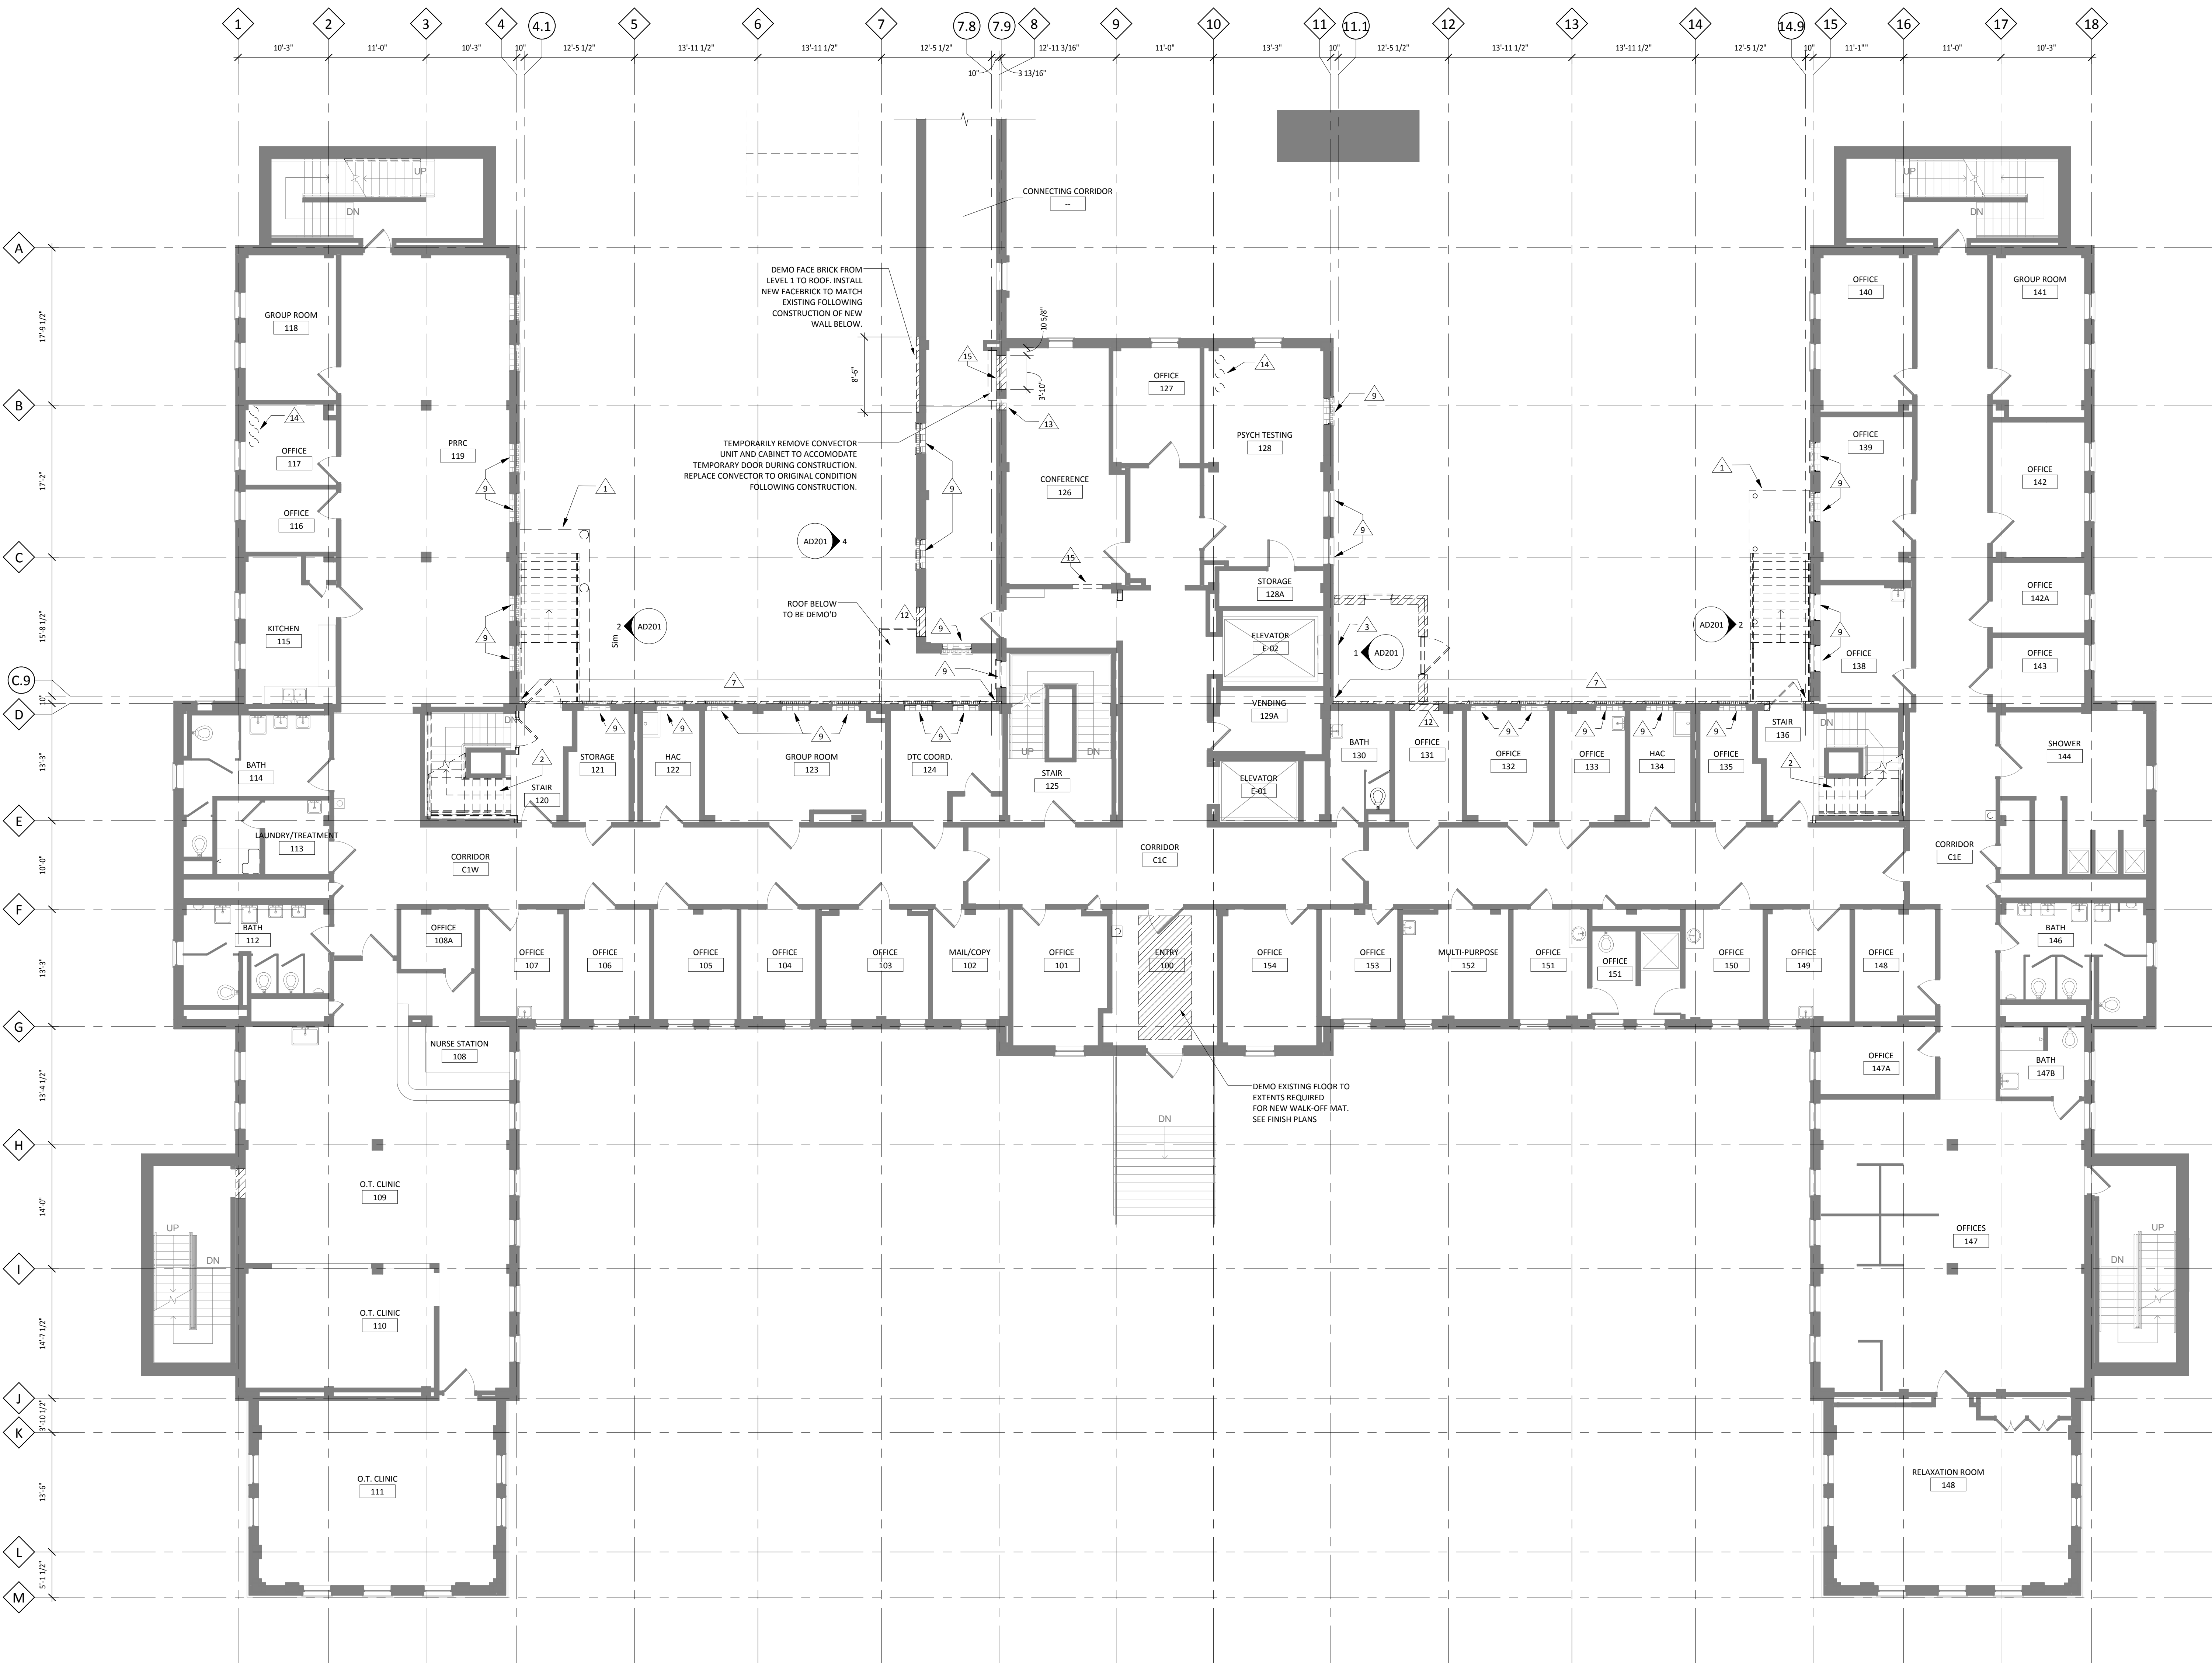

1 FIRST FLOOR DEMOLITION PLAN
1/8" = 1'-0"

DEMOLITION KEYNOTES	
NO.	NOTE
1	DEMOLITION EXISTING CANOPY ABOVE INCLUDING COLUMNS, FOOTINGS, AND ANY OTHER ASSOCIATED ELEMENTS
2	DEMOLITION EXISTING STAIRS AT THIS LEVEL
3	DEMOLITION EXISTING ELEVATOR DOOR AT GRADE. INSTALL NEW ELEVATOR DOOR AT BASEMENT LEVEL
4	DEMOLITION FACE BRICK - BACK UP TO REMAIN
5	NOT USED.
6	EXISTING CASEWORK TO BE DEMOLITION
7	DEMOLITION FACE BRICK & BACK UP MASONRY. CONCRETE STRUCTURE TO REMAIN.
8	DEMOLITION EXIST. ROOF, GUTTER, CORNICE, FASCIA.
9	DEMOLITION EXISTING WINDOW. INFILL WITH CMU BLOCK, MTL STUDS AND GWB. PATCH TO MATCH EXISTING INTERIOR. REF. TO DETAIL 12/AS501. SALVAGE AND GIVE WINDOW SASHES TO VA.
10	EXISTING OUTBUILDING TO BE REMOVED - SEE SITE PLAN
11	EXISTING CONCRETE EQUIPMENT PAD TO BE DEMOLISHED
12	DEMOLITION PORTION OF WALL FOR NEW DOOR OPENING, COORDINATE WITH DOOR SCHEDULE.
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14	DEMOLITION NEW PENETRATION IN FLOOR FOR MECH. EQUIPMENT. COORDINATE LOCATIONS WITH MECHANICAL AND EXIST. CONCRETE STRUCTURE
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17	REMOVE EXISTING ACT CEILING AS REQUIRED. SALVAGE FOR RE-USE. ALL EXISTING LIFE SAFETY SYSTEMS TO REMAIN FULLY FUNCTIONAL DURING CONSTRUCTION. REINSTALL CEILING FOLLOWING COMPLETION OF WORK IN AREA.
18	DEMOLITION EXISTING GWB CEILING. ALL EXISTING LIFE SAFETY SYSTEMS TO REMAIN FULLY FUNCTIONAL DURING CONSTRUCTION.
19	DEMOLITION OPENING IN ROOF FOR NEW DUCTWORK. COORDINATE SIZE AND LOCATION WITH MECH. REFER TO STRUCT. FOR FRAMING.

DEMOLITION GENERAL NOTES	
A.	THE OWNER'S NORMAL OPERATIONS WILL BE CONTINUED DURING DEMOLITION. DEMOLITION CONTRACTOR SHALL NOT INTERFERE WITH THESE OPERATIONS IN ANY WAY WITHOUT THE OWNER'S EXPRESSED CONSENT.
B.	OWNER WILL OCCUPY PORTIONS OF THE BUILDING IMMEDIATELY ADJACENT TO AREAS OF SELECTIVE DEMOLITION. CONDUCT SELECTIVE DEMOLITION WORK IN MANNER THAT WILL MINIMIZE NEED FOR DISRUPTION OF OWNER'S NORMAL OPERATIONS. REFER TO SPECIFICATIONS FOR MINIMUM ADVANCE NOTICE TO OWNER.
C.	PROVIDE TEMPORARY BARRICADES AND OTHER FORMS OF PROTECTION TO PROTECT OWNER'S PERSONNEL AND GENERAL PUBLIC FROM INJURY DUE TO SELECTIVE DEMOLITION WORK. REFER TO PHASING SHEET FOR MORE INFORMATION.
D.	PROVIDE 1 - HOUR FIRE RESISTANT CONSTRUCTION BARRIERS WHERE REQ'D TO PROTECT EXISTING CONSTRUCTION AND OWNERS OPERATIONS.
E.	PROTECT FROM DAMAGE EXISTING FINISH WORK THAT IS TO REMAIN IN PLACE AND BECOME EXPOSED DURING DEMOLITION OPERATIONS.
F.	PROTECT FLOORS WITH SUITABLE COVERING WHEN NECESSARY.
G.	COVER AND PROTECT FURNITURE, EQUIPMENT, AND FIXTURES FROM SOILAGE OR DAMAGE WHEN DEMOLITION WORK IS PERFORMED IN AREAS WHERE SUCH ITEMS HAVE NOT BEEN REMOVED.
H.	PRIOR TO CUTTING EXISTING CONSTRUCTION, LOCATE AND IDENTIFY SERVICES TO REMAIN IN OPERATION, INCLUDING ALL FLOOR PENETRATIONS. UNDOCUMENTED CONDITIONS, UTILITY RISERS, ETC. AND ANY WALLS THAT CONTAIN LIFE SAFETY VERTICAL RISERS THAT MUST REMAIN IN OPERATION DURING THE DEMOLITION WORK.
J.	CONTRACTOR SHALL VERIFY ALL EXISTING BUILDING DIMENSIONS, PARTITION AND WALL LOCATIONS AND FLOOR ELEVATIONS IN FIELD AND NOTIFY THE OWNER'S REPRESENTATIVE OF ANY DISCREPANCIES BEFORE THE START OF WORK.
K.	WHEN UNANTICIPATED MECHANICAL, ELECTRICAL, OR STRUCTURAL ELEMENTS THAT CONFLICT WITH INTENDED FUNCTION OF DESIGN ARE ENCOUNTERED, INVESTIGATE AND MEASURE BOTH NATURE AND EXTENT OF THE CONFLICT AND NOTIFY OWNER'S REPRESENTATIVE.
L.	MAINTAIN EXISTING UTILITIES INDICATED TO REMAIN IN SERVICE AND PROTECT THEM AGAINST DAMAGE DURING DEMOLITION OPERATIONS. DO NOT INTERRUPT UTILITIES SERVING OCCUPIED OR USED FACILITIES, EXCEPT WHEN AUTHORIZED IN WRITING BY AUTHORITIES HAVING JURISDICTION.
M.	WHERE DEMOLITION IS REQ'D BEYOND THE LIMITS OF THE CONTRACT TO ROUTE NEW DUCTWORK, PIPING, CONDUITS ETC., RATED WALLS AND SMOKE BARRIERS SHALL BE PATCHED BY CONTRACTOR REQUIRING PENETRATIONS. ALL FINISHES DAMAGED BY THE WORK SHALL BE RESTORED TO THEIR ORIGINAL CONDITION.
N.	REPAIR DEMOLITION PERFORMED IN EXCESS OF THAT REQ'D. RETURN ELEMENTS OF CONSTRUCTION AND SURFACES TO REMAIN, TO THE CONDITION EXISTING PRIOR TO START OF OPERATIONS. REPAIR ADJACENT CONSTRUCTION OR SURFACES SOILED OR DAMAGED BY SELECTIVE DEMOLITION.
P.	PROVIDE SHORING, BRACING AND ANY OTHER MEANS REQ'D TO PROTECT AND MAINTAIN THE SAFETY, INTEGRITY AND STABILITY OF ALL EXISTING AND NEW CONSTRUCTION.
Q.	WHEN ROOFING, GLAZING, FLASHING, COPING OR PORTIONS OF EXTERIOR WALLS ARE REMOVED OR OPENED, SUITABLE WEATHER PROTECTION SHALL BE PROVIDED AND MAINTAINED FOR THE DURATION OF WORK.
R.	REMOVAL OF ITEMS NOTED INCLUDES REMOVAL OF ANCHORS, ADHESIVES, HARDWARE, CONDUIT, WIRE, PIPING, ETC. FOR A COMPLETE REMOVAL OF THE ITEMS OR SYSTEMS.
S.	WHEREVER WATER CLOSETS, FLOOR SINKS OR OTHER EQUIPMENT AND RELATED PIPING ARE TO BE REMOVED, PATCH FLOOR SLAB W/ CONCRETE AS REQUIRED.
T.	ALL CONCRETE FLOOR SLABS NOTED TO BE REMOVED SHALL BE SAWCUT TO PROVIDE A NEAT JOINT. REF. TO UNIT PLAN SHEET AS111 FOR MORE INFORMATION ON SLAB DEMOLITION AT NEW PATIENT UNIT TOILET ROOMS.
U.	SEE MECHANICAL, CIVIL, AND ELECTRICAL DEMOLITION DRAWINGS FOR ADDITIONAL SCOPE OF DEMOLITION WORK.
V.	SALVAGE ALL EXISTING REMOVED BRICK FOR PATCHING AND REFINISH WORK AS REQ'D - TYPICAL.
W.	DEMOLITION OF ANY EXISTING CONSTRUCTION SHALL INCLUDE WHAT IS NECESSARY AND REQ'D TO ACCOMMODATE THE REQUIREMENTS OF NEW CONSTRUCTION. REFER TO THE APPROPRIATE DRAWINGS AS TO THE EXTENT OF NEW CONSTRUCTION TO REMAIN.
X.	SURFACES SHALL BE CLEANED AND PREPPED WITHIN THE NEW MATERIALS GUIDELINES OF INSTALLATION OF THEIR PRODUCT IN EXISTING CONSTRUCTION.
Y.	ALL DEMOLITION SHALL COMPLY WITH APPLICABLE LOCAL CODES AND STATE CODES AND ORDINANCES.

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No. REVISION DATE		JLG architects Alexandria 525 Broadway Street Alexandria, MN 56308 phone 320.759.9300 facsimile 320.759.9302 www.jlgarchitects.com copyright © 2013		STAMPED: 12.20.2013 RECONSTRUCTED/EXPAND BUILDINGS 28 & 9 FOR RESIDENTIAL REHABILITATION TREATMENT PROGRAM PROJECT NO. 656-12-339		DATE 12.20.2013		St. Cloud VA Health Care System Brainerd Montevideo Alexandria	
JLG 11129		DANIEL J. MILLER, AIA REG. NO. 12.20.2013		DRAWING NO. 12.20.2013		DRAWING NO. 12.20.2013		DRAWING NO. 12.20.2013	
LOCATION: ST. CLOUD VA MEDICAL CENTER ST. CLOUD, MN 56303		DRAWING NO. 12.20.2013		DRAWING NO. 12.20.2013		DRAWING NO. 12.20.2013		DRAWING NO. 12.20.2013	

MATERIALS ABBREVIATIONS		ACTION SPECIFIERS	
ACT	ACQUISITION, CEILING TILE	1	EXIST. PARTITION, PARTITION PATCH TO MATCH EXISTING PATCH TO MATCH EXISTING PATCH FOR NEW FINISH
CON	CONCRETE, CONCRETE TIE	2	REMOVE FINISH ONLY, SUBSTRATE TO REMAIN
CMU	CONCRETE MASONRY UNIT	3	EXIST. PARTITION AND FINISH TO BE REMOVED ARE DESIGNATED WITH DASHED LINES
CPT	CARPET	4	REMOVE EXIST. CEILING
GP	GLASS	5	REMOVE EXIST. FINISH AND SUBSTRATE
EXP	EXPOSED STRUCTURE		
CLB	CLAY BOARD		
WLB	WOOD LAMBER BOARD		
PL	PLASTER		
SV	SHINY VINYL		
TR	TERAZZO		
CTE	CERAMIC TILE		
NUM	NUMBER		
NC	NON-CURABLE		

CEILING

WALL FINISH


BASE FINISH

FLOOR FINISH

ACTION SPECIFIER

INDICATES EXISTING PARTITIONS AND FINISHES TO REMAIN UNDER DEDUCT ALTERNATE. SEE A131

INDICATES DEMO OF EXIST. CONCRETE TOPPING IN LOCATIONS OF NEW UNIT BATHROOMS. SEE UNIT PLANS AND SECOND FLOOR PLAN.

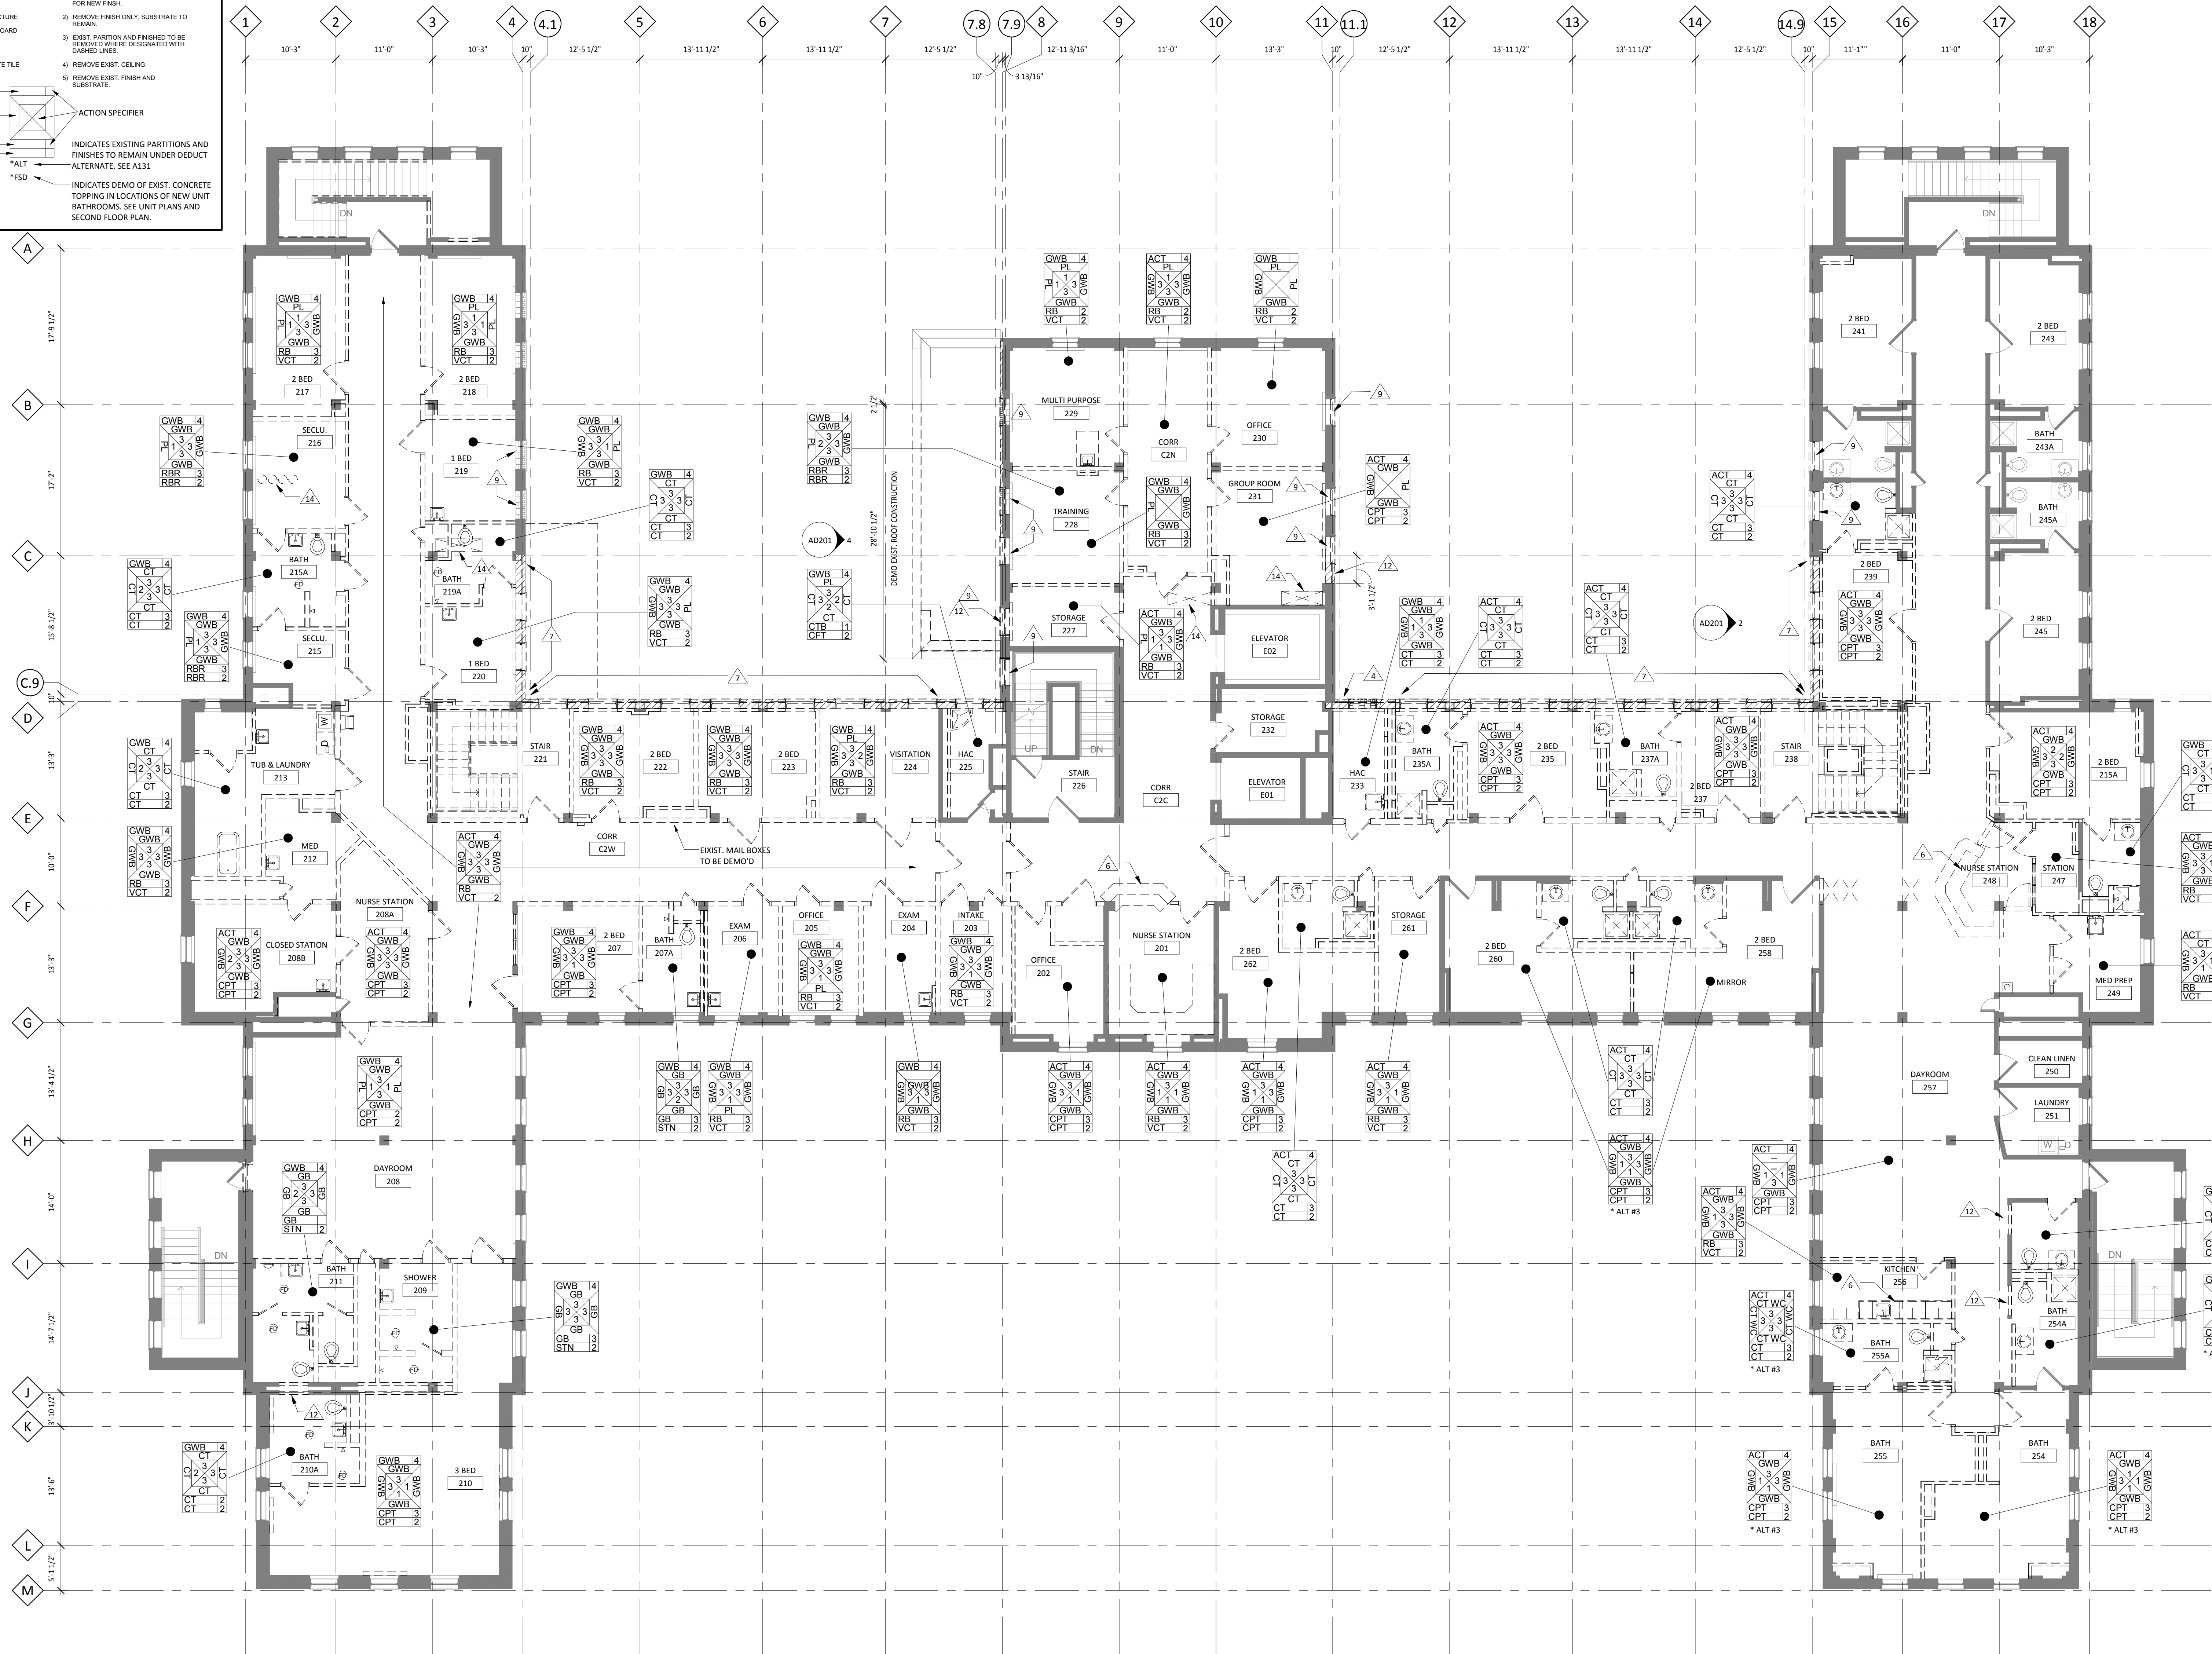

1 SECOND FLOOR DEMOLITION PLAN
1/8" = 1'-0"

*NOTE: PROVIDE CUTTING AND PATCHING IN EXISTING WALLS FOR ALL NEW ELECTRICAL WORK AND WORK PERTAINING TO THE INSTALLATION OF NEW MECHANICAL CONVETORS. REFER TO MECH. & ELEC. DRAWINGS FOR LOCATIONS.

DEMO PLAN KEYNOTES	
NO.	NOTE
1	DEMO EXISTING CANOPY ABOVE INCLUDING COLUMNS, FOOTINGS, AND ANY OTHER ASSOCIATED ELEMENTS
2	DEMO EXISTING STAIRS AT THIS LEVEL
3	DEMO EXISTING ELEVATOR DOOR AT GRADE. INSTALL NEW ELEVATOR DOOR AT BASEMENT LEVEL
4	DEMO FACE BRICK - BACK UP TO REMAIN
5	NOT USED.
6	EXISTING CASEWORK TO BE DEMO'D
7	DEMO FACE BRICK & BACK UP MASONRY. CONCRETE STRUCTURE TO REMAIN.
8	DEMO EXIST. ROOF, GUTTER, CORNICE, FASCIA.
9	DEMO EXISTING WINDOW. INFILL WITH CMU BLOCK, MTL STUDS AND GWB. PATCH TO MATCH EXISTING INTERIOR. REF. TO DETAIL 12/AS511. SALVAGE AND GIVE WINDOW SASHES TO VA.
10	EXISTING OUTBUILDING TO BE REMOVED - SEE SITE PLAN
11	EXISTING CONCRETE EQUIPMENT PAD TO BE DEMOLISHED
12	DEMO PORTION OF WALL FOR NEW DOOR OPENING, COORDINATE WITH DOOR SCHEDULE.
13	DEMO PORTION OF WALL FOR NEW STEEL INFILL COLUMN. SEE STRUCT.
14	DEMO NEW PENETRATION IN FLOOR FOR MECH. EQUIPMENT. COORDINATE LOCATIONS WITH MECHANICAL AND EXIST. CONCRETE STRUCTURE
15	TEMPORARY DOOR OPENING. REFER TO PHASING PLAN
16	DEMO EXISTING GRADE BEAM AND MASONRY WALL FROM GRADE BEAM UP TO LEVEL 1. CONSTRUCT NEW FOUNDATION WALL AND INFILL MASONRY WALL TO MATCH EXISTING. REF. TO STRUCTURAL.
17	REMOVE EXISTING AC CEILING AS REQUIRED, SALVAGE FOR RE-USE. ALL EXISTING LIFE SAFETY SYSTEMS TO REMAIN FULLY FUNCTIONAL DURING CONSTRUCTION. REINSTALL CEILING FOLLOWING COMPLETION OF WORK IN AREA.
18	DEMO EXISTING GWB CEILING. ALL EXISTING LIFE SAFETY SYSTEMS TO REMAIN FULLY FUNCTIONAL DURING CONSTRUCTION.
19	DEMO OPENING IN ROOF FOR NEW DUCTWORK. COORDINATE SIZE & LOCATION WITH MECH. REFER TO STRUCT. FOR FRAMING.
<h2 style="text-align: center;">DEMOLITION GENERAL NOTES</h2>	
A.	THE OWNER'S NORMAL OPERATIONS WILL BE CONTINUED DURING DEMOLITION. DEMOLITION CONTRACTOR SHALL NOT INTERFERE WITH THESE OPERATIONS IN ANY WAY WITHOUT THE OWNER'S EXPRESSED CONSENT.
B.	OWNER WILL PROVIDE PORTIONS OF THE BUILDING IMMEDIATELY ADJACENT TO DEMOLITION ACTIVE DEMOLITION. CONTRACT SELECTIVE DEMOLITION WORK IN MANNER THAT WILL MINIMIZE NEED FOR DISRUPTION OF OWNER'S NORMAL OPERATIONS. REFER TO SPECIFICATIONS FOR SUMMARY ADVANCE NOTICE TO OWNER.
C.	PROVIDE TEMPORARY BARRICADES AND OTHER FORMS OF PROTECTION TO PROTECT OWNER'S PERSONNEL AND GENERAL PUBLIC FROM INJURY DUE TO SELECTIVE DEMOLITION WORK. REFER TO PHASING SHEET FOR MORE INFORMATION.
D.	PROVIDE 1-HOUR FIRE RESISTANT CONSTRUCTION BARRIERS WHERE REQ'D TO PROTECT EXISTING CONSTRUCTION AND OWNERS OPERATIONS.
E.	PROTECT FROM DAMAGE EXISTING FINISH WORK THAT IS TO REMAIN IN PLACE AND BECOME EXPOSED DURING DEMOLITION OPERATIONS.
F.	PROTECT FLOORS WITH SUITABLE COVERING WHEN NECESSARY.
G.	COVER AND PROTECT FURNITURE, EQUIPMENT, AND FIXTURES FROM SOILAGE OR DAMAGE WHEN DEMOLITION WORK IS PERFORMED IN AREAS WHERE SUCH ITEMS HAVE NOT BEEN REMOVED.
H.	PRIOR TO CUTTING EXISTING CONSTRUCTION, LOCATE AND IDENTIFY SERVICES TO REMAIN IN OPERATION, INCLUDING ALL FLOOR PENETRATIONS. UNLOCATED EXISTING CONDUIT AND GENERAL PUBLIC FROM INJURY DUE TO CONTAIN LIFE SAFETY VERTICAL RISERS THAT MUST REMAIN IN OPERATION DURING THE DEMOLITION WORK.
I.	CONTRACTOR SHALL VERIFY ALL EXISTING BUILDINGS DIMENSIONS, PARTITION AND WALL LOCATIONS AND FLOOR ELEVATIONS IN FIELD AND NOTIFY THE OWNER'S REPRESENTATIVE OF ANY DISCREPANCIES BEFORE THE START OF WORK.
J.	WHEN UNANTICIPATED MECHANICAL, ELECTRICAL, OR STRUCTURAL ELEMENTS THAT CONFLICT WITH INTENDED FUNCTION OF DESIGN ARE ENCOUNTERED, INVESTIGATE AND MEASURE BOTH NATURE AND EXTENT OF THE CONFLICT AND NOTIFY OWNER'S REPRESENTATIVE.
K.	MAINTAIN EXISTING UTILITIES INDICATED TO REMAIN IN SERVICE AND PROTECT EXISTING DAMAGE DURING DEMOLITION OPERATIONS. DO NOT INTERRUPT UTILITIES SERVED OR USED FACILITIES, EXCEPT WHEN AUTHORIZED IN WRITING BY AUTHORITIES HAVING JURISDICTION.
L.	WHERE DEMOLITION OF RECD BEYOND THE LIMITS OF THE CONTRACT TO ROUTE NEW DUCTWORK, PIPING, CONDUITS ETC., RATED WALLS AND SMOKE BARRIERS SHALL BE PATCHED BY CONTRACTOR REQUIRING PENETRATIONS, ALL FINISHES DAMAGED BY THE WORK SHALL BE RESTORED TO THEIR ORIGINAL CONDITION.
M.	REPAIR DEMOLITION PERFORMED IN EXCESS OF THAT REQ'D. RETURN ELEMENTS OF CONSTRUCTION AND SURFACES TO REMAIN, TO THE CONDITION EXISTING PRIOR TO START OF OPERATIONS. REPAIR ADJACENT CONSTRUCTION OR SURFACES SOILED OR DAMAGED BY SELECTIVE DEMOLITION.
N.	PROVIDE SHORING, BRACING AND ANY OTHER MEANS REQ'D TO PROTECT AND MAINTAIN THE SAFETY, INTEGRITY AND STABILITY OF ALL EXISTING AND NEW CONSTRUCTION.
O.	WHEN ROOFING, GLAZING, FLASHING, COPING OR PORTIONS OF EXTERIOR WALLS ARE REMOVED OR DRENED, SUITABLE WEATHER PROTECTION SHALL BE PROVIDED AND MAINTAINED FOR THE DURATION OF WORK.
P.	REMOVAL OF ITEMS NOTS INCLUDES REMOVAL OF ANCHORS, ADHESIVES, HARDWARE, CONDUIT, WIRE, PIPING, ETC. FOR A COMPLETE REMOVAL OF THE TIMES OR SYSTEMS.
Q.	WHEREVER WATER CLOSETS, FLOOR SINKS OR OTHER EQUIPMENT AND RELATED PIPING ARE TO BE REMOVED, PATCH FLOOR SLAB W/ CONCRETE AS REQUIRED.
T.	ALL CONCRETE FLOOR SLABS NOTS TO BE REMOVED SHALL BE SAWCUT TO PROVIDE A NEAT JOINT. REF. TO UNIT PLAN SHEET AS111 FOR MORE INFORMATION ON SLAB DEMOLITION AT NEW PATIENT UNIT TOLIOO ROOMS.
U.	SEE MECHANICAL, CIVIL, AND ELECTRICAL DEMOLITION DRAWINGS FOR ADDITIONAL SCHE OF DEMOLITION WORK.
V.	SALVAGE ALL EXISTING REMOVED BRICK FOR PATCHING AND REFINISH WORK AS REQ'D - TYPICAL.
W.	DEMOLITION OF ANY EXISTING CONSTRUCTION SHALL INCLUDE WHAT IS NECESSARY AND REQ'D TO ACCOMMODATE THE REQUIREMENTS OF NEW CONSTRUCTION. REFER TO THE APPROPRIATE DRAWINGS AS TO THE EXTENT OF NEW CONSTRUCTION TO REMAIN.
X.	SURFACES SHALL BE CLEANED AND PREPARED WITHIN THE NEW MATERIALS GUIDELINES OF INSTALLATION OF THEIR PRODUCT IN EXISTING CONSTRUCTION.
Y.	ALL DEMOLITION SHALL COMPLY WITH APPLICABLE LOCAL CODES AND STATE CODES AND ORDINANCES.

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
St. Cloud VA
Health Care System
Brainerd | Montevideo | Alexandria

JLG
architects

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MN 43619

DANIEL J. MILLER, AIA

REG. NO.


DRAWING TITLE

**SECOND FLOOR DEMOLITION
PLAN**


PROJECT TITLE	RECONFIGURE/EXPAND BUILDINGS 28 & 9 FOR RESIDENTIAL REHABILITATION TREATMENT PROGRAM
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PROJECT TITLE RECONFIGURE/EXPAND BUILDINGS 28 & 9 FOR RESIDENTIAL REHABILITATION TREATMENT PROGRAM			DATE 12.20.13
BUILDING No 28			CAD FILE
CHECKED BY DJM	DRAWN ADB	PLOT SCALE AS NOTED	
LOCATION ST. CLOUD VA MEDICAL CENTER ST. CLOUD, MN 56303		PROJECT NO. 656-12-339	
		DRAWING NO. AD102	


VA FORM 08-6231

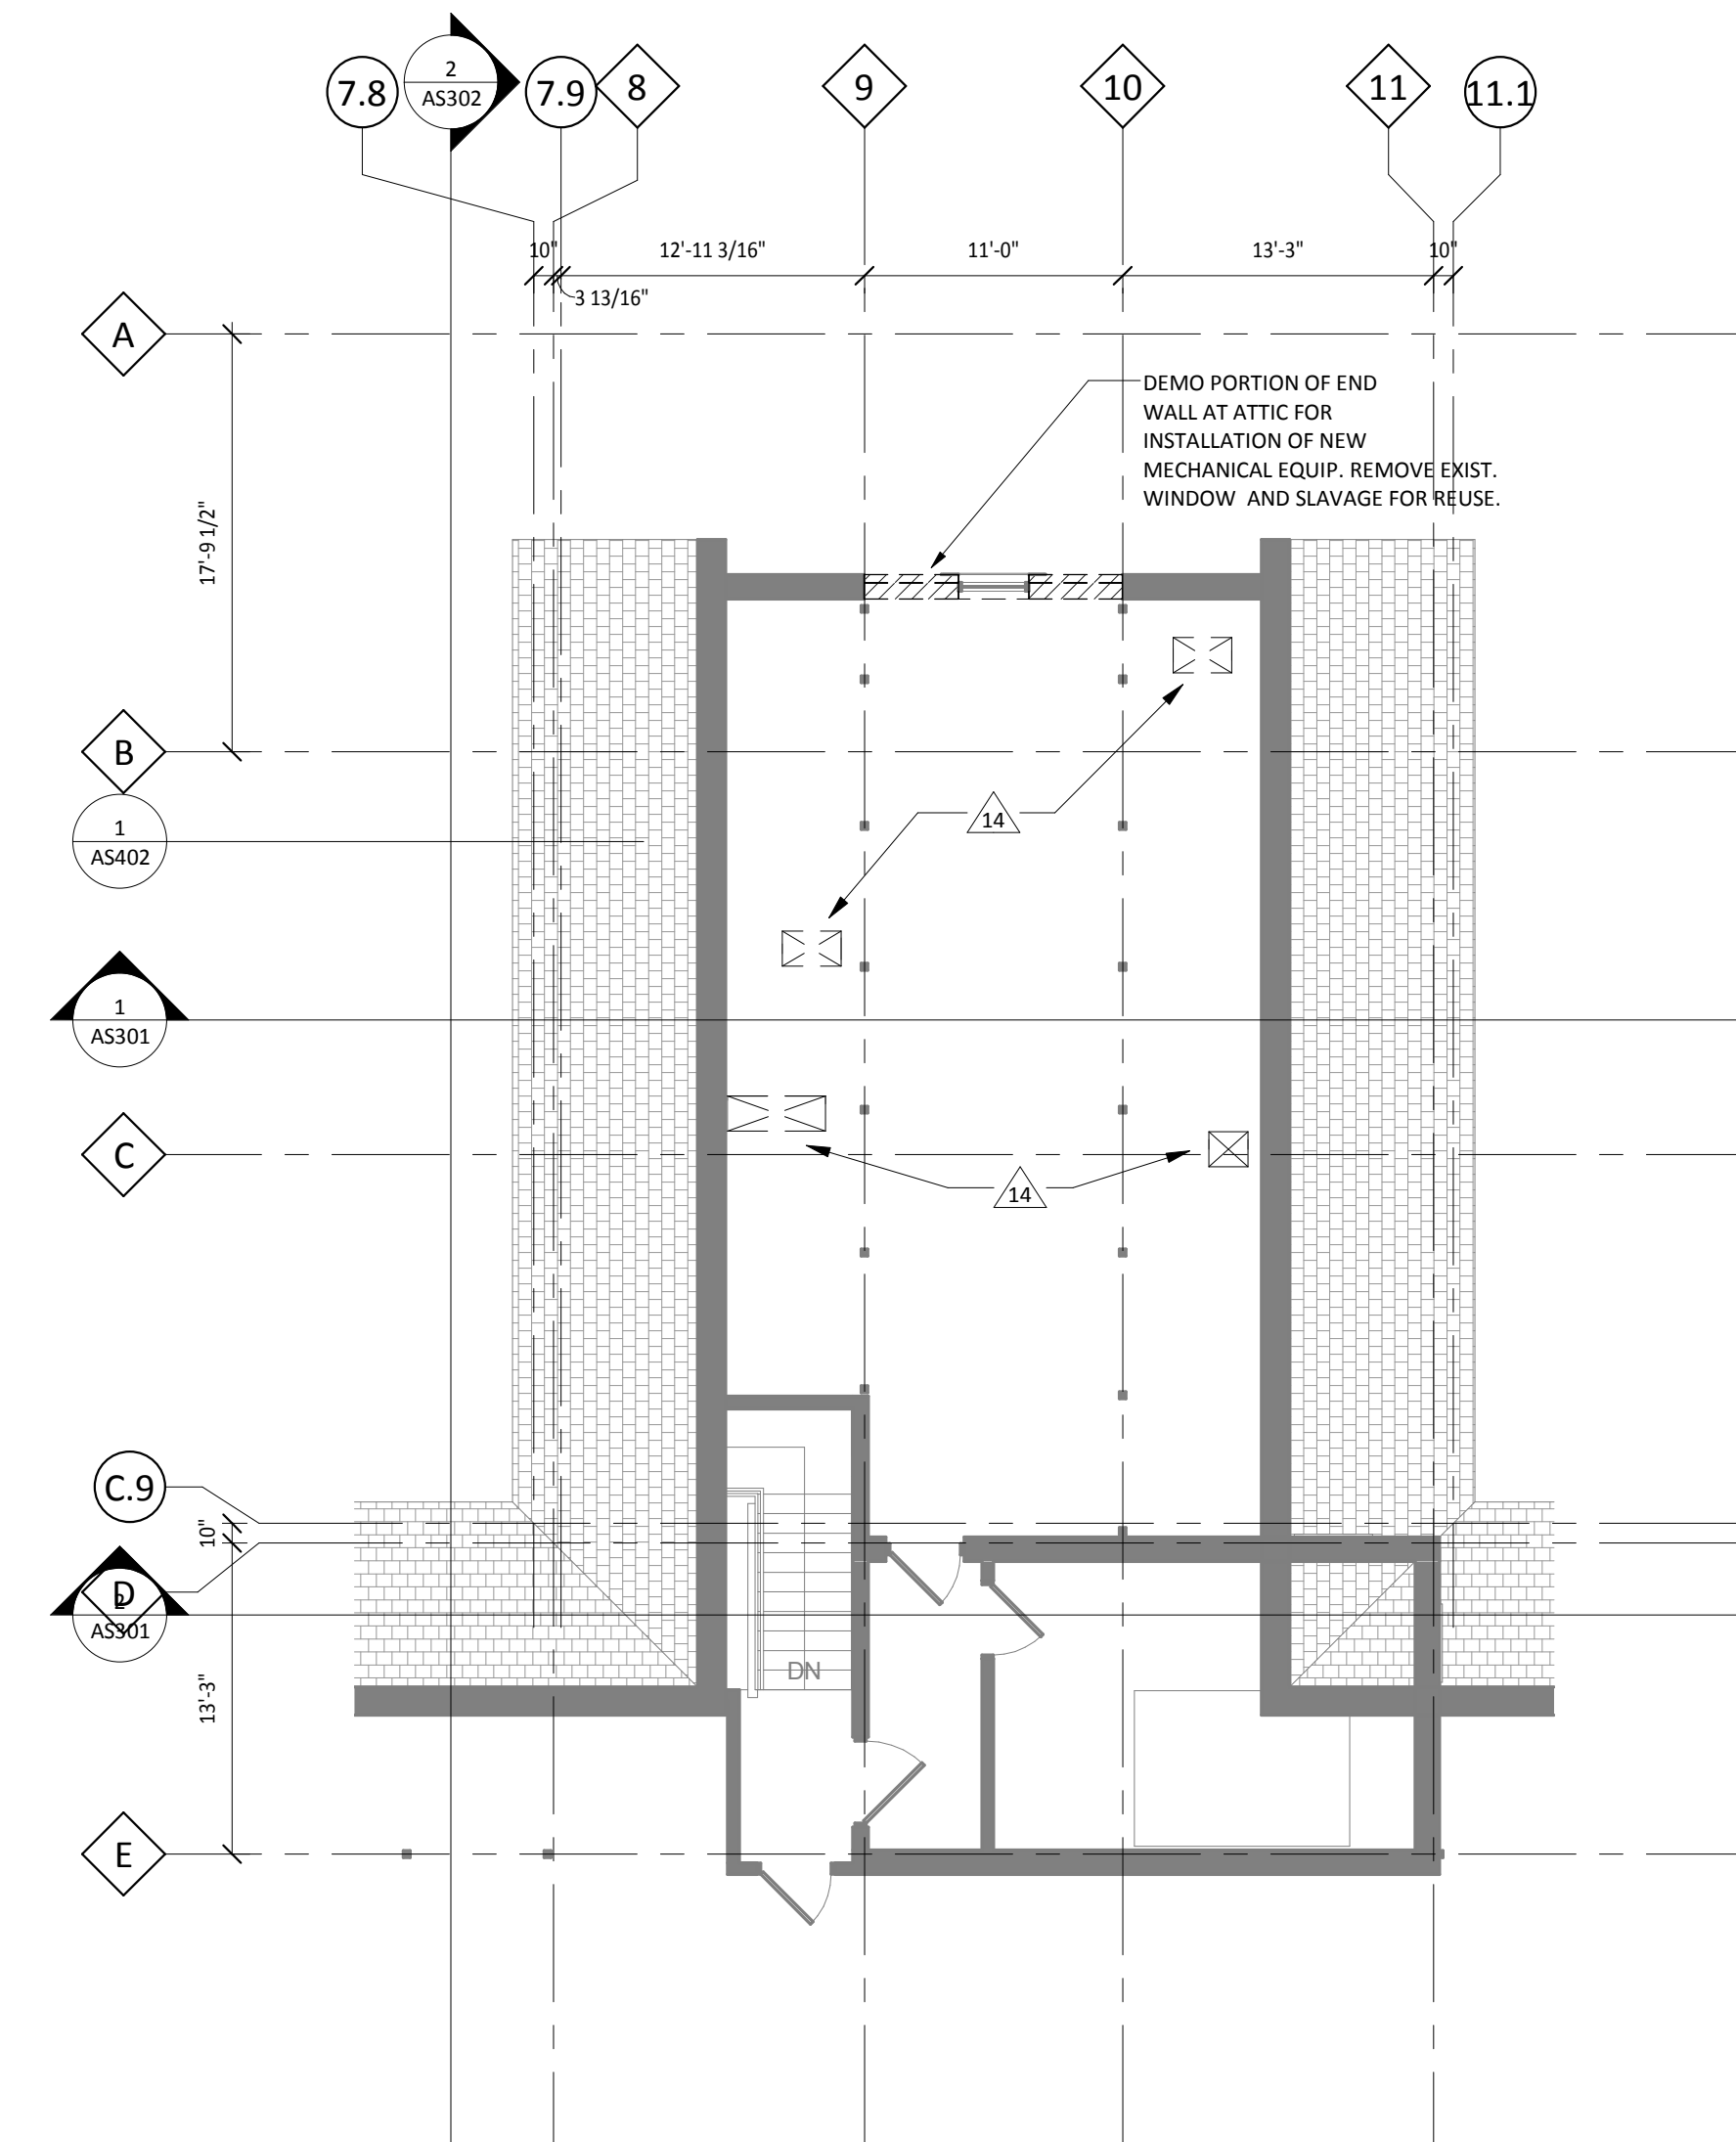


5 ATTIC FLOOR PLAN
1/8" = 1'-0"

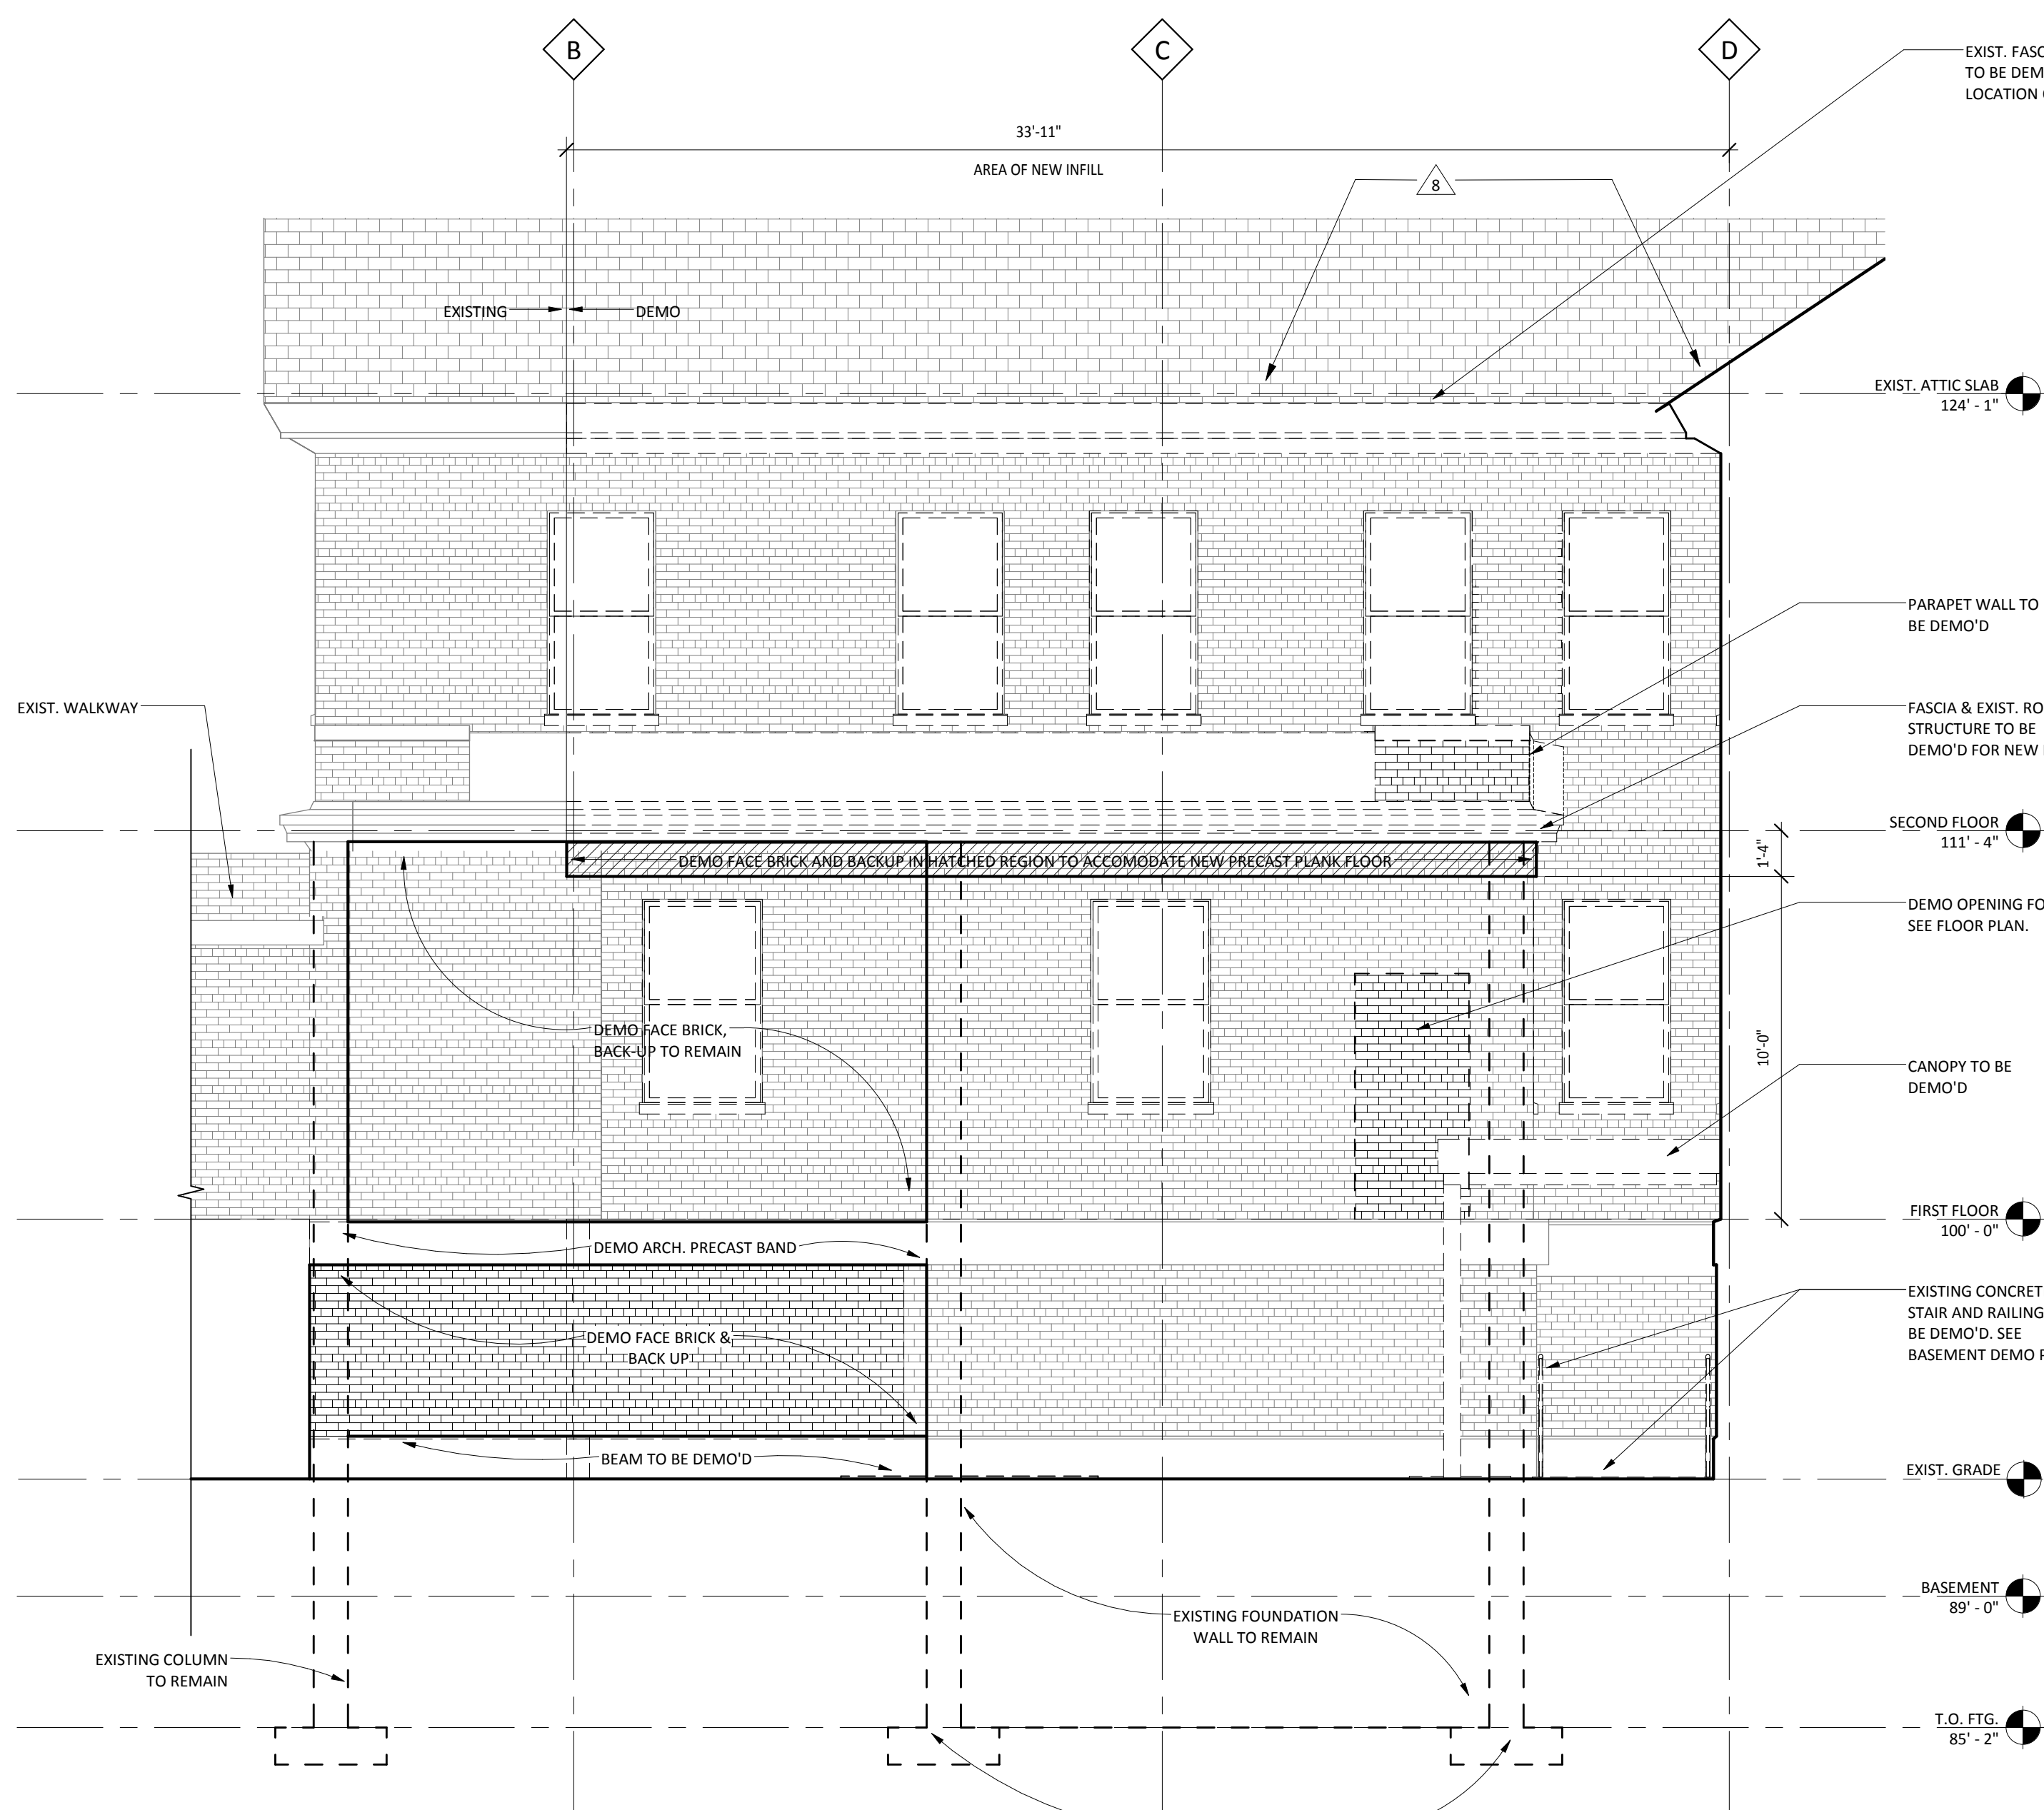


4 ELEVATION AT EXIST. WALKWAY CONNECTION
1/4" = 1'-0"

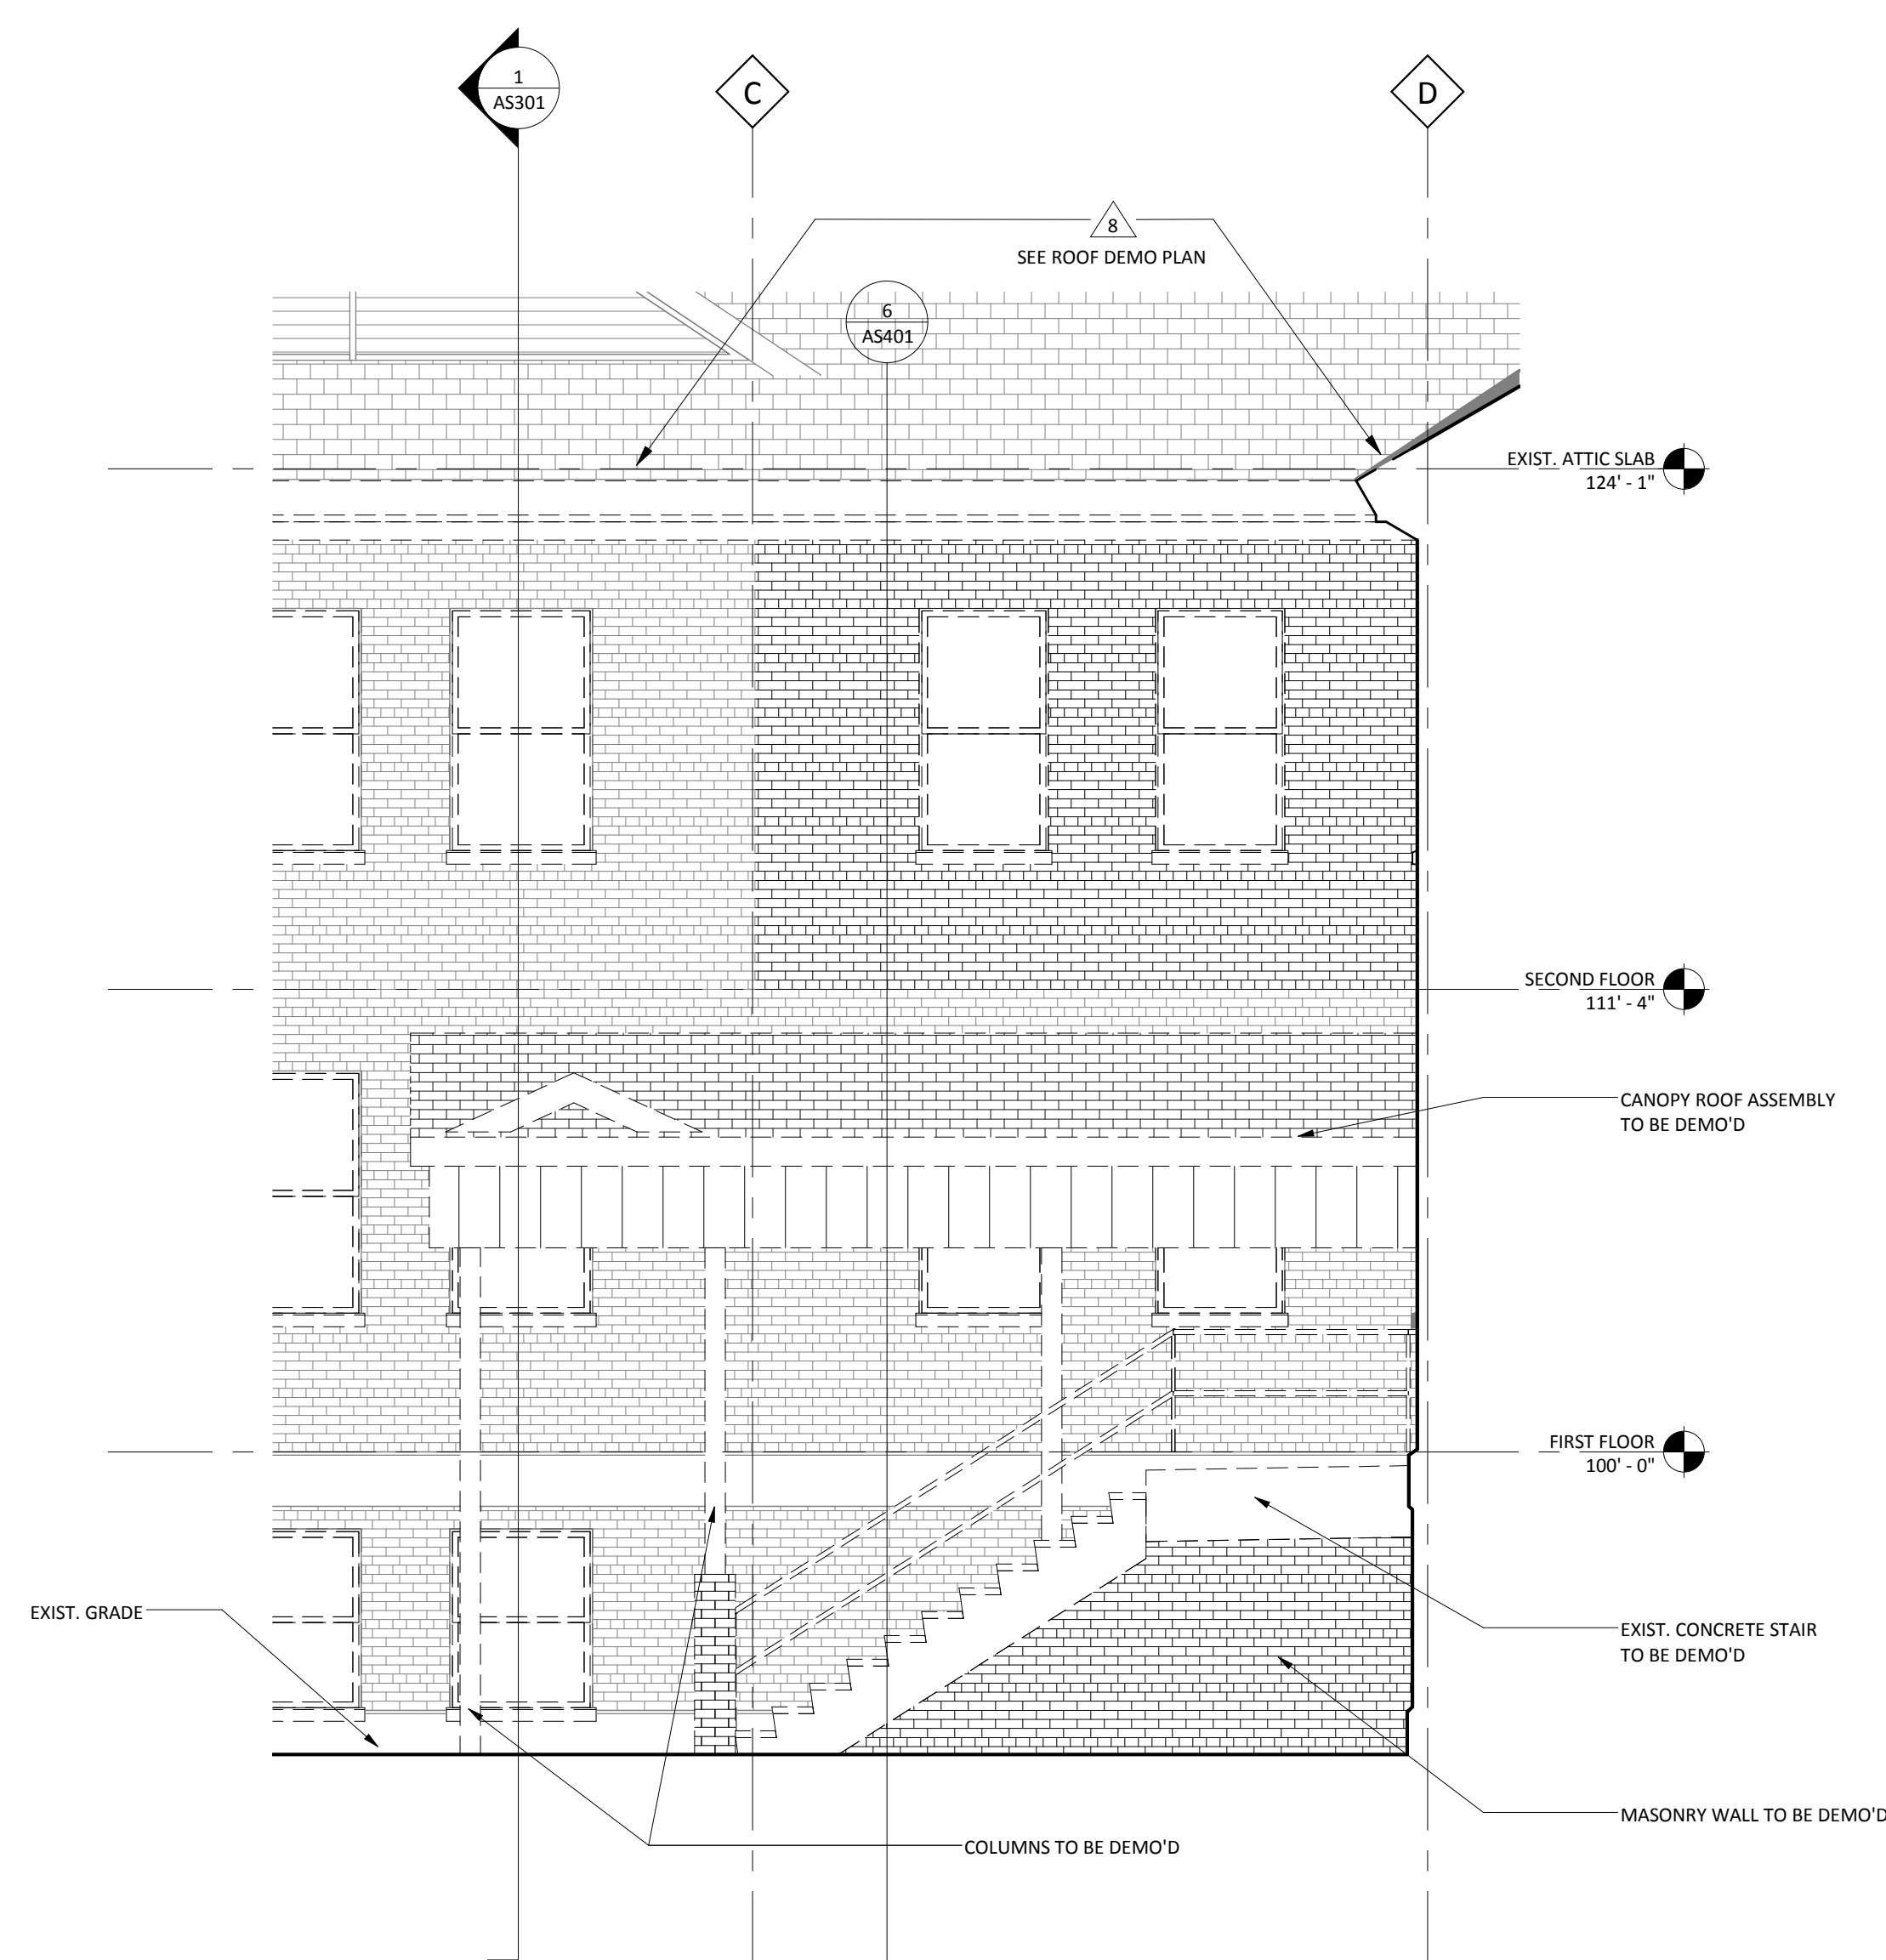

2 DEMO AT EXT. STAIR
1/4" = 1'-0"

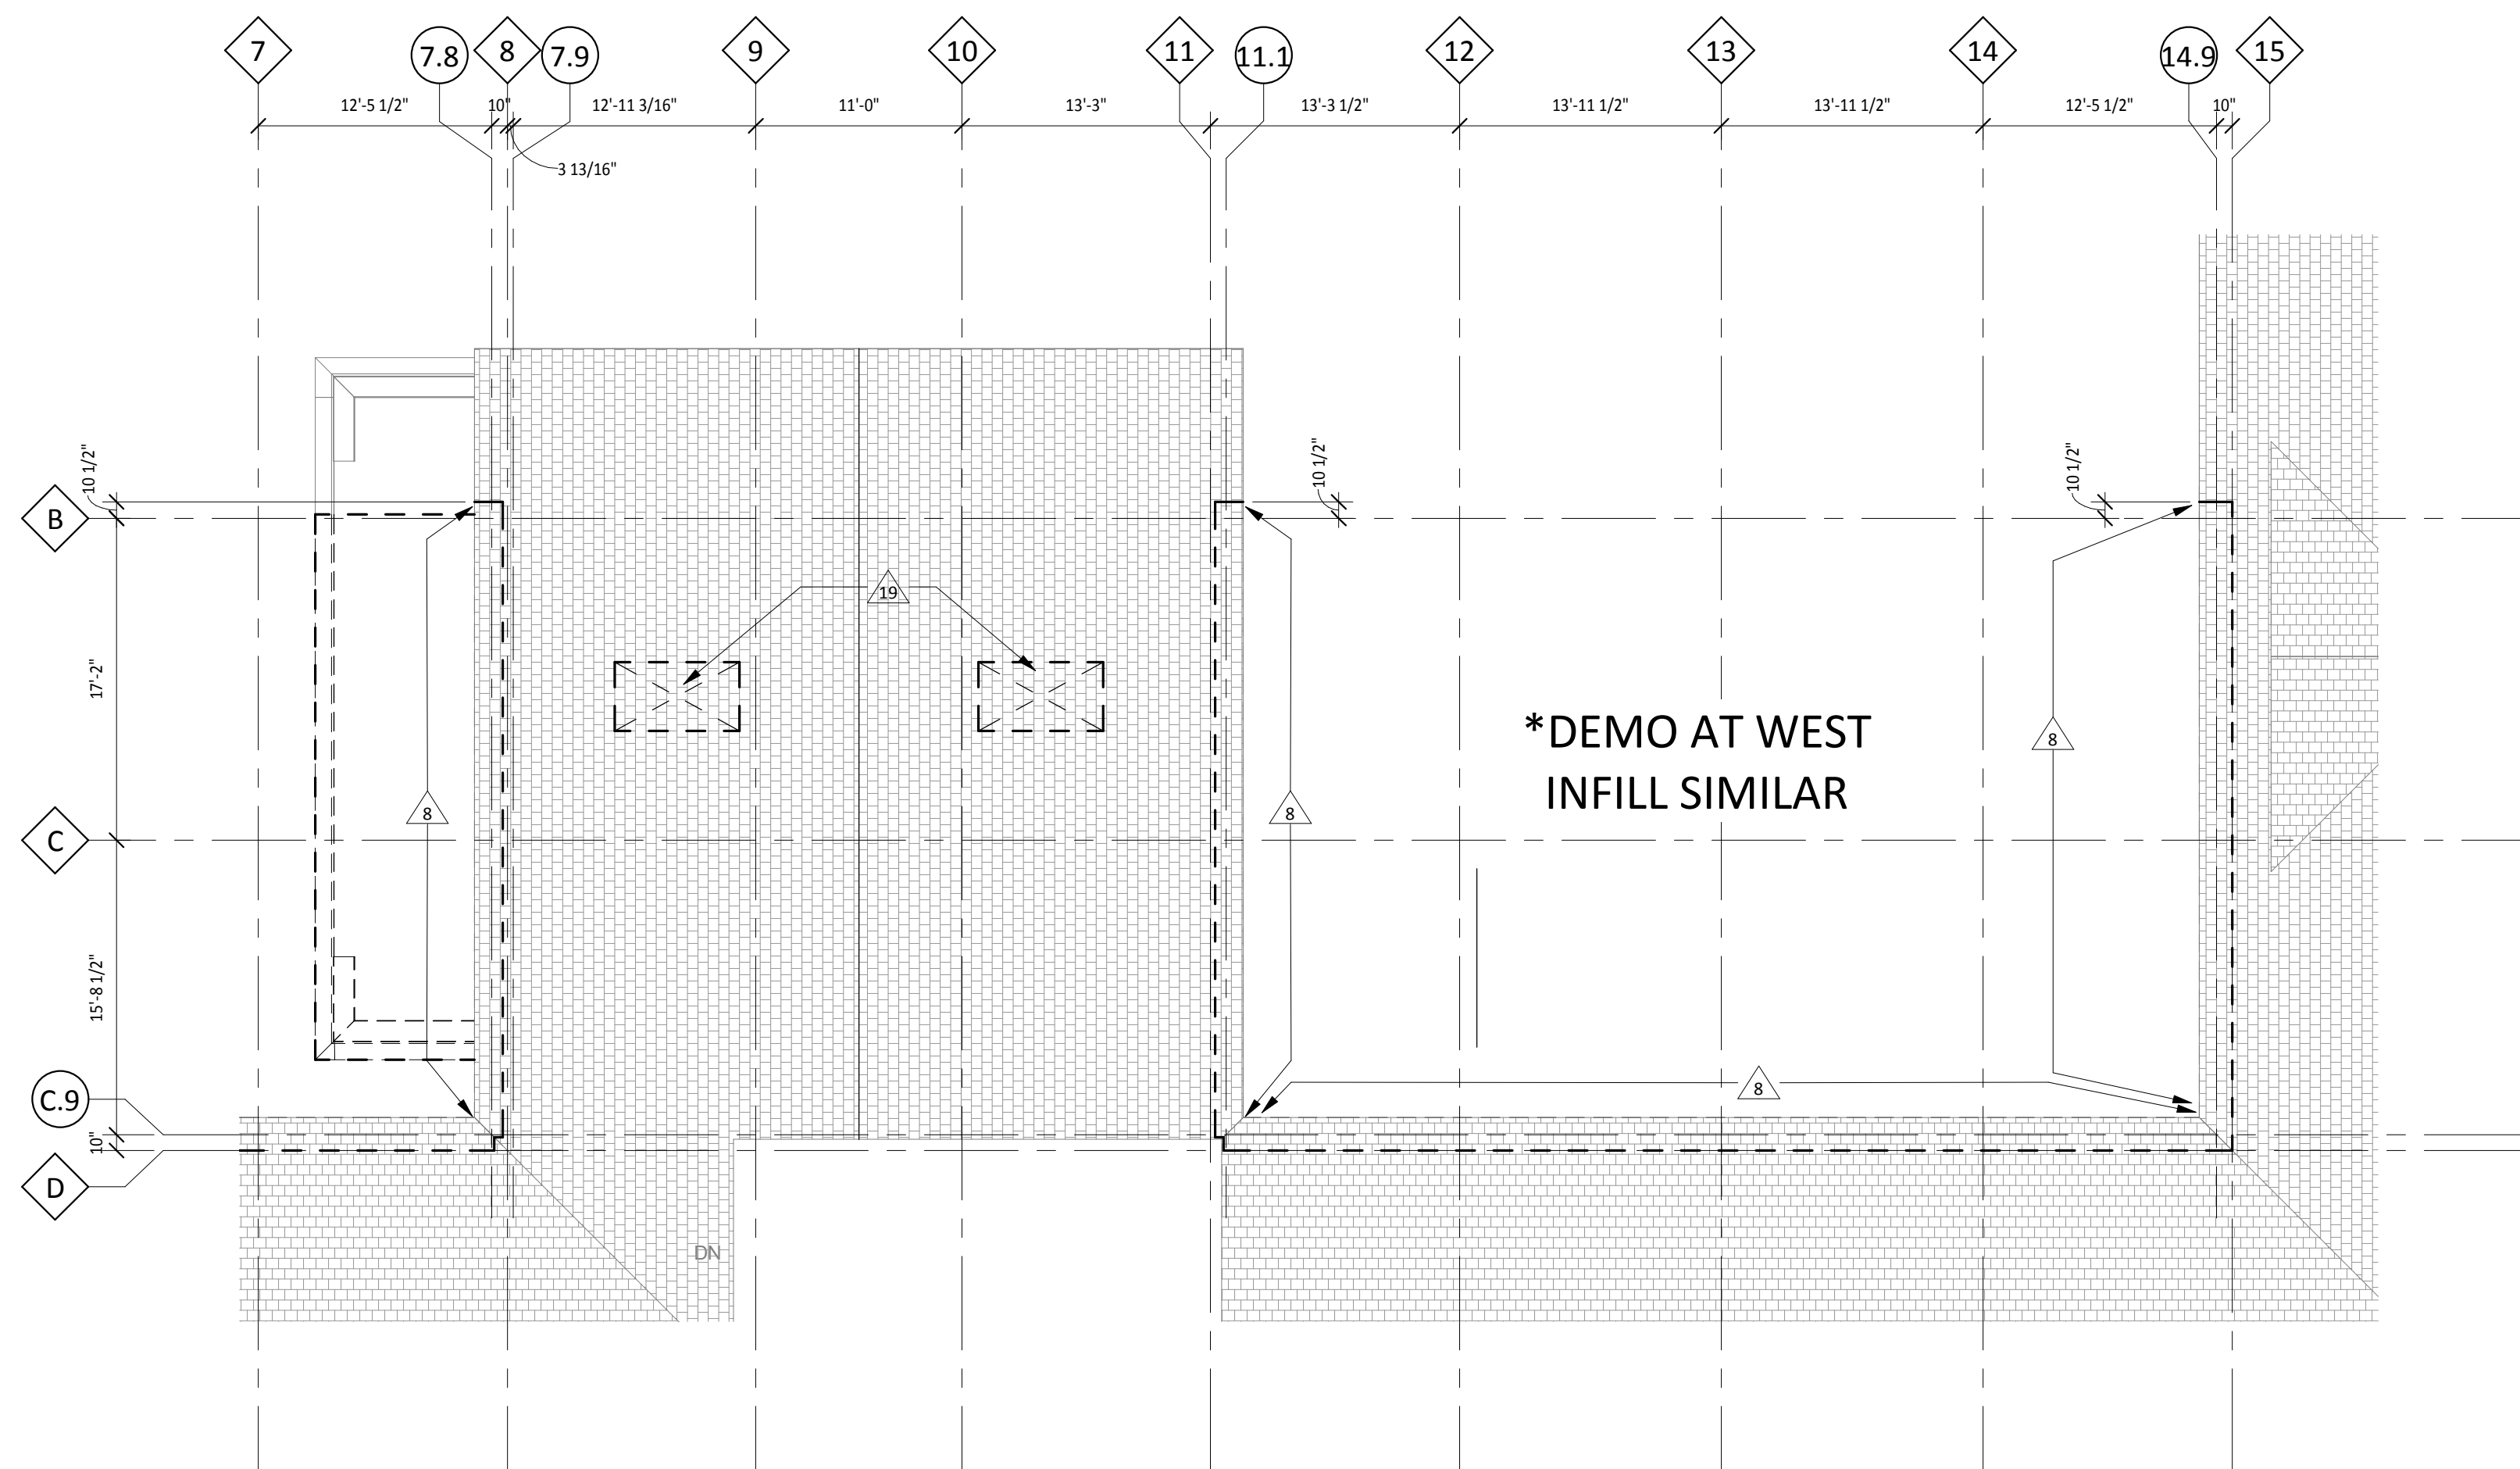

3 ROOF DEMO PLAN
1/8" = 1'-0"

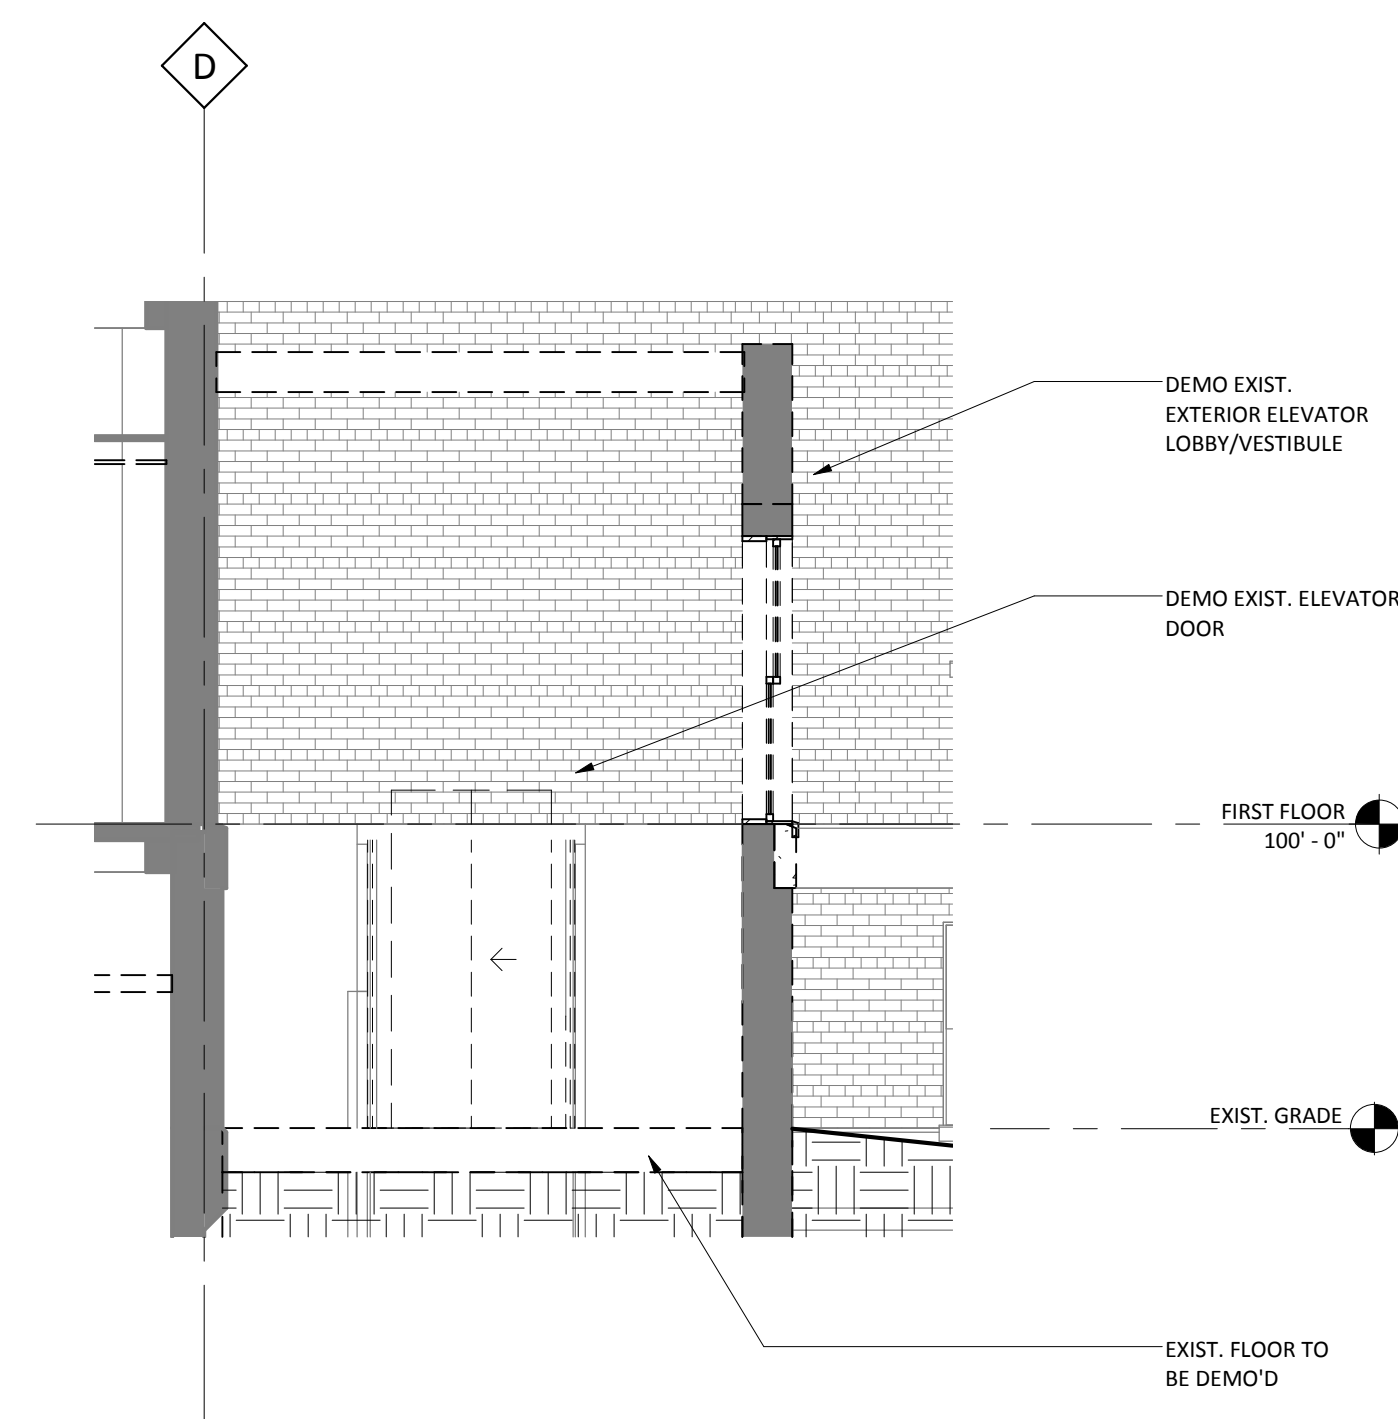

1 DEMO AT EXIST. ELEVATOR LOBBY
1/4" = 1'-0"

DEMO PLAN KEYNOTES	
NO.	NOTE
1	DEMO EXISTING CANOPY ABOVE INCLUDING COLUMNS, FOOTINGS, AND ANY OTHER ASSOCIATED ELEMENTS
2	DEMO EXISTING STAIRS AT THIS LEVEL
3	DEMO EXISTING ELEVATOR DOOR AT GRADE. INSTALL NEW ELEVATOR DOOR AT BASEMENT LEVEL
4	DEMO FACE BRICK - BACK UP TO REMAIN
5	NOT USED.
6	EXISTING CASEWORK TO BE DEMO'D
7	DEMO FACE BRICK & BACK UP MASONRY. CONCRETE STRUCTURE TO REMAIN.
8	DEMO EXIST. ROOF, GUTTER, CORNICE, FASCIA.
9	DEMO EXISTING WINDOW. INFILL WITH CMU BLOCK, MTL STUDS AND GWB. PATCH TO MATCH EXISTING INTERIOR. REF. TO DETAIL 12/ASS01. SALVAGE AND GIVE WINDOW SASHES TO VA.
10	EXISTING OUTBUILDING TO BE REMOVED - SEE SITE PLAN
11	EXISTING CONCRETE EQUIPMENT PAD TO BE DEMOLISHED
12	DEMO PORTION OF WALL FOR NEW DOOR OPENING, COORDINATE WITH DOOR SCHEDULE.
13	DEMO PORTION OF WALL FOR NEW STEEL INFILL COLUMN. SEE STRUCT.
14	DEMO NEW PENETRATION IN FLOOR FOR MECH. EQUIPMENT. COORDINATE LOCATIONS WITH MECHANICAL AND EXIST. CONCRETE STRUCTURE
15	TEMPORARY DOOR OPENING. REFER TO PHASING PLAN
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17	REMOVE EXISTING ACT CEILING AS REQUIRED, SALVAGE FOR RE-USE. ALL EXISTING LIFE SAFETY SYSTEMS TO REMAIN FULLY FUNCTIONAL DURING CONSTRUCTION. REINSTALL CEILING FOLLOWING COMPLETION OF WORK IN AREA.
18	DEMO EXISTING GWB CEILING. ALL EXISTING LIFE SAFETY SYSTEMS TO REMAIN FULLY FUNCTIONAL DURING CONSTRUCTION.
19	DEMO OPENING IN ROOF FOR NEW DUCTWORK. COORDINATE SIZE AND LOCATION WITH MECH. REFER TO STRUCT. FOR FRAMING.

100% CD SET

FOR CONSTRUCTION

NO.	REVISION	DATE

VA FORM 08-6231



JLG 11129

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DANIEL J. MILLER, AIA
DATE: 12-20-2013
REG. NO.

DRAWING TITLE
DEMO ROOF PLANS &
ELEVATIONS

PROJECT TITLE
RECONFIGURE/EXPAND
BUILDINGS 28 & 9 FOR
RESIDENTIAL REHABILITATION
TREATMENT PROGRAM


BUILDING No. 28
CHECKED BY DJM
DRAWN ADB
LOCATION
ST. CLOUD VA MEDICAL CENTER
ST. CLOUD, MN 56303

DATE 12.20.13
PROJECT NO. 656-12-329
SHEET SCALE AS NOTED


DATE FILE
DRAWING NO. AD201



three inches = one foot
one and one half inches = one foot
one inch = one foot
three quarters inch = one foot
one half inch = one foot
three eighths inch = one foot
one quarter inch = one foot
one eighth inch = one foot

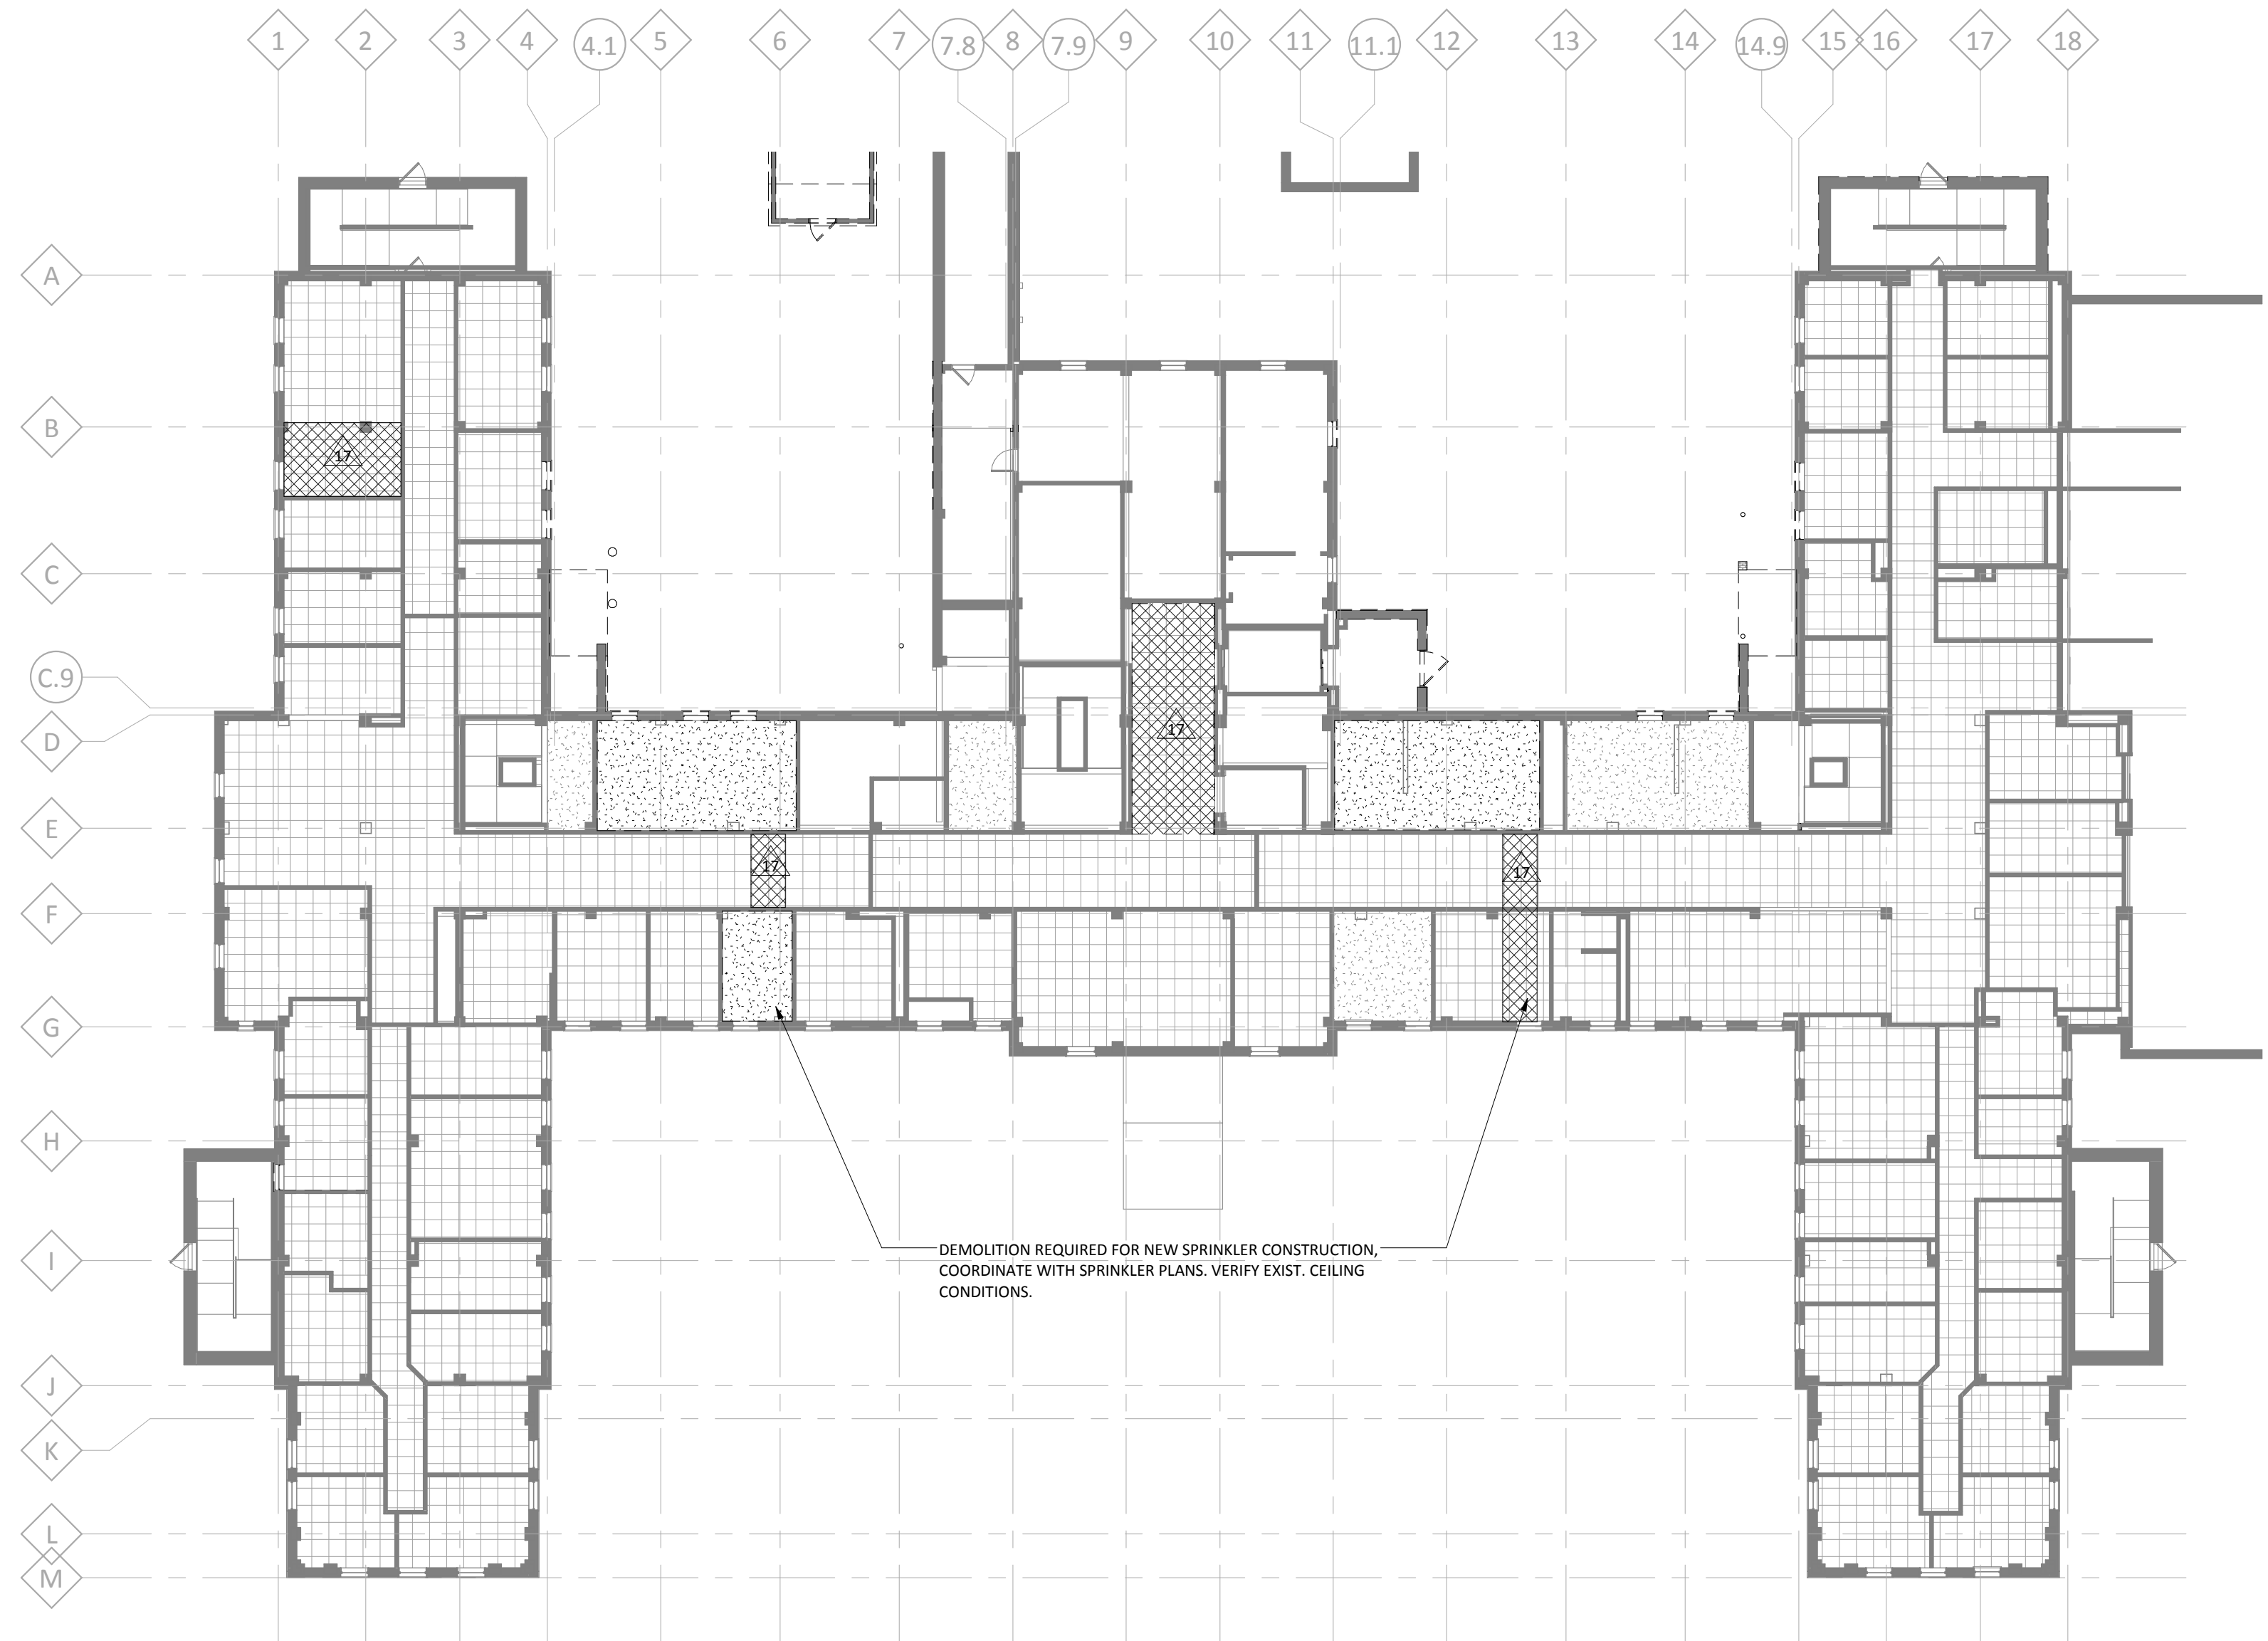

3 BASEMENT DEMO RCP
1/16" = 1'-0"

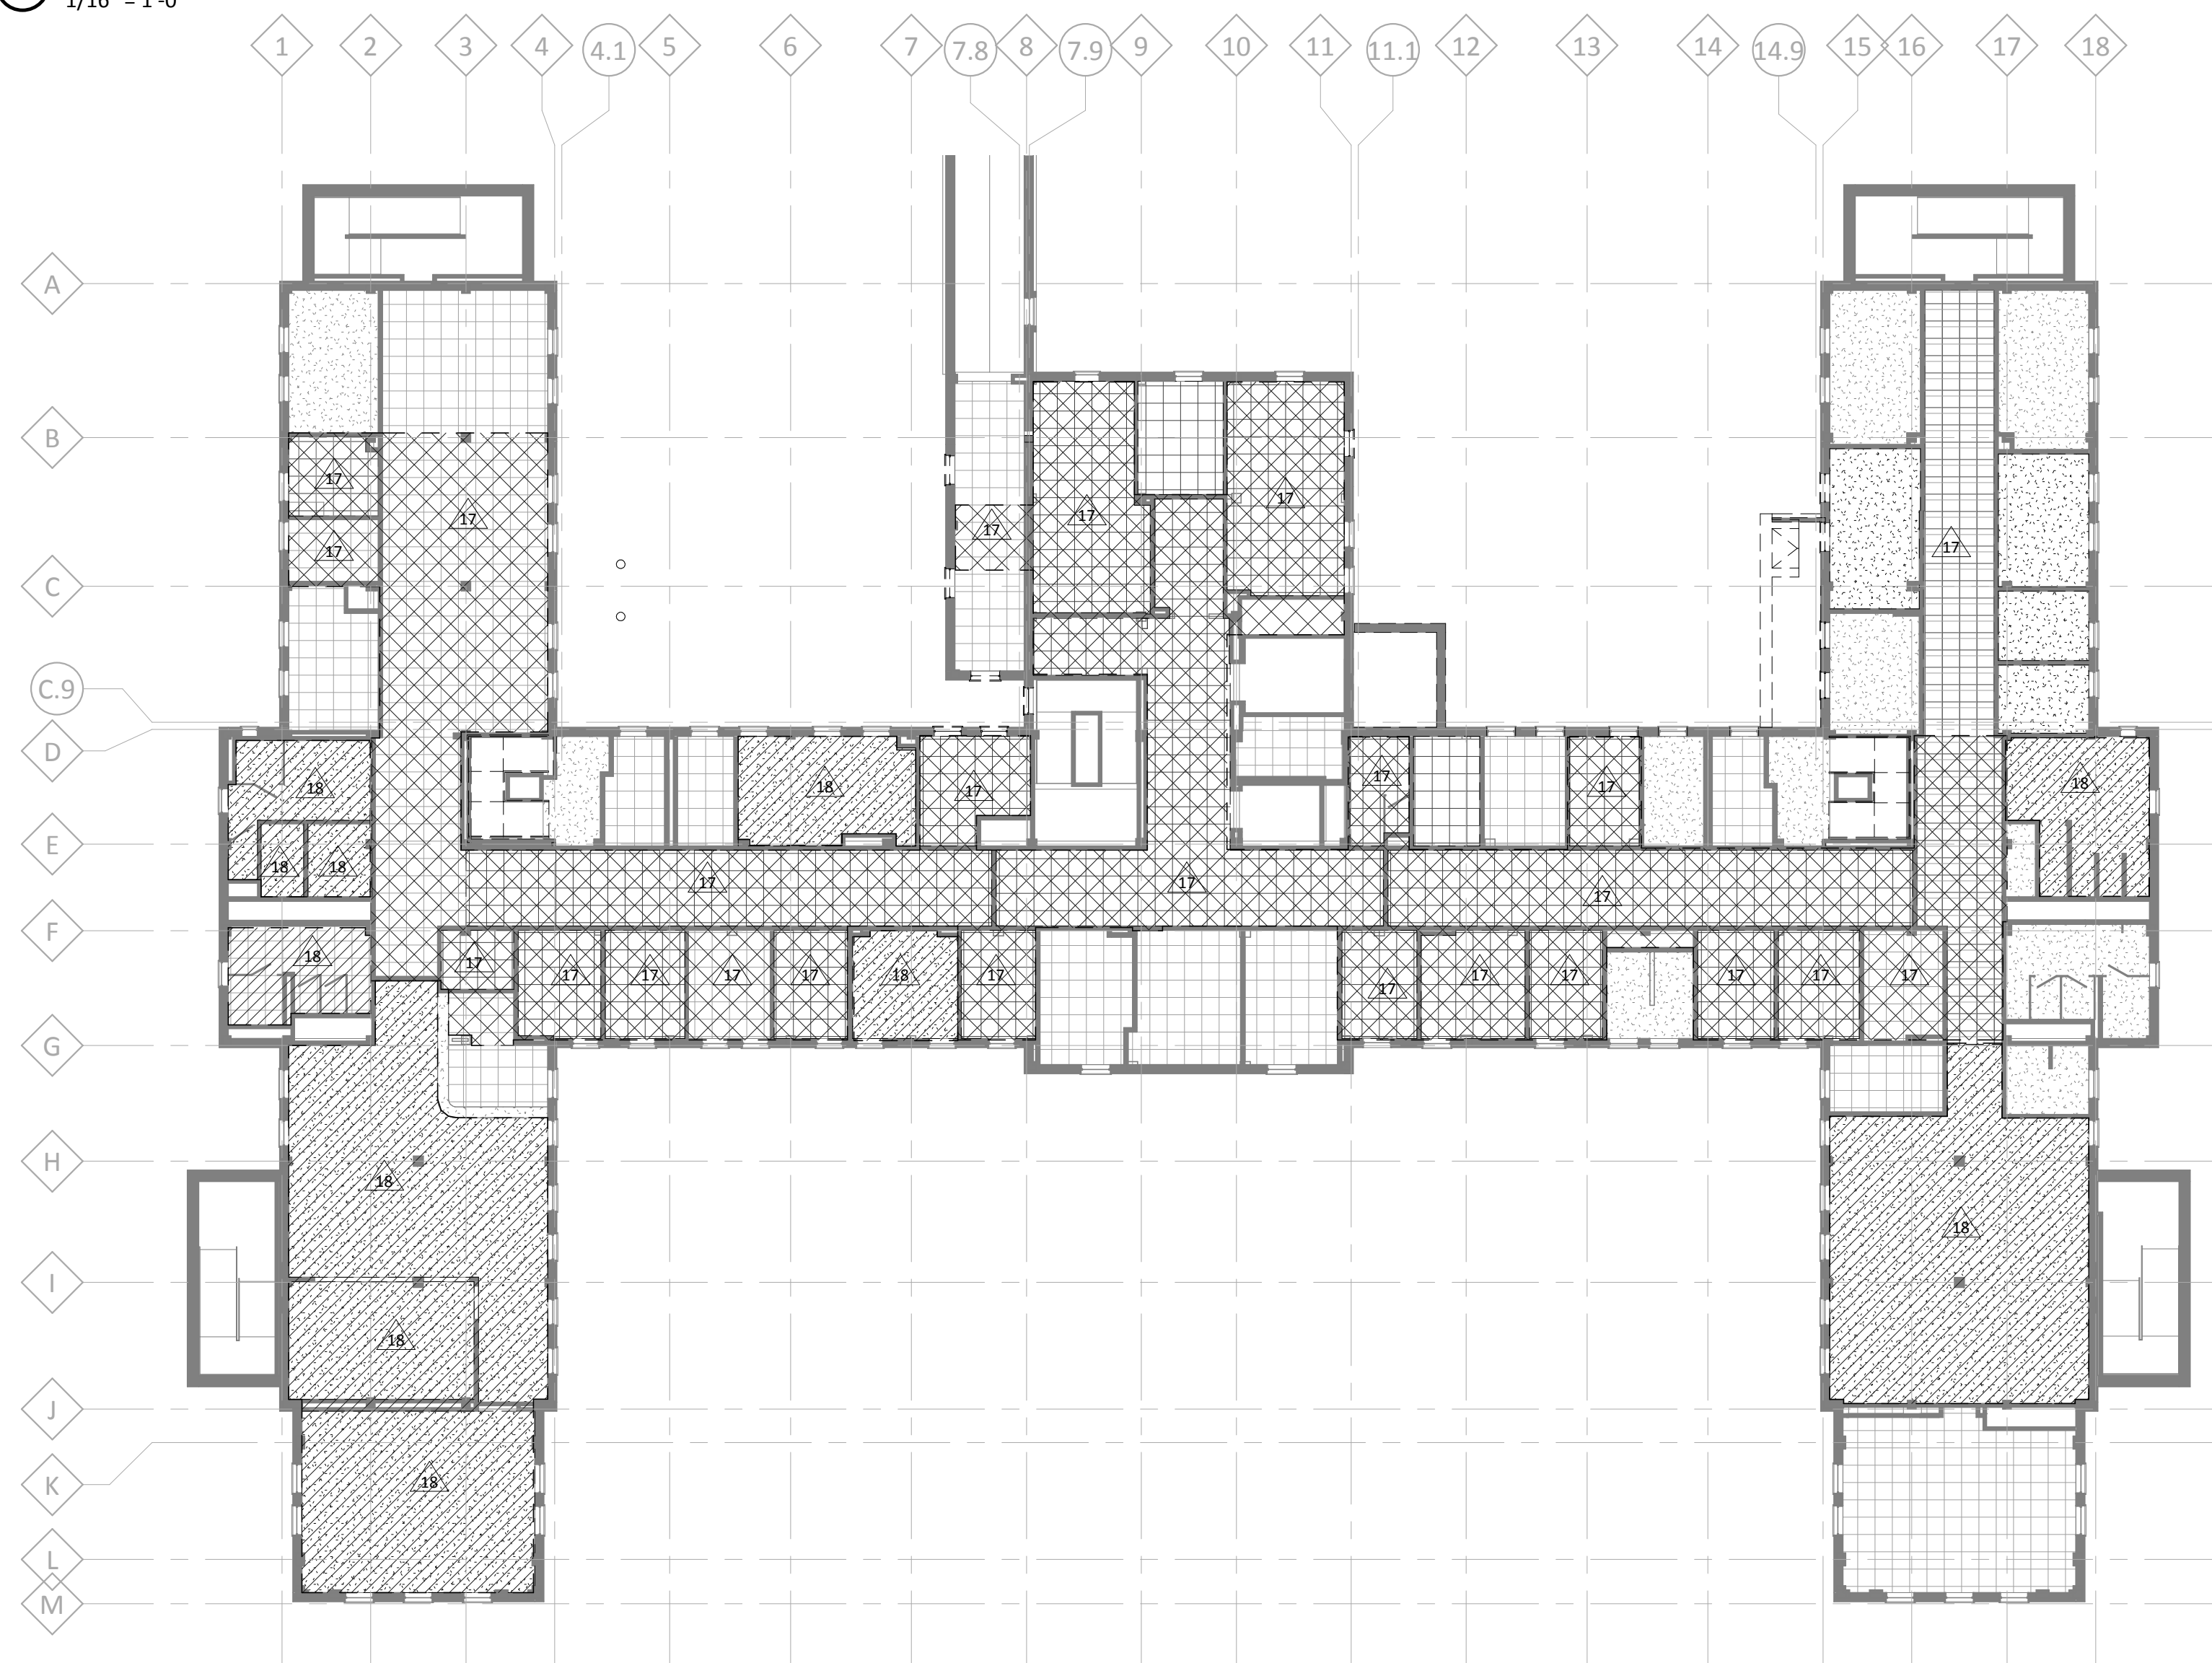


2 FIRST FLOOR
1/16" = 1'-0"

CEILING DEMO LEGEND

- AREA OF CEILING TO BE REMOVED FOR NEW CONSTRUCTION. SALVAGE & REINSTALL WHEN NEW WORK IS COMPLETED.
- * DURING PERIODS OF TEMPORARY CEILING REMOVAL ALL SMOKE AND FIRE RATINGS FOR EXISTING ASSEMBLIES MUST BE RETAINED. ALL FIRE SUPPRESSION AND LIFE SAFETY SYSTEMS MUST ALSO REMAIN FULLY FUNCTIONAL DURING THESE TIME PERIODS.
- AREA OF CEILING TO BE DEMOLISHED. INSTALL NEW CEILING UNDER CONSTRUCTION OF NEW WORK.

DEMO PLAN KEYNOTES	
NO.	NOTE
1	DEMO EXISTING CANOPY ABOVE INCLUDING COLUMNS, FOOTINGS, AND ANY OTHER ASSOCIATED ELEMENTS
2	DEMO EXISTING STAIRS AT THIS LEVEL
3	DEMO EXISTING ELEVATOR DOOR AT GRADE. INSTALL NEW ELEVATOR DOOR AT BASEMENT LEVEL
4	DEMO FACE BRICK - BACK UP TO REMAIN
5	NOT USED.
6	EXISTING CASEWORK TO BE DEMO'D
7	DEMO FACE BRICK & BACK UP MASONRY. CONCRTE STRUCTURE TO REMAIN.
8	DEMO EXIST. ROOF, GUTTER, CORNICE, FASCIA.
9	DEMO EXISTING WINDOW. INFILL WITH CMU BLOCK, MTL STUDS AND GWB. PATCH TO MATCH EXISTING INTERIOR. REF. TO DETAIL 12/ASS01. SALVAGE AND GIVE WINDOW SASHES TO VA.
10	EXISTING OUTBUILDING TO BE REMOVED - SEE SITE PLAN
11	EXISTING CONCRETE EQUIPMENT PAD TO BE DEMOLISHED
12	DEMO PORTION OF WALL FOR NEW DOOR OPENING, COORDINATE WITH DOOR SCHEDULE.
13	DEMO PORTION OF WALL FOR NEW STEEL INFILL COLUMN. SEE STRUCT.
14	DEMO NEW PENETRATION IN FLOOR FOR MECH. EQUIPMENT. COORDINATE LOCATIONS WITH MECHANICAL AND EXIST. CONCRETE STRUCTURE
15	TEMPORARY DOOR OPENING. REFER TO PHASING PLAN
16	DEMO EXISTING GRADE BEAM AND MASONRY WALL FROM GRADE BEAM UP TO LEVEL 1. CONSTRUCT NEW FOUNDATION WALL AND INFILL MASONRY WALL TO MATCH EXISTING. REF. TO STRUCTURAL.
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1 SECOND FLOOR DEMO RCP
1/16" = 1'-0"

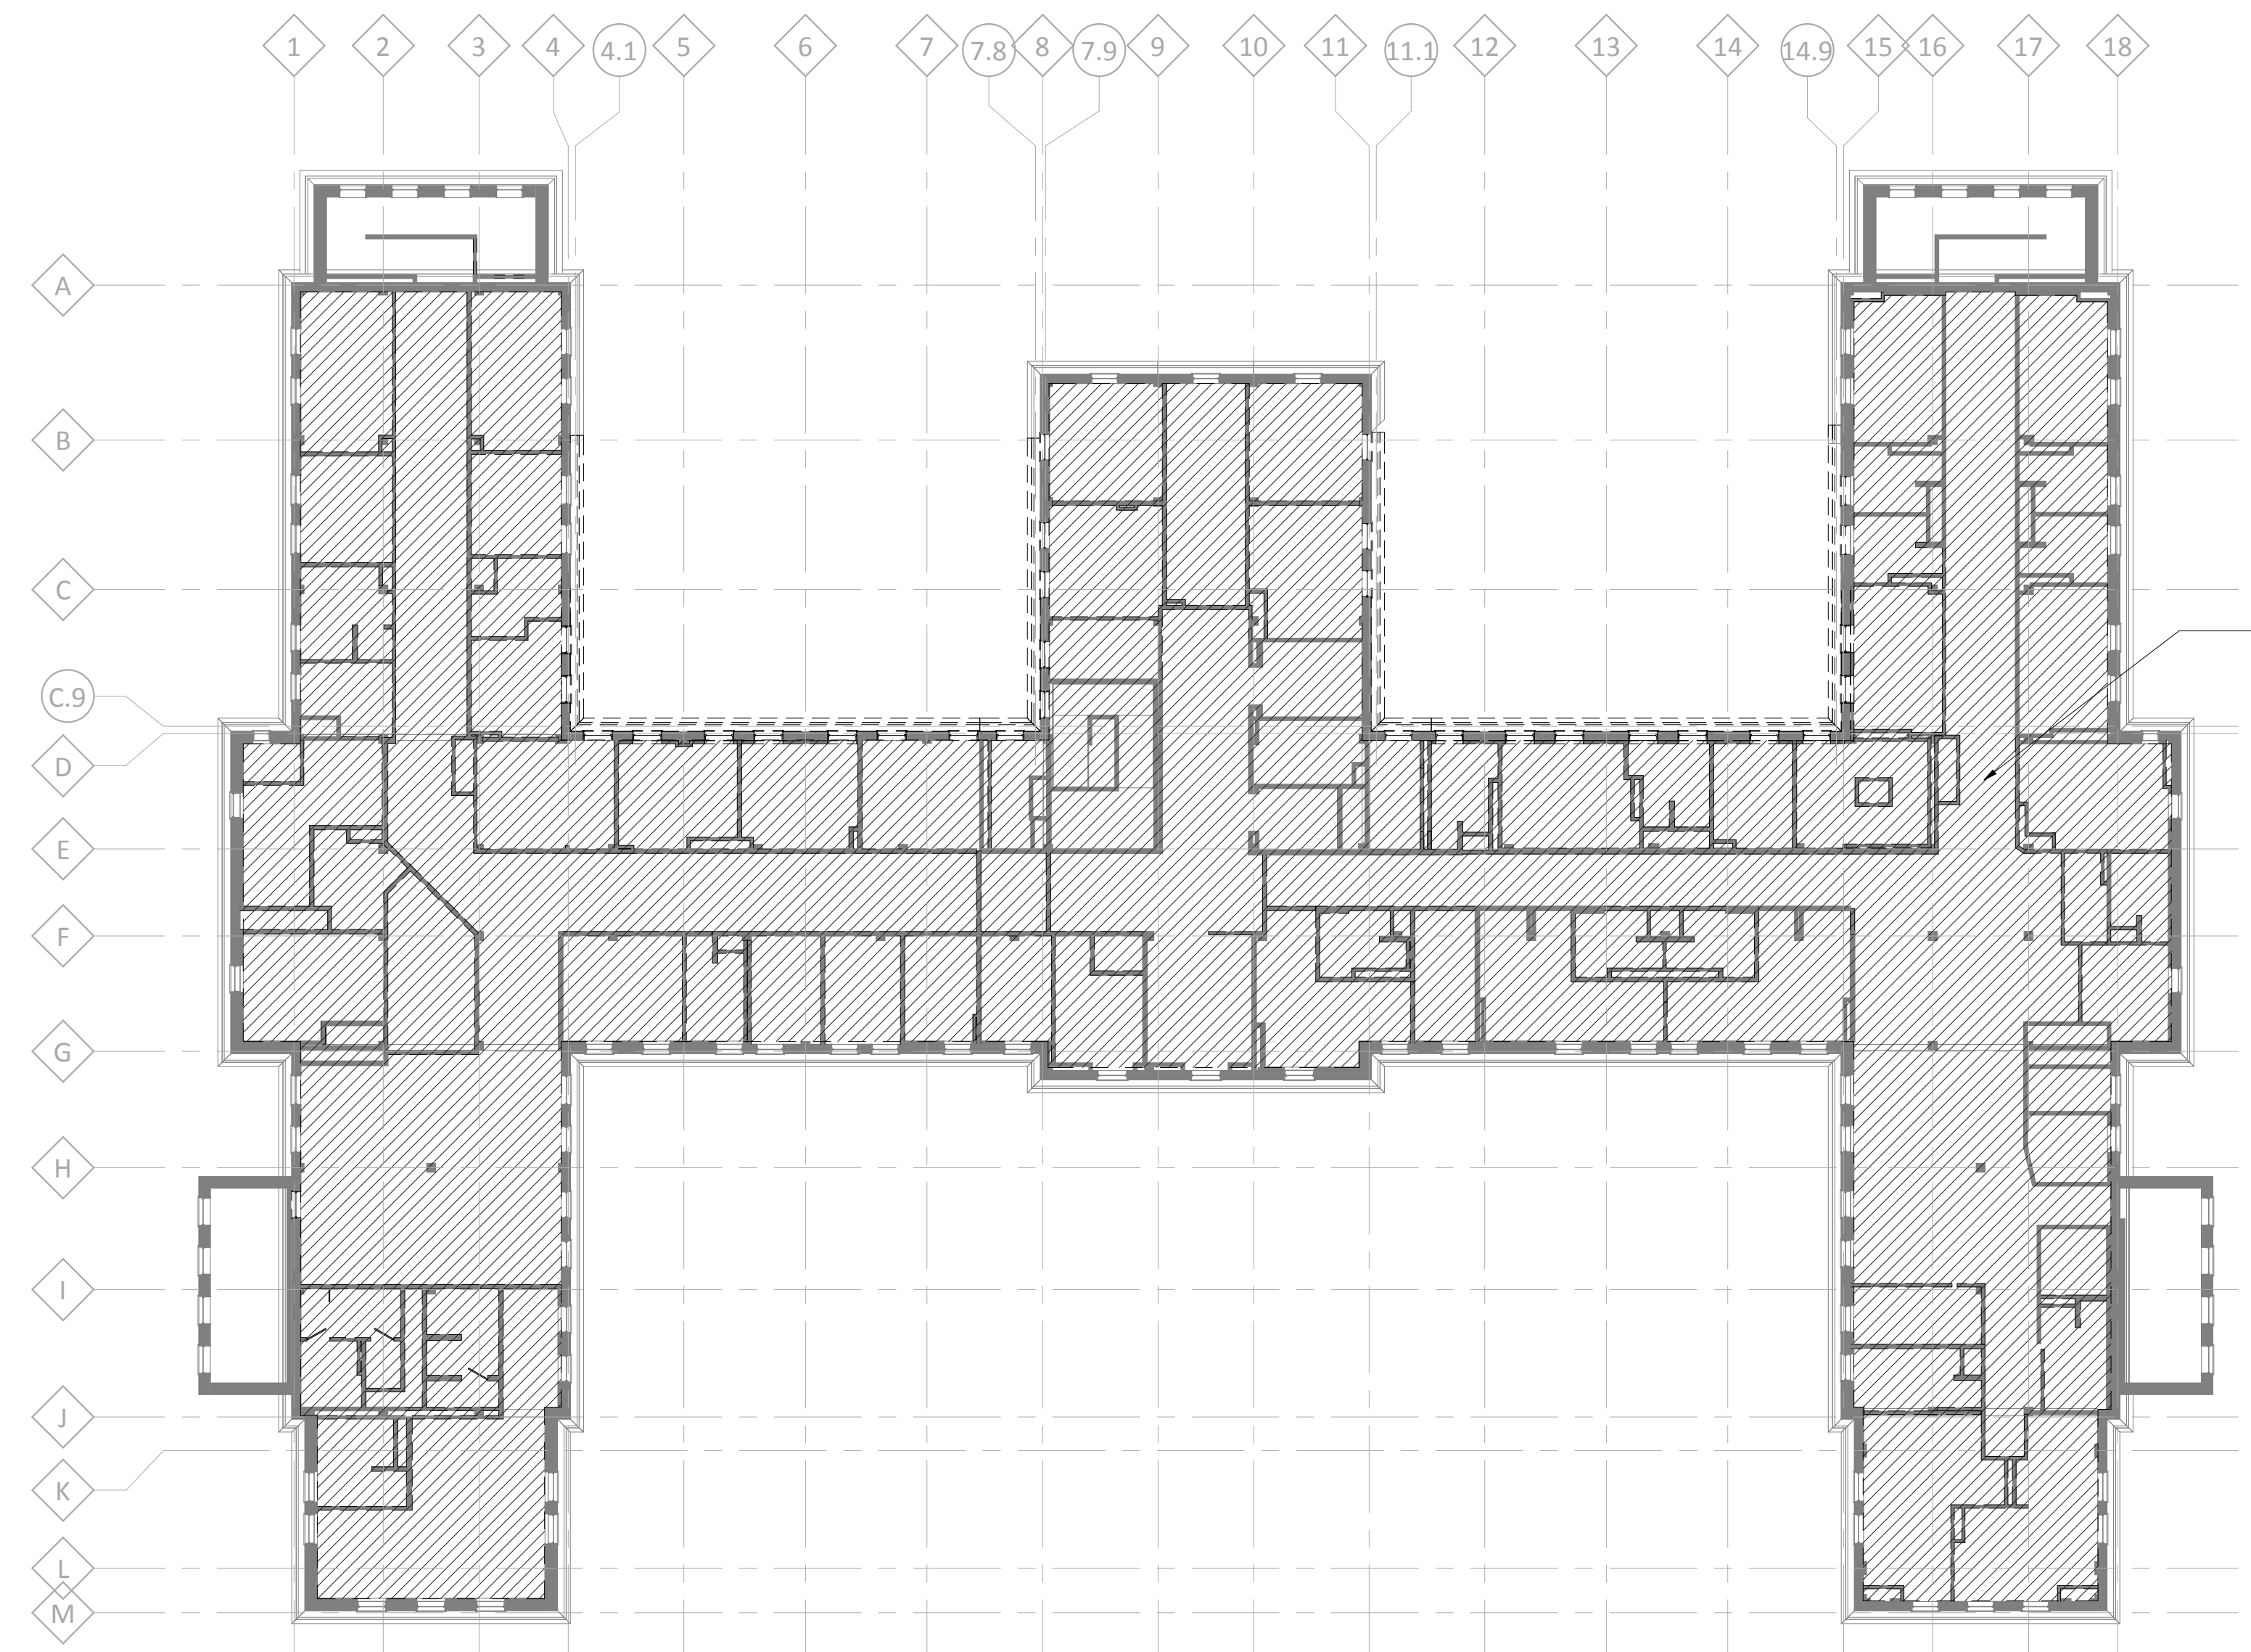100% CD SET

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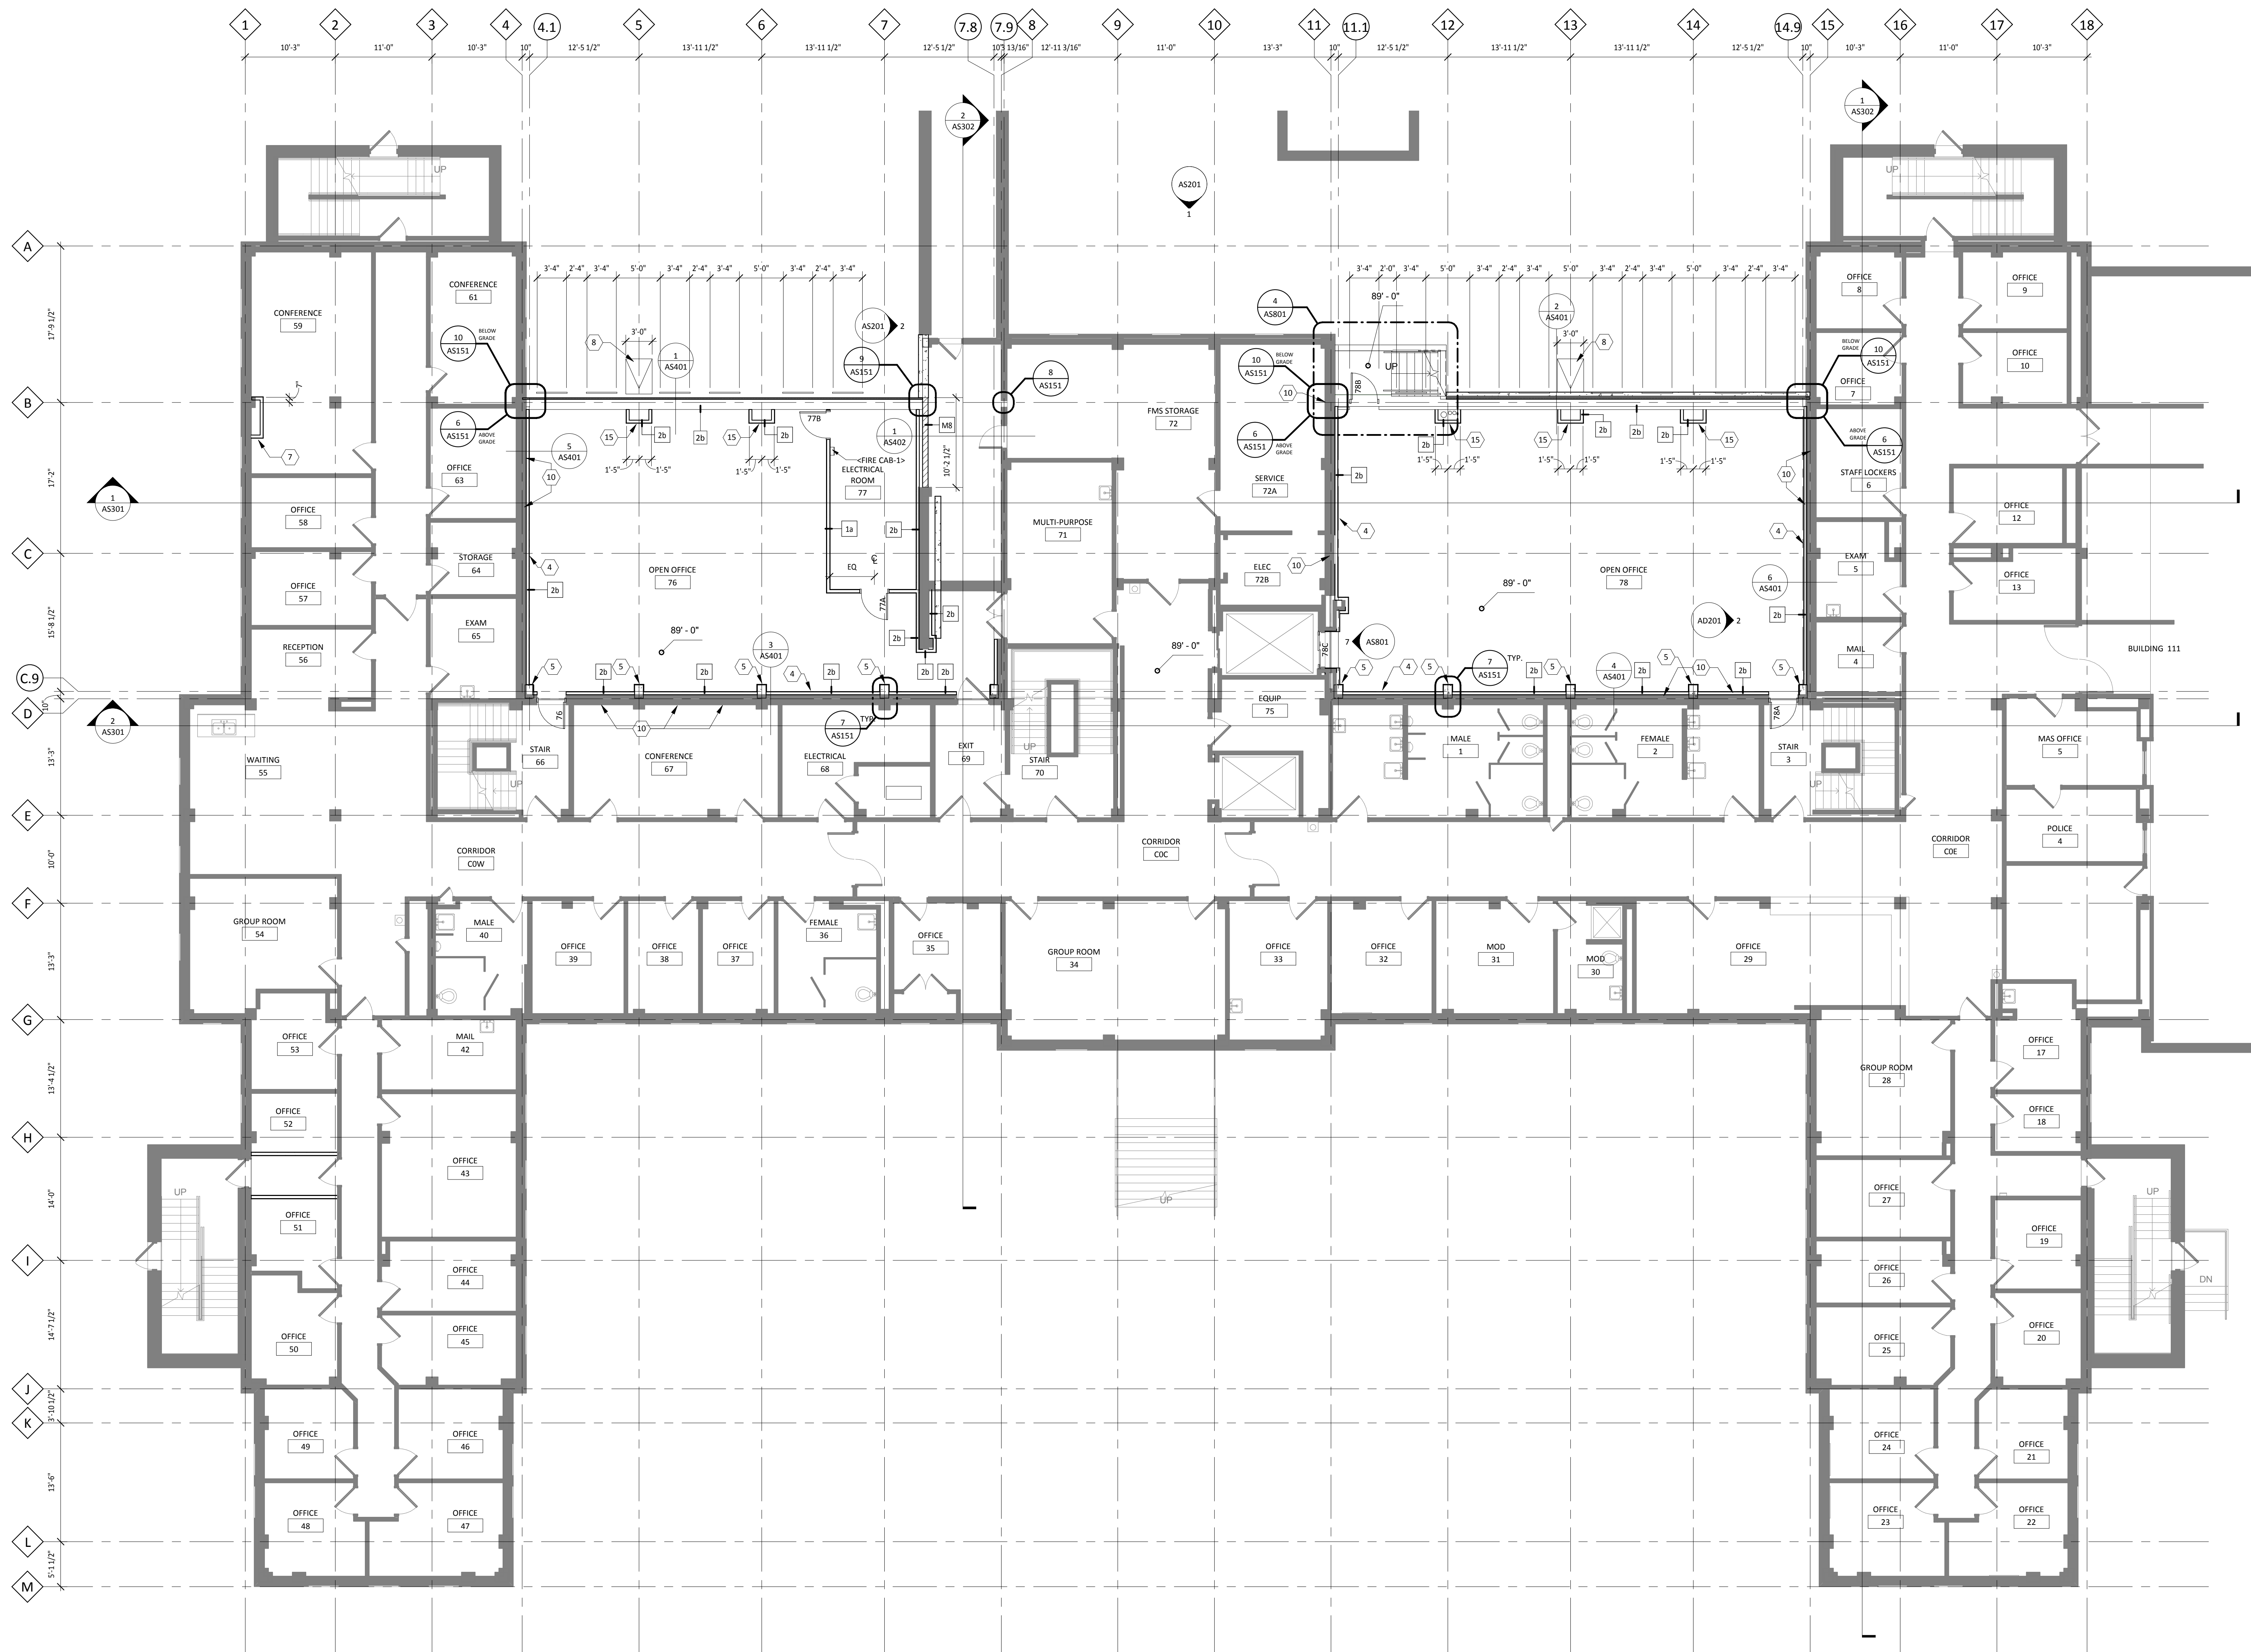
DANIEL J. MILLER, AIA
DATE: 12-20-2013
REG. NO.

DRAWING TITLE
DEMO RCP

PROJECT TITLE
RECONFIGURE/EXPAND BUILDINGS 28 & 9 FOR RESIDENTIAL REHABILITATION TREATMENT PROGRAM
BUILDING No. 28
CHECKED BY DJM
DRAWN ADB
LOCATION ST. CLOUD VA MEDICAL CENTER ST. CLOUD, MN 56303
DATE 12.20.13
AS NOTED
PROJECT NO. 656-12-329
CAD FILE
DRAWING NO. AD700

St. Cloud VA Health Care System
Brainerd | Montevideo | Alexandria

three eighths inch = one foot
one eighth inch = one foot
one quarter inch = one foot
one half inch = one foot
three quarters inch = one foot
one inch = one foot
one and one half inches = one foot
two inches = one foot
three inches = one foot
four inches = one foot
five inches = one foot
six inches = one foot
seven inches = one foot
eight inches = one foot
nine inches = one foot
ten inches = one foot
eleven inches = one foot
twelve inches = one foot
thirteen inches = one foot
fourteen inches = one foot
fifteen inches = one foot
sixteen inches = one foot
seventeen inches = one foot
eighteen inches = one foot
nineteen inches = one foot
twenty inches = one foot
twenty one inches = one foot
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twenty three inches = one foot
twenty four inches = one foot
twenty five inches = one foot
twenty six inches = one foot
twenty seven inches = one foot
twenty eight inches = one foot
twenty nine inches = one foot
thirty inches = one foot
thirty one inches = one foot
thirty two inches = one foot
thirty three inches = one foot
thirty four inches = one foot
thirty five inches = one foot
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forty inches = one foot
forty one inches = one foot
forty two inches = one foot
forty three inches = one foot
forty four inches = one foot
forty five inches = one foot
forty six inches = one foot
forty seven inches = one foot
forty eight inches = one foot
forty nine inches = one foot
fifty inches = one foot
fifty one inches = one foot
fifty two inches = one foot
fifty three inches = one foot
fifty four inches = one foot
fifty five inches = one foot
fifty six inches = one foot
fifty seven inches = one foot
fifty eight inches = one foot
fifty nine inches = one foot
sixty inches = one foot
sixty one inches = one foot
sixty two inches = one foot
sixty three inches = one foot
sixty four inches = one foot
sixty five inches = one foot
sixty six inches = one foot
sixty seven inches = one foot
sixty eight inches = one foot
sixty nine inches = one foot
seventy inches = one foot
seventy one inches = one foot
seventy two inches = one foot
seventy three inches = one foot
seventy four inches = one foot
seventy five inches = one foot
seventy six inches = one foot
seventy seven inches = one foot
seventy eight inches = one foot
seventy nine inches = one foot
eighty inches = one foot
eighty one inches = one foot
eighty two inches = one foot
eighty three inches = one foot
eighty four inches = one foot
eighty five inches = one foot
eighty six inches = one foot
eighty seven inches = one foot
eighty eight inches = one foot
eighty nine inches = one foot
ninety inches = one foot
ninety one inches = one foot
ninety two inches = one foot
ninety three inches = one foot
ninety four inches = one foot
ninety five inches = one foot
ninety six inches = one foot
ninety seven inches = one foot
ninety eight inches = one foot
ninety nine inches = one foot
one hundred inches = one foot



PLAN KEYNOTE LEGEND	
No.	Note
1	NEW INFILL FLOOR - SEE STRUCT.
2	NOT USED.
3	CUT PENETRATION THROUGH EXIST. CONCRETE FLOOR AVOIDING STRUCTURAL RIBS. REFER TO MECH. FOR DUCT INFORMATION
4	PROVIDE FURRED OUT WALL AND GWB FINISH AT EXIST. EXTERIOR WALL LOCATIONS TYP.
5	FINISH NEW PRECAST COLUMN WITH GWB FINISH. SEE PLAN DETAIL SHEET FOR MORE INFORMATION
6	CL OF PARTITION ALIGNED WITH GRIDLINE
7	ALIGN FINISHED FACE OF PARTITION WITH INSIDE FACE OF WINDOW OPENING
8	CIP CONCRETE SPLASH PAD. SLOPE AND FEATHER FOR DRAINAGE DISTRIBUTION.
10	PROVIDE BLOCK INFILL WALL AT WINDOW OPENING, MIN 1HR RATED. PROVIDE FINISHED GWB SURFACE TO MATCH EXISTING AT INTERIOR SIDE OF WALL.
11	PROVIDE NEW FURRED OUT WALL. SEE DETAILS 1 & 2/AS152
12	REINSTALL EXIST. CUH FOLLOWING COMPLETED CONSTRUCTION IN CORRIDOR
13	INSTALL NEW FACEBRICK FOLLOWING COMPLETED CONSTRUCTION OF NEW WALL BELOW
14	INFILL DEMO'D OPENING IN GABLED WALL FOLLOWING INSTALLATION OF MECHANICAL EQUIPMENT. WALL INFILL TO BE BRICK ON CMU TO MATCH EXISTING. REINSTALL WINDOW. MATCH ALL BRICK COURSING TO WALL APPEARANCE PRIOR TO DEMO.
15	ALIGN FACE OF WALL WITH FACE OF BULKHEAD ABOVE.
16	NEW WALK-OFF MAT. SEE FINISH PLANS.

FLOOR PLAN GENERAL NOTES


- A. FOR TYPICAL BARRIER FREE TOILET ROOM TYPES AND ACCESSORIES REQMTS AND LOCATIONS- SEE GENERAL INFORMATION SHEET G1004
- B. FOR TYPICAL HOUSEKEEPING CLOSETS ACCESSORIES REQMTS AND MOUNTING LOCATIONS- SEE DWG.
- C. ALL PARTITION TYPES (□) ARE "1" TYPICALLY UNLESS OTHERWISE NOTED.
- D. ALL WALLS TO RECEIVE 2" ACOUSTICAL INSULATION U.O.N. - TYPICAL.
- E. PROVIDE 6" MET STUDS PARTITIONS AT MECH. LOW EXHAUST LOCATIONS COORD. W/ MECH. DRWG'S (TYP.)
- F. TYPICALLY INSTALL SOAP DISPENSERS AND PAPER TOWEL DISPENSER AT ALL SINKS UNLESS NOTED OTHERWISE.
- G. PROVIDE WALL REINFORCEMENT AT WALL-MOUNTED SHELVES AND STORAGE UNITS, MARKERBOARDS, BULLETIN BOARDS, TACK BOARDS, TELEVISIONS AND OTHER CONTRACTOR OR OWNER FURNISHED WALL-MOUNTED ITEMS. COORDINATE WITH COR.
- H. FOR ALL CARPET TYPE CHANGES BETWEEN ROOMS- TRANSITION SHALL OCCUR AT CENTERLINE OF DOOR FRAME TYPICALLY - U.O.N.
- I. COORDINATE DIMENSIONS W/ ASTERISK (IE - "X'-X") W/ EQUIPMENT VENDOR.
- J. PROVIDE BULLNOSED CORNERS ON ALL CMU WALLS - TYPICAL.
- K. ALL DIMENSIONS ARE TO FACE OF STUD OR MASONRY UNLESS OTHERWISE NOTED.
- L. COORDINATE PARTITION FIRE RATED REQUIREMENTS AS INDICATED ON CODE SHEET G1001

NOTE: COORDINATE ALL FLOOR OPENING DIMENSIONS AND CLEARANCES FOR DUCTWORK W/ MECHANICAL CONTRACTOR - TYPICAL

1 BASEMENT FLOOR PLAN
1/8" = 1'-0"

No.	REVISION	DATE

VA FORM 28-6231

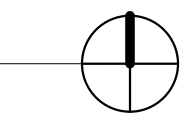

JLG 11129

STAMPED
DESIGNED BY
DANIEL J. MILLER, AIA
DATE: 12-20-2013

DRAWING TITLE
BASEMENT FLOOR PLAN

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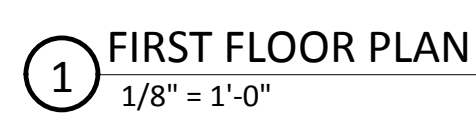
PROJECT TITLE
RECONFIGURE/EXPAND
BUILDINGS 28 & 9 FOR
RESIDENTIAL REHABILITATION
TREATMENT PROGRAM

BUILDING No. 28
DESIGNED BY DJM
DRAWN ADB

DATE 12.20.13
PROJECT NO. 656-12-329

DRAWING NO. AS100





FLOOR PLAN GENERAL NOTES

- A. FOR TYPICAL BARRIER FREE TOILET ROOM TYPES AND ACCESSORIES REQ'TS MTS AND LOCATIONS- SEE GENERAL INFORMATION SHEET C1004
- B. FOR TYPICAL HOUSEKEEPING CLOSETS ACCESSORIES REQ'TS AND MOUNTING LOCATIONS- SEE DWG.
- C. ALL PARTITION TYPES (□) ARE 1" TYPICALLY UNLESS OTHERWISE NOTED.
- D. ALL WALLS TO RECEIVE 2" ACoustICAL INSULATION U.O.N. - TYPICAL.
- E. PROVIDE 6" MET STUDS PARTITIONS AT MECH. LOW DRWG LOCATIONS- COORD. W/ MECH. DRWG'S (TYP.)
- F. TYPICALLY INSTALL SOAP DISPENSERS AND PAPER TOWEL DISPENSER AT ALL SINKS UNLESS NOTED OTHERWISE.
- G. PROVIDE WALL REINFORCEMENT AT WALL-MOUNTED SHELVES AND STORAGE UNITS, MARKERBOARDS, BILLBOARD LOCARDS, TACK BOARDS, TELEVISIONS AND OTHER CONTRACTOR OR OWNER FURNISHED WALL-MOUNTED ITEMS. COORDINATE WITH COR.
- H. FOR ALL CARPET TYPE CHANGES BETWEEN ROOMS- TRANSITION SHALL OCCUR AT CENTERLINE OF DOOR FRAME TYPICALLY - U.O.N.
- I. COORDINATE DIMENSIONS W/ ASTERISK (IE "X-X") W/ EQUIPMENT VENDOR.
- J. PROVIDE BULLEDGED CORNERS ON ALL CMW WALLS - TYPICAL.
- K. ALL DIMENSIONS ARE TO FACE OF STUD OR MASONRY UNLESS OTHERWISE NOTED.
- L. COORDINATE PARTITION FIRE RATED REQUIREMENTS AS INDICATED ON COAT SHEET G1001

NOTE: COORDINATE ALL FLOOR OPENING
DIMENSIONS AND CLEARANCES FOR DUCTWORK
W/ MECHANICAL CONTRACTOR - TYPICAL.

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**FOR
CONSTRUCTION**




St. Cloud VA
Health Care System
Brainerd | Montevideo | Alexandria

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architects

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DANIEL J. O'CONNEL
DATE:

DRAWING TITLE

FIRST FLOOR PLAN


PROJECT TITLE	RECONFIGURE/EXPAND BUILDINGS 28 & 9 FOR RESIDENTIAL REHABILITATION TREATMENT PROGRAM
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BUILDING NO	CHECKED BY	DRAWN
28	DJM	AL
LOCATION		
ST. CLOUD VA MEDICAL CENTER		
ST. CLOUD, MN 56303		

DATE	12.20.13
PLOT SCALE	AS NOTED
PROJECT NO.	656-12-339
CAD FILE	
BRAND NAME	

JLG 11129

one eighth inch = one foot
one quarter inch = one foot
three eighths inch = one foot
one half inch = one foot
three quarters inch = one foot
one inch = one foot
one and one half inches = one foot
two inches = one foot
three inches = one foot

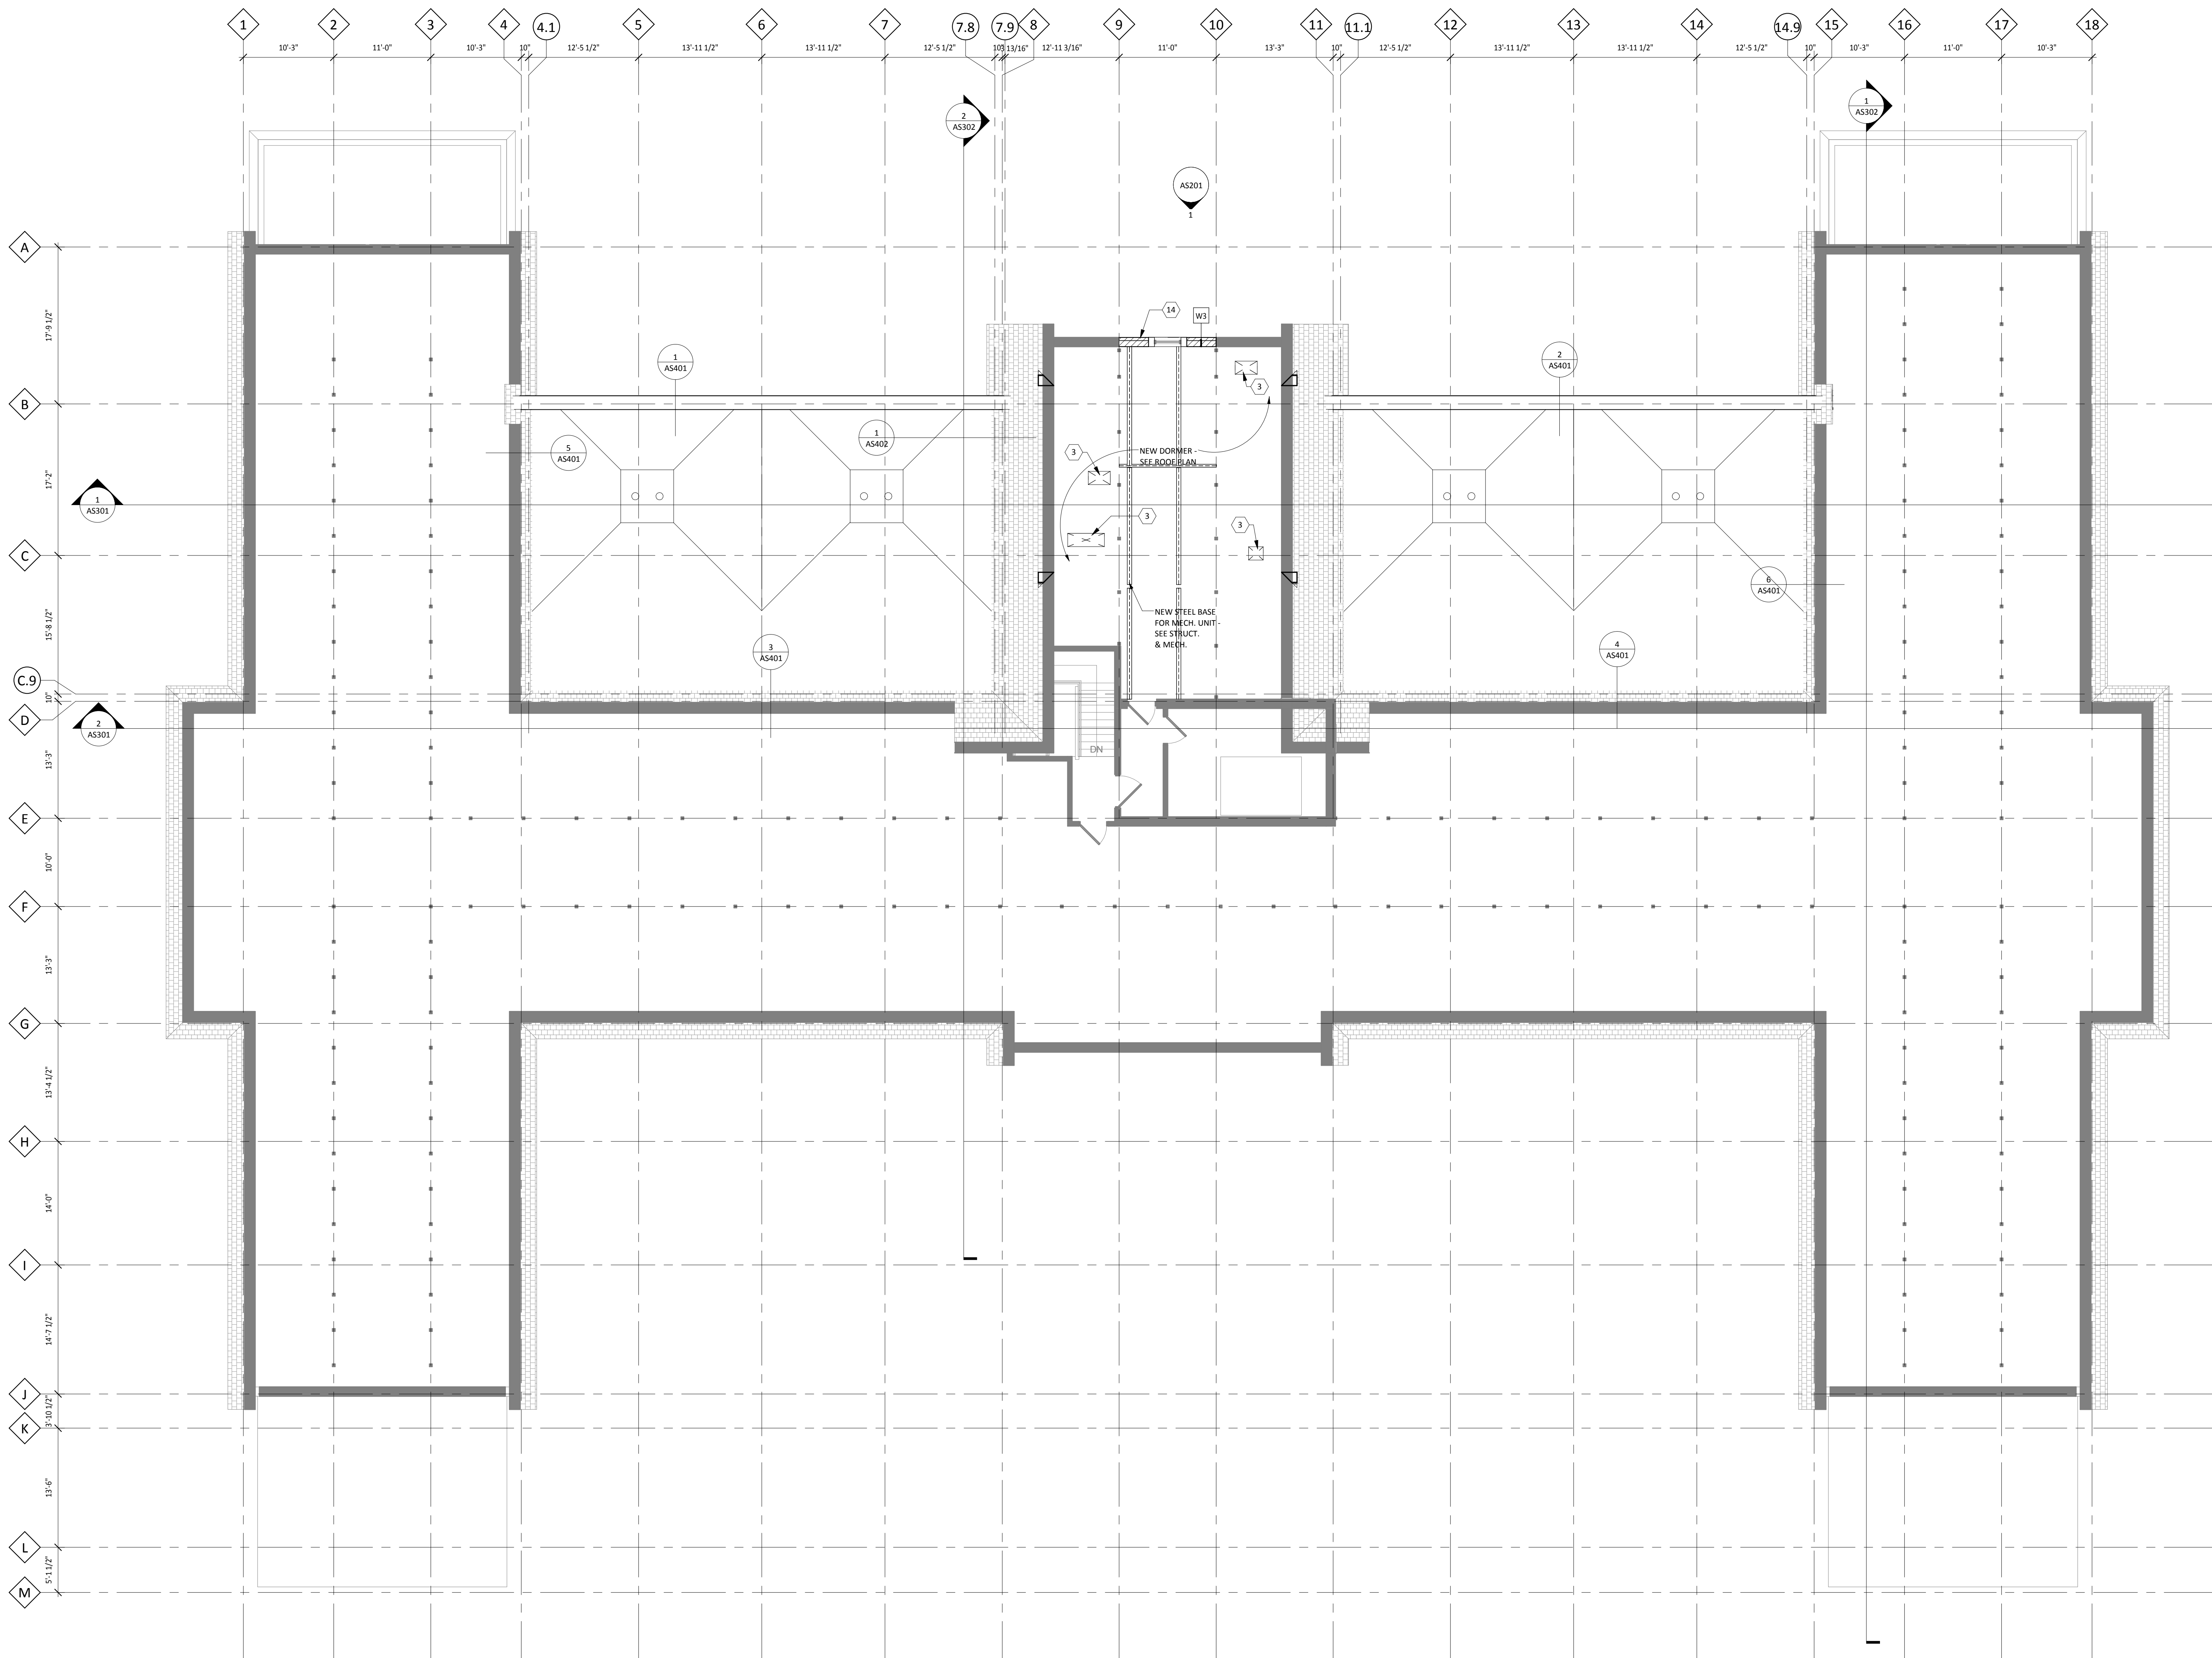

1 ATTIC FLOOR PLAN
1/8" = 1'-0"

PLAN KEYNOTE LEGEND	
No.	Note
1	NEW INFILL FLOOR - SEE STRUCT.
2	NOT USED.
3	CUT PENETRATION THROUGH EXIST. CONCRETE FLOOR AVOIDING STRUCTURAL RIBS. REFER TO MECH. FOR DUCT. INFORMATION
4	PROVIDE FURRED OUT WALL AND GWB FINISH AT EXIST. EXTERIOR WALL LOCATIONS TYP.
5	FINISH NEW PRECAST COLUMN WITH GWB FINISH. SEE PLAN DETAIL SHEET FOR MORE INFORMATION
6	CL OF PARTITION ALIGNED WITH GRIDLINE
7	ALIGN FINISHED FACE OF PARTITION WITH INSIDE FACE OF WINDOW OPENING
8	CIP CONCRETE SPLASH PAD. SLOPE AND FEATHER FOR DRAINAGE DISTRIBUTION.
10	PROVIDE BLOCK INFILL WALL AT WINDOW OPENING, MIN 1HR RATED. PROVIDE FINISHED GWB SURFACE TO MATCH EXISTING AT INTERIOR SIDE OF WALL.
11	PROVIDE NEW FURRED OUT WALL. SEE DETAILS 1 & 2/AS152
12	REINSTATE EXIST. CUH FOLLOWING COMPLETED CONSTRUCTION IN CORRIDOR
13	INSTALL NEW FACEBRICK FOLLOWING COMPLETED CONSTRUCTION OF NEW WALL BELOW
14	INFILL DEMO'D OPENING IN GABLED WALL FOLLOWING INSTALLATION OF MECHANICAL EQUIPMENT. WALL INFILL TO BE BRICK ON CMU TO MATCH EXISTING. REINSTALL WINDOW. MATCH ALL BRICK COURSING TO WALL APPEARANCE PRIOR TO DEMO.
15	ALIGN FACE OF WALL WITH FACE OF BULKHEAD ABOVE.
16	NEW WALK-OFF MAT. SEE FINISH PLANS.

FLOOR PLAN GENERAL NOTES

- A. FOR TYPICAL BARRIER FREE TOILET ROOM TYPES AND ACCESSORIES REQMTS AND LOCATIONS- SEE GENERAL INFORMATION SHEET G1004
- B. FOR TYPICAL HOUSEKEEPING CLOSETS ACCESSORIES REQMTS AND MOUNTING LOCATIONS- SEE DWG.
- C. ALL PARTITION TYPES (E-T) ARE "1" TYPICALLY UNLESS OTHERWISE NOTED.
- D. ALL WALLS TO RECEIVE 2" ACOUSTICAL INSULATION U.G.N. - TYPICAL.
- E. PROVIDE 6" MET STUD PARTITIONS AT MECH. LOW EXHAUST LOCATIONS COORD. W/ MECH. DRWG'S (TYP.)
- F. TYPICALLY INSTALL SOAP DISPENSERS AND PAPER TOWEL DISPENSER AT ALL SINKS UNLESS NOTED OTHERWISE.
- G. PROVIDE WALL REINFORCEMENT AT WALL-MOUNTED SHELVES AND STORAGE UNITS, MARKERBOARDS, BULLETIN BOARDS, TACK BOARDS, TELEVISIONS AND OTHER CONTRACTOR OR OWNER FURNISHED WALL-MOUNTED ITEMS. COORDINATE WITH COR.
- H. FOR ALL CARPET TYPE CHANGES BETWEEN ROOMS- TRANSITION SHALL OCCUR AT CENTERLINE OF DOOR FRAME TYPICALLY - U.N.O.
- I. COORDINATE DIMENSIONS W/ ASTERISK (E - "X"-X") W/ EQUIPMENT VENDOR.
- J. PROVIDE BULLNOSED CORNERS ON ALL CMU WALLS - TYPICAL.
- K. ALL DIMENSIONS ARE TO FACE OF STUD OR MASONRY UNLESS OTHERWISE NOTED.
- L. COORDINATE PARTITION FIRE RATED REQUIREMENTS AS INDICATED ON CODE SHEET G1001
- NOTE: COORDINATE ALL FLOOR OPENING DIMENSIONS AND CLEARANCES FOR DUCTWORK W/ MECHANICAL CONTRACTOR- TYPICAL.

No.	REVISION	DATE

VA FORM 08-6231



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DESIGNED BY: [Signature]
CHECKED BY: [Signature]
DATE: 12-20-2013
MIN. 42819
REG. NO.

DRAWING TITLE
ATTIC PLAN

PROJECT TITLE
RECONFIGURE/EXPAND
BUILDINGS 28 & 9 FOR
RESIDENTIAL REHABILITATION
TREATMENT PROGRAM

BUILDING No. 28
DESIGNED BY DJM
CHECKED BY ADB

LOCATION
ST. CLOUD VA MEDICAL CENTER
ST. CLOUD, MN 56303

DATE 12.20.13
PROJECT NO. 656-12-339
DRAWING NO. AS103



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CONSTRUCTION

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4.25 INDICATES APPROX. THICKNESS OF INSULATION (INCHES) ABOVE SUMP ELEVATION


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DANIEL J. MILLER, AIA
DATE: 12-26-2012






DRAWING TITLE
ROOF PLAN

PROJECT TITLE	RECONFIGURE/EXPAND BUILDINGS 28 & 9 FOR RESIDENTIAL REHABILITATION TREATMENT PROGRAM
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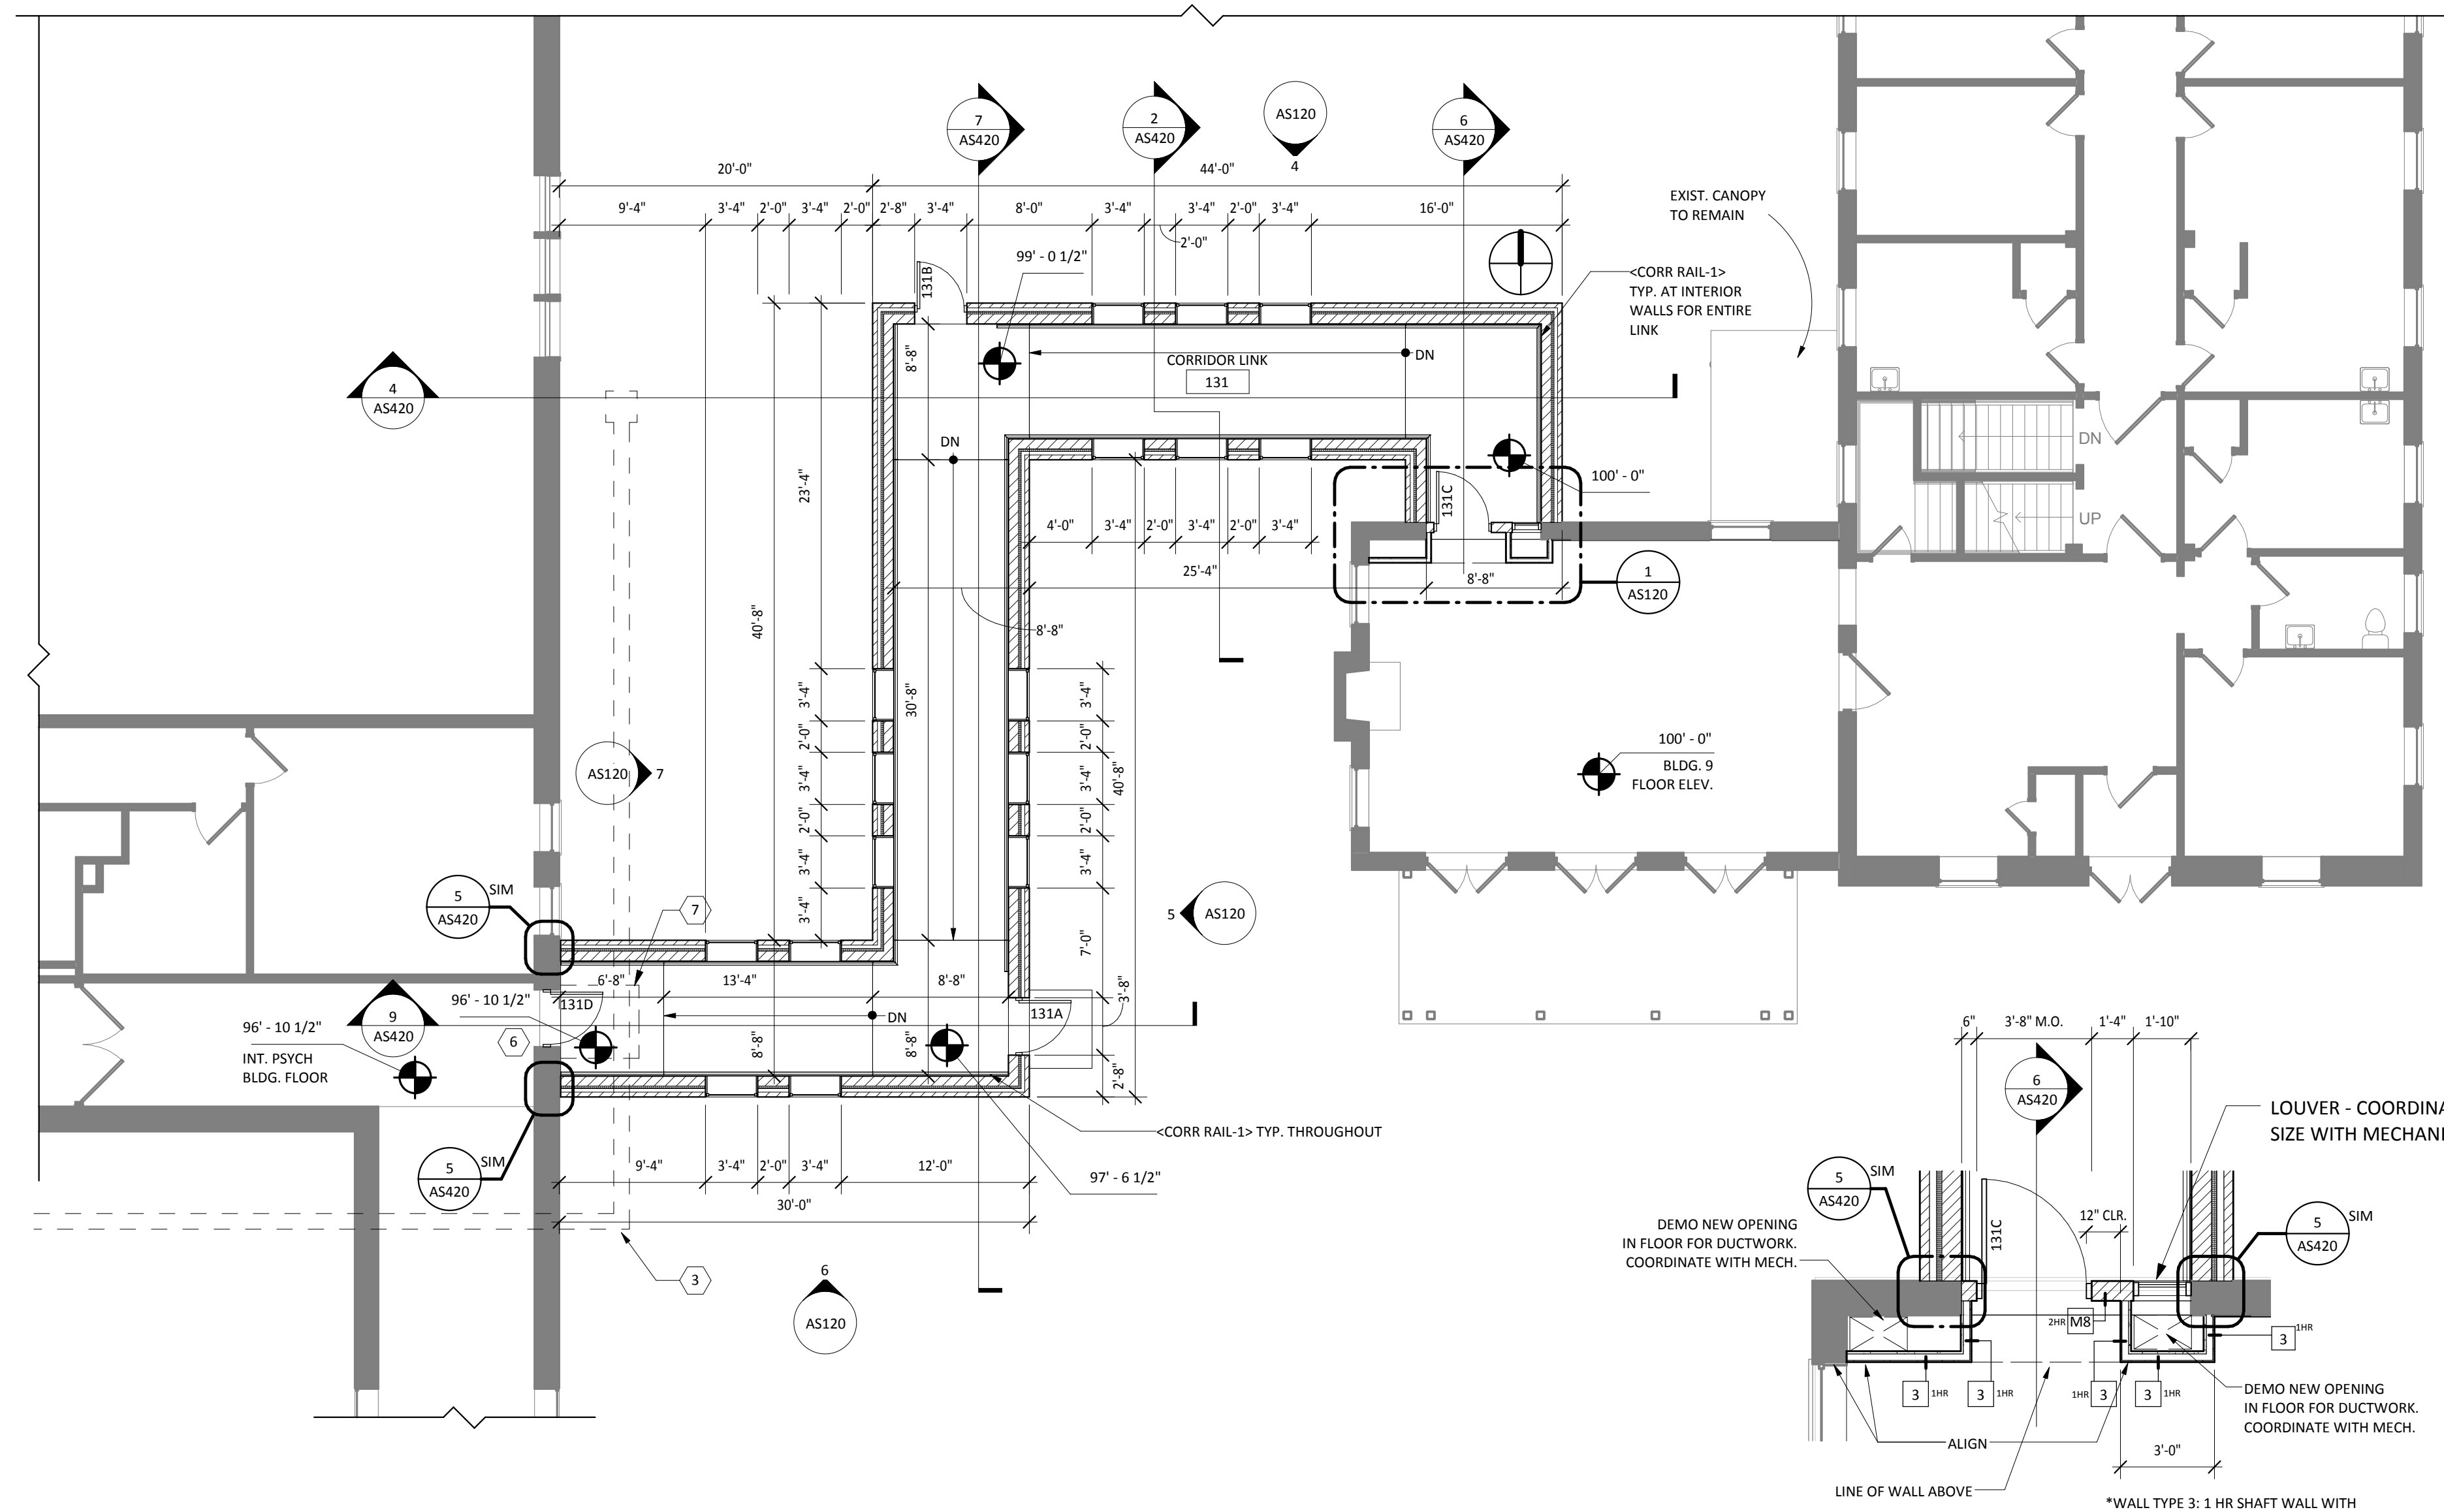
BUILDING No	CHECKED BY	DRAWN
28	DJM	AL
LOCATION		
ST. CLOUD VA MEDICAL CENTER		
ST. CLOUD, MN 56303		

DATE	12.20.13
PLOT SCALE	AS NOTED
PROJECT NO.	656-12-339


	CAD FILE
3	DRAWING NO. 16104

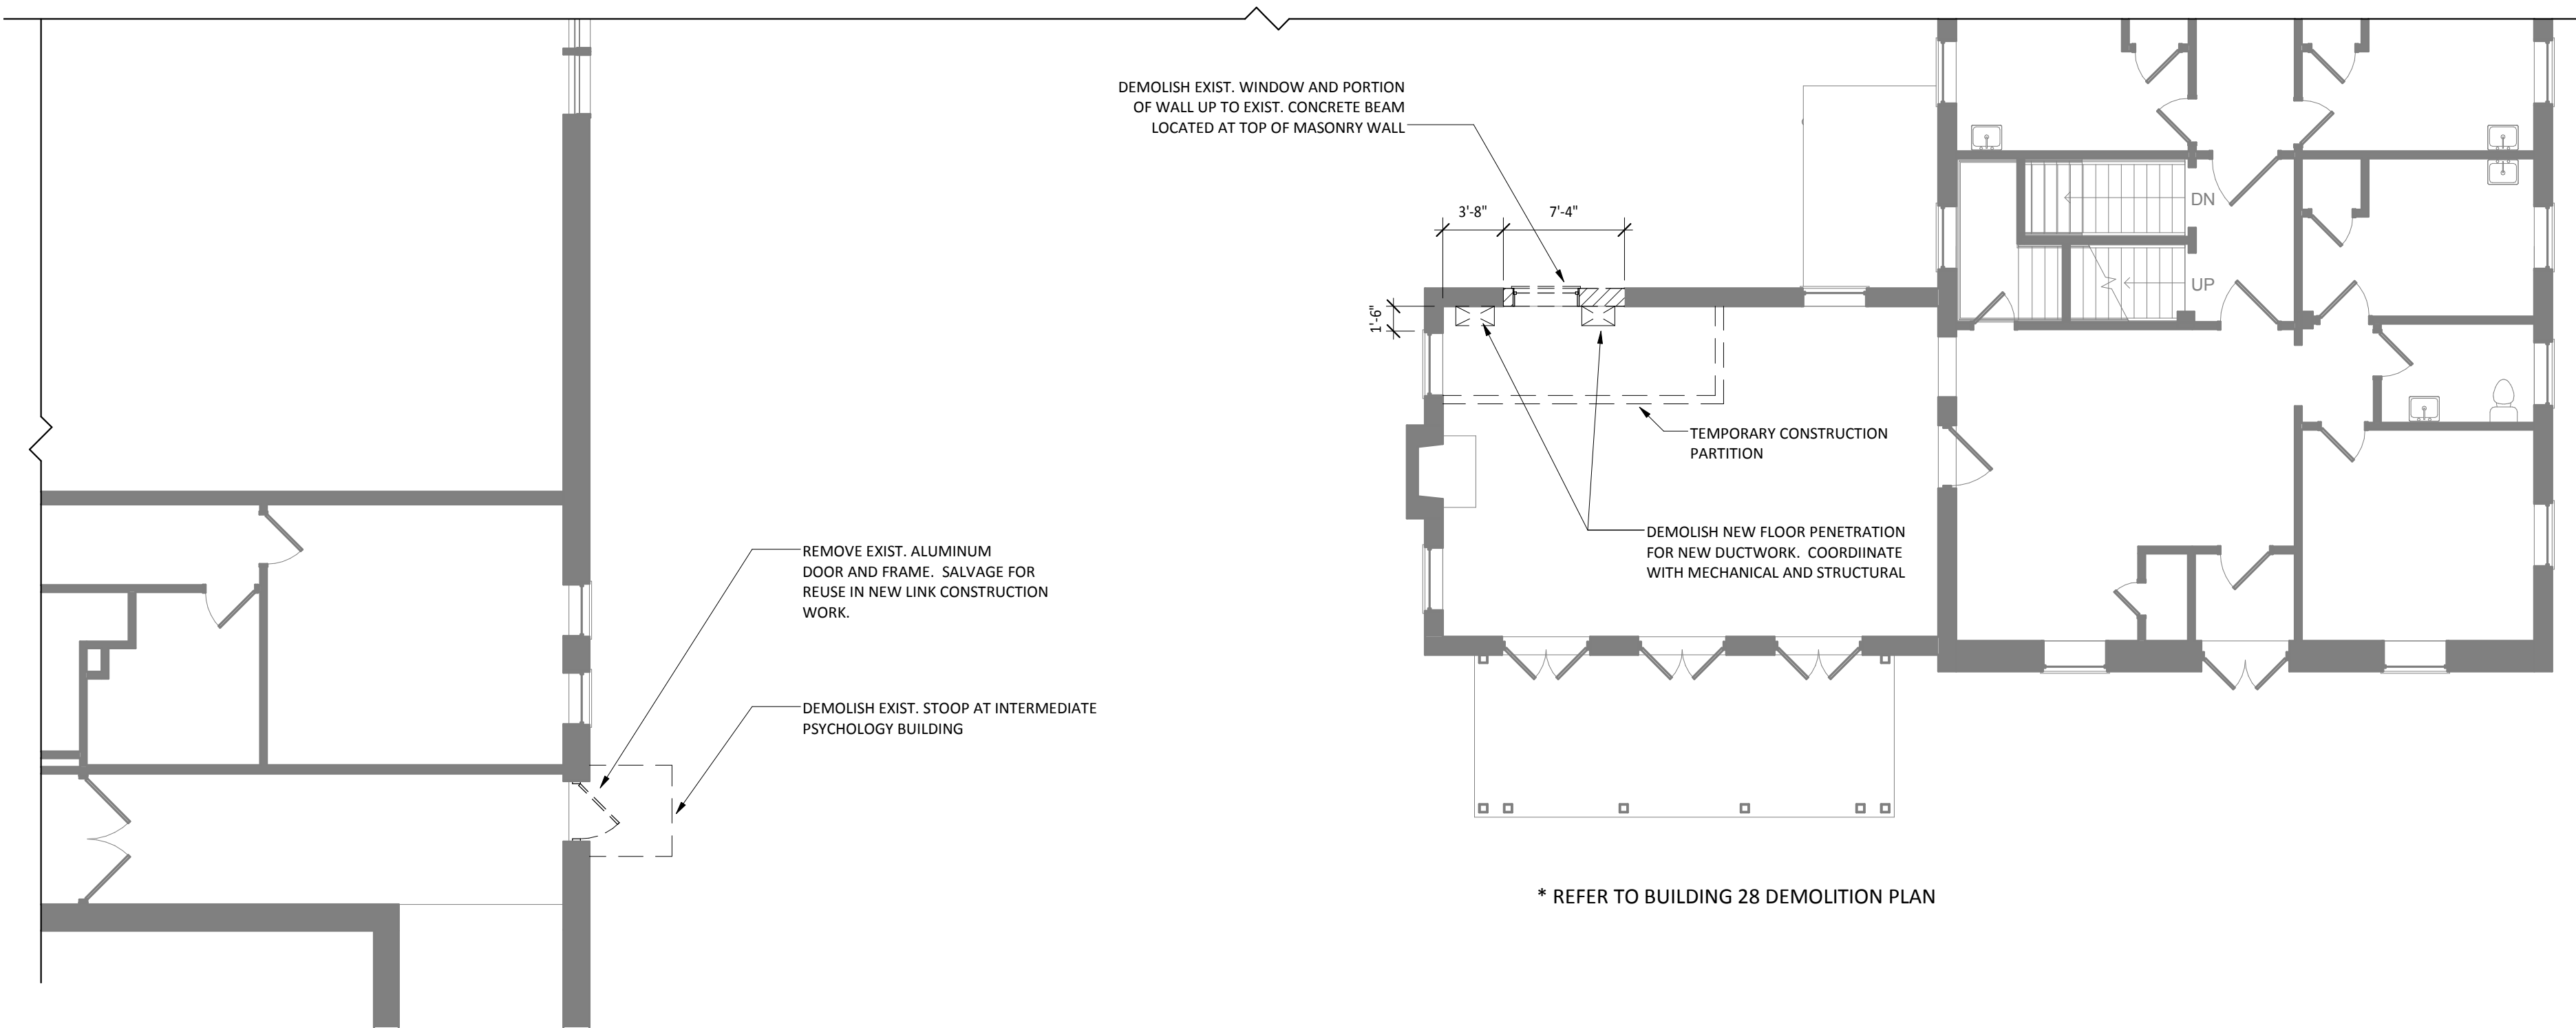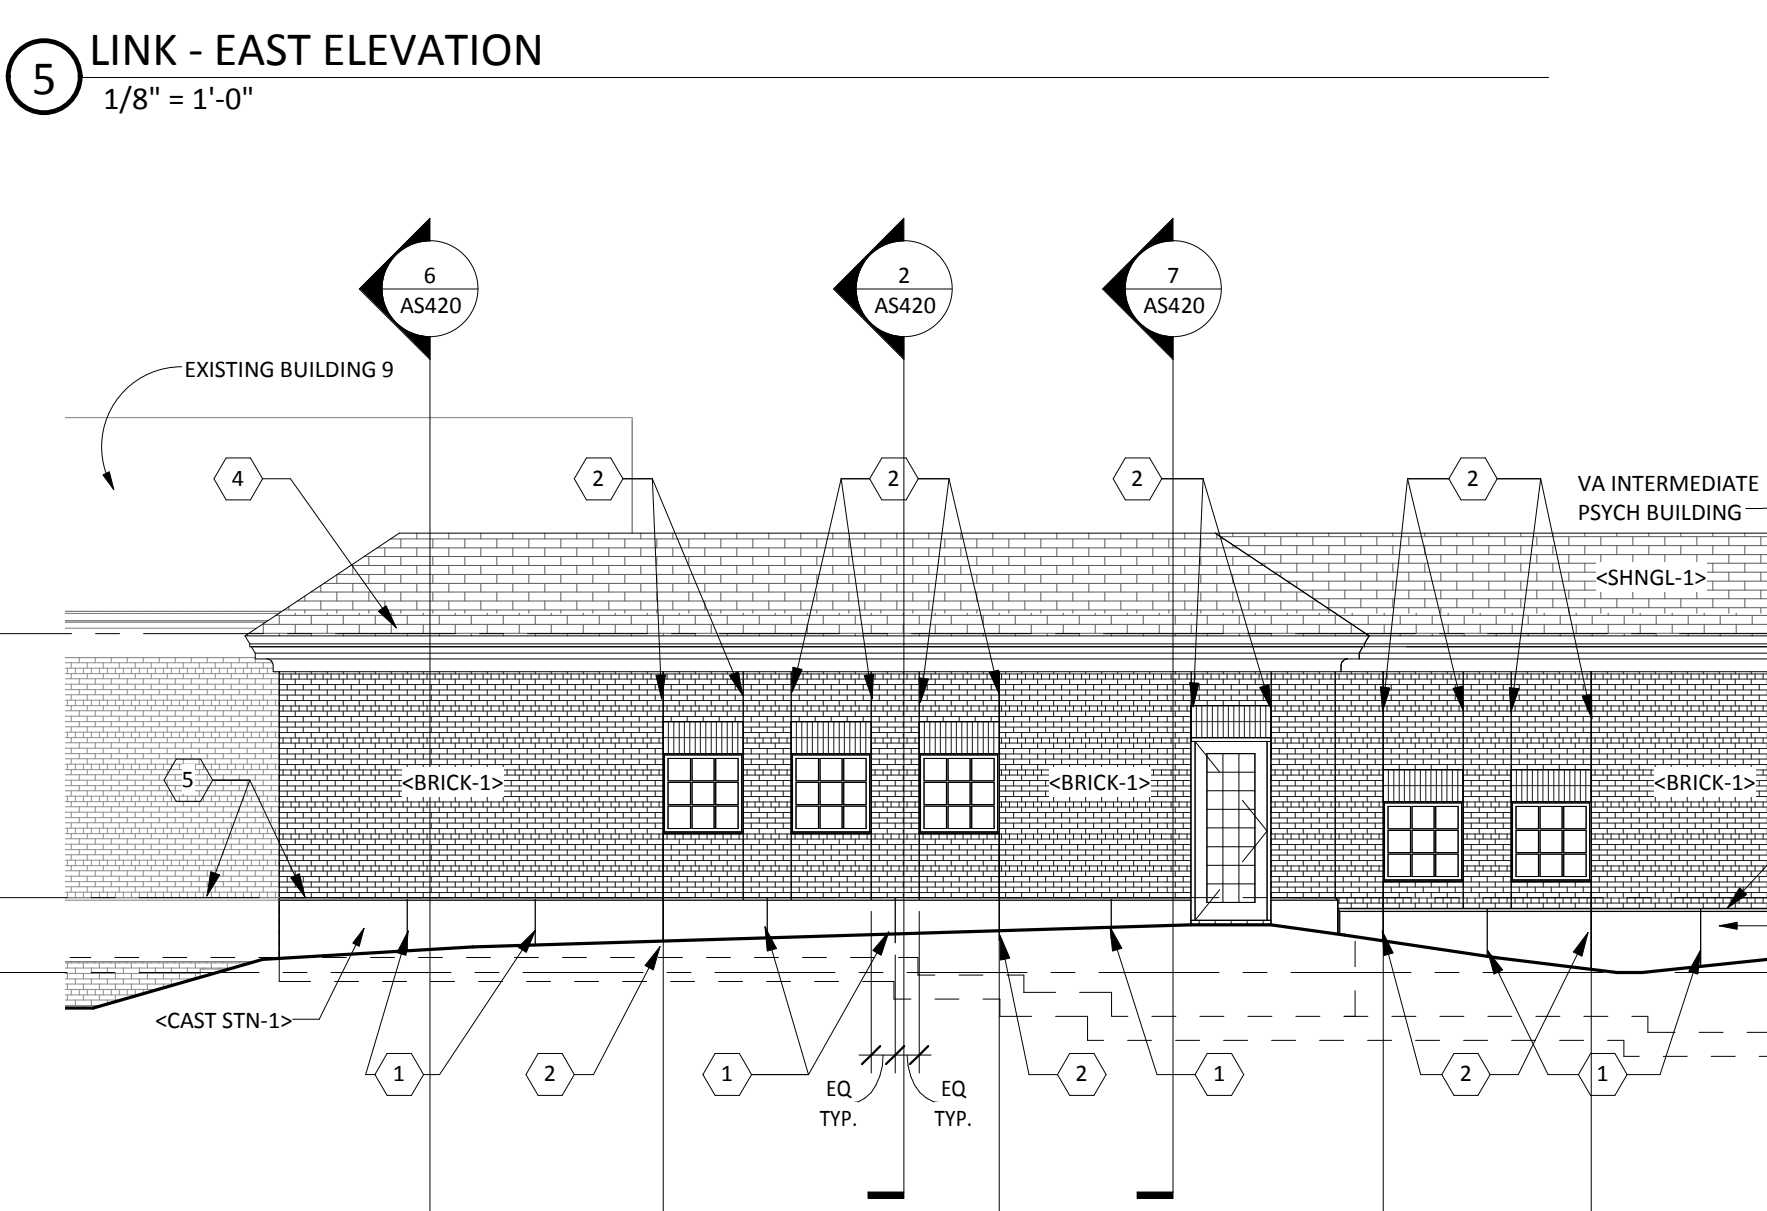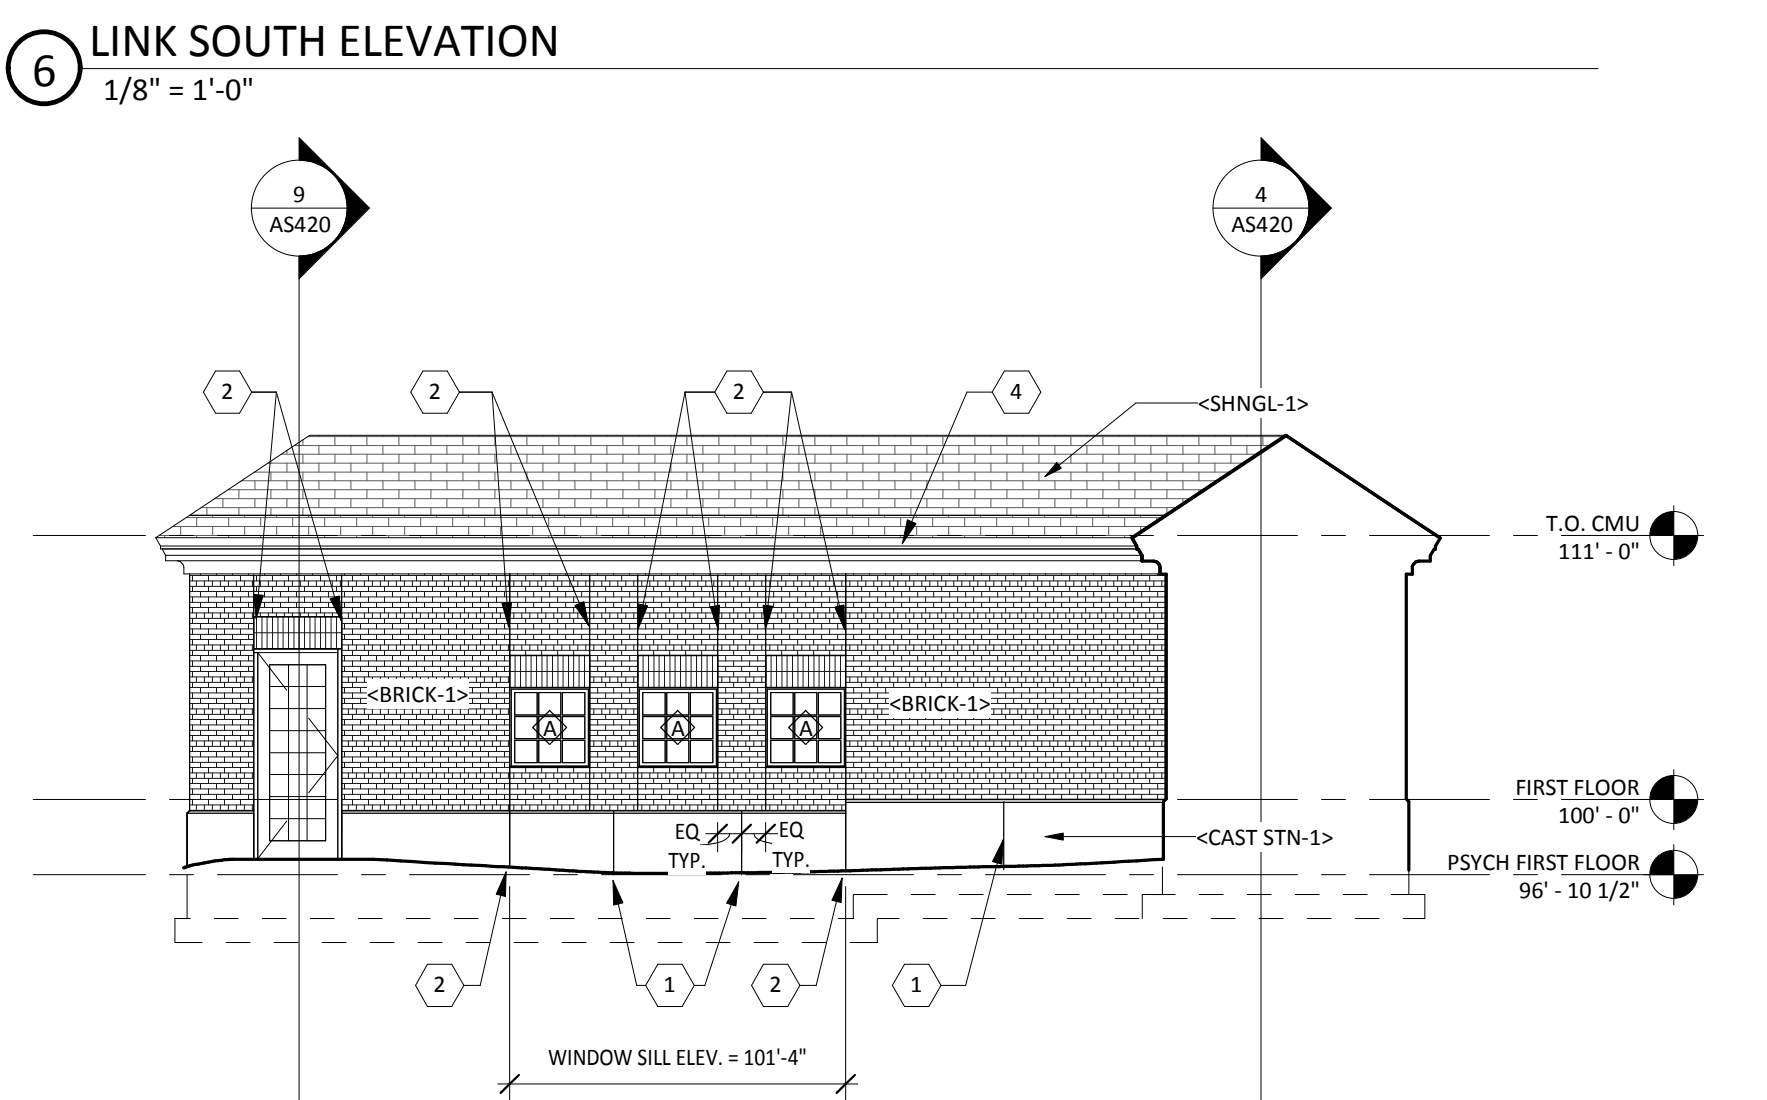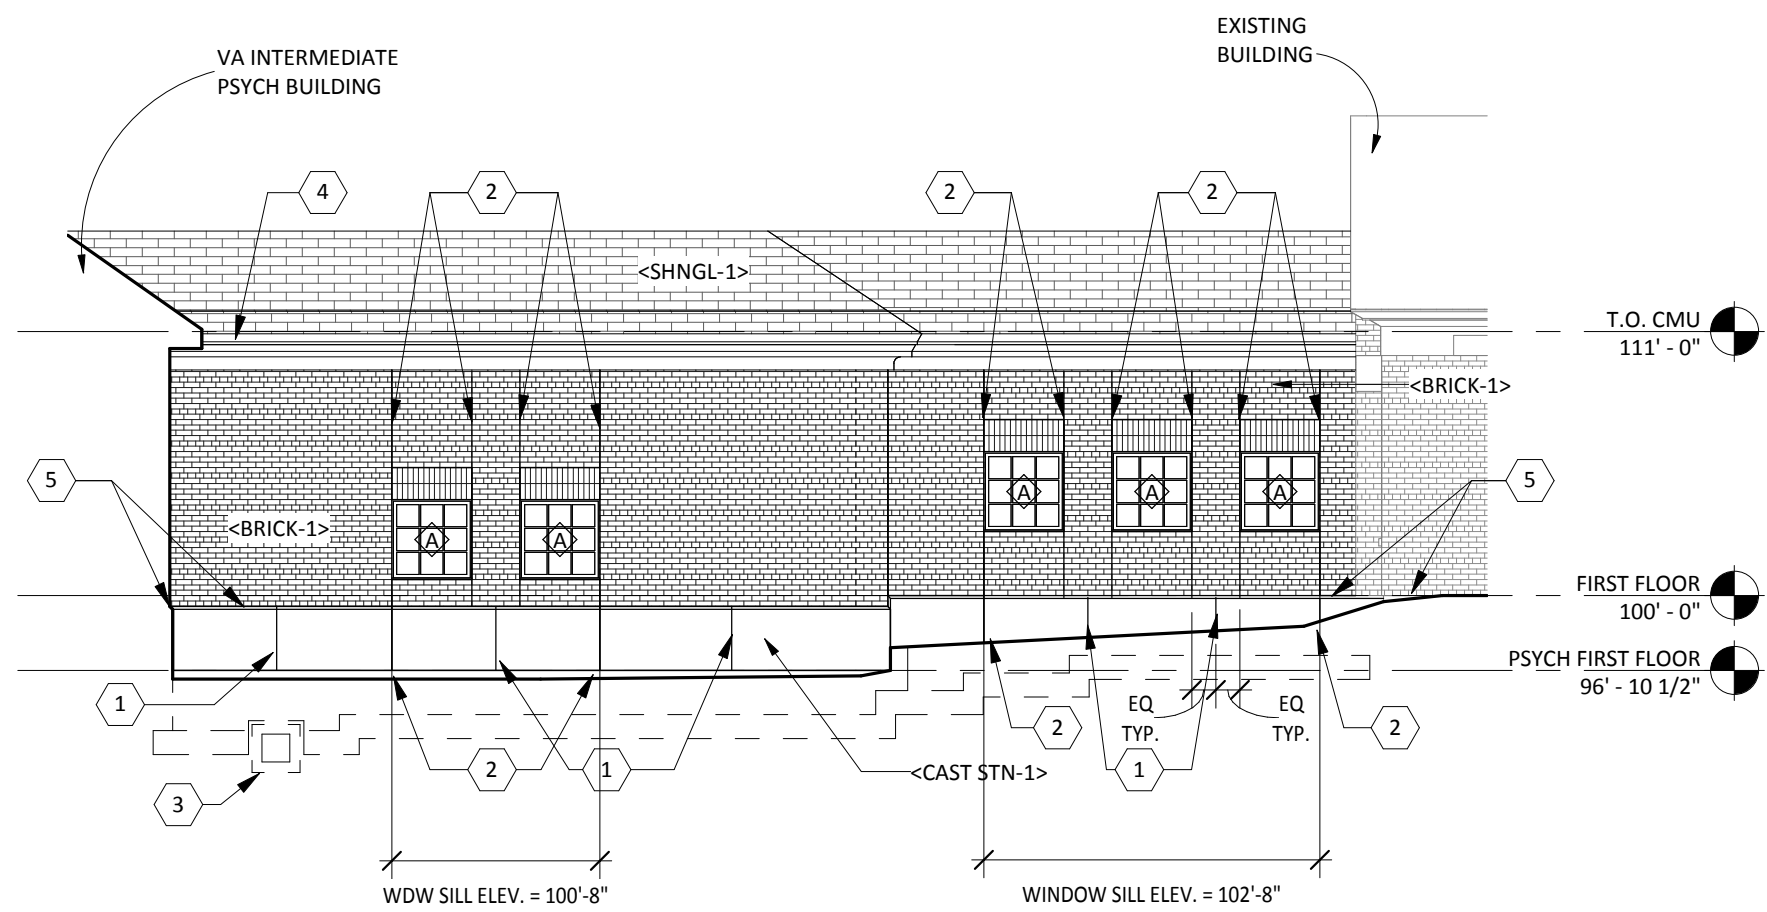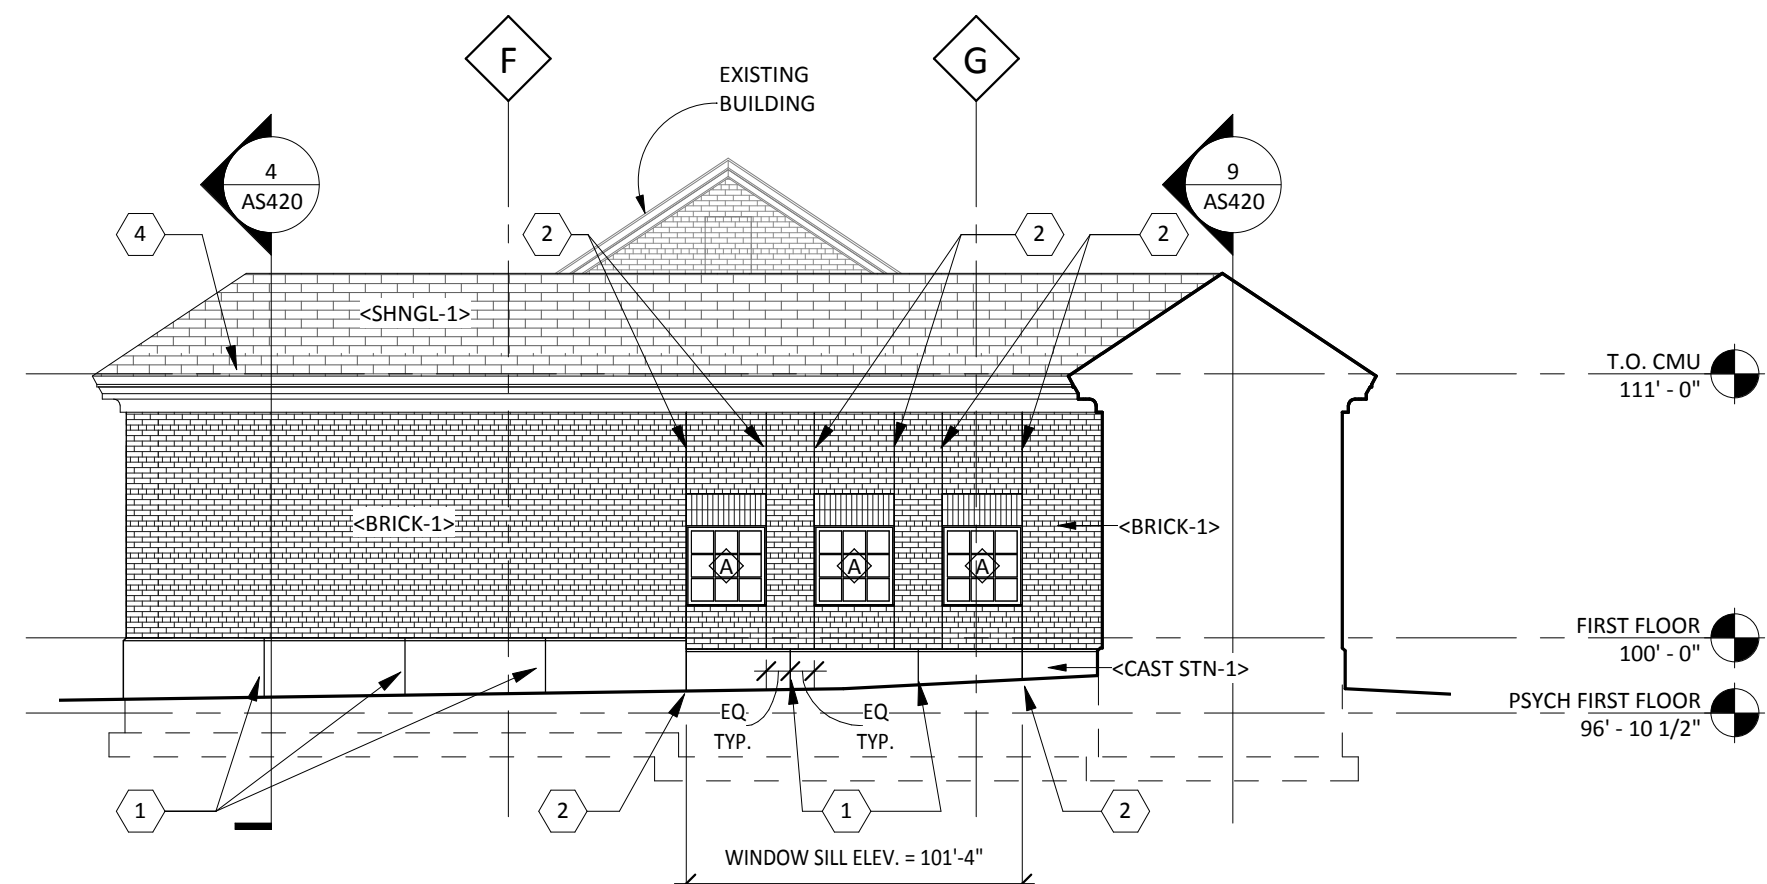

3 FIRST FLOOR DEMOLITION PLAN
1/8" = 1'-0"



2 LINK CONNECTION PLAN
1/8" = 1'-0"

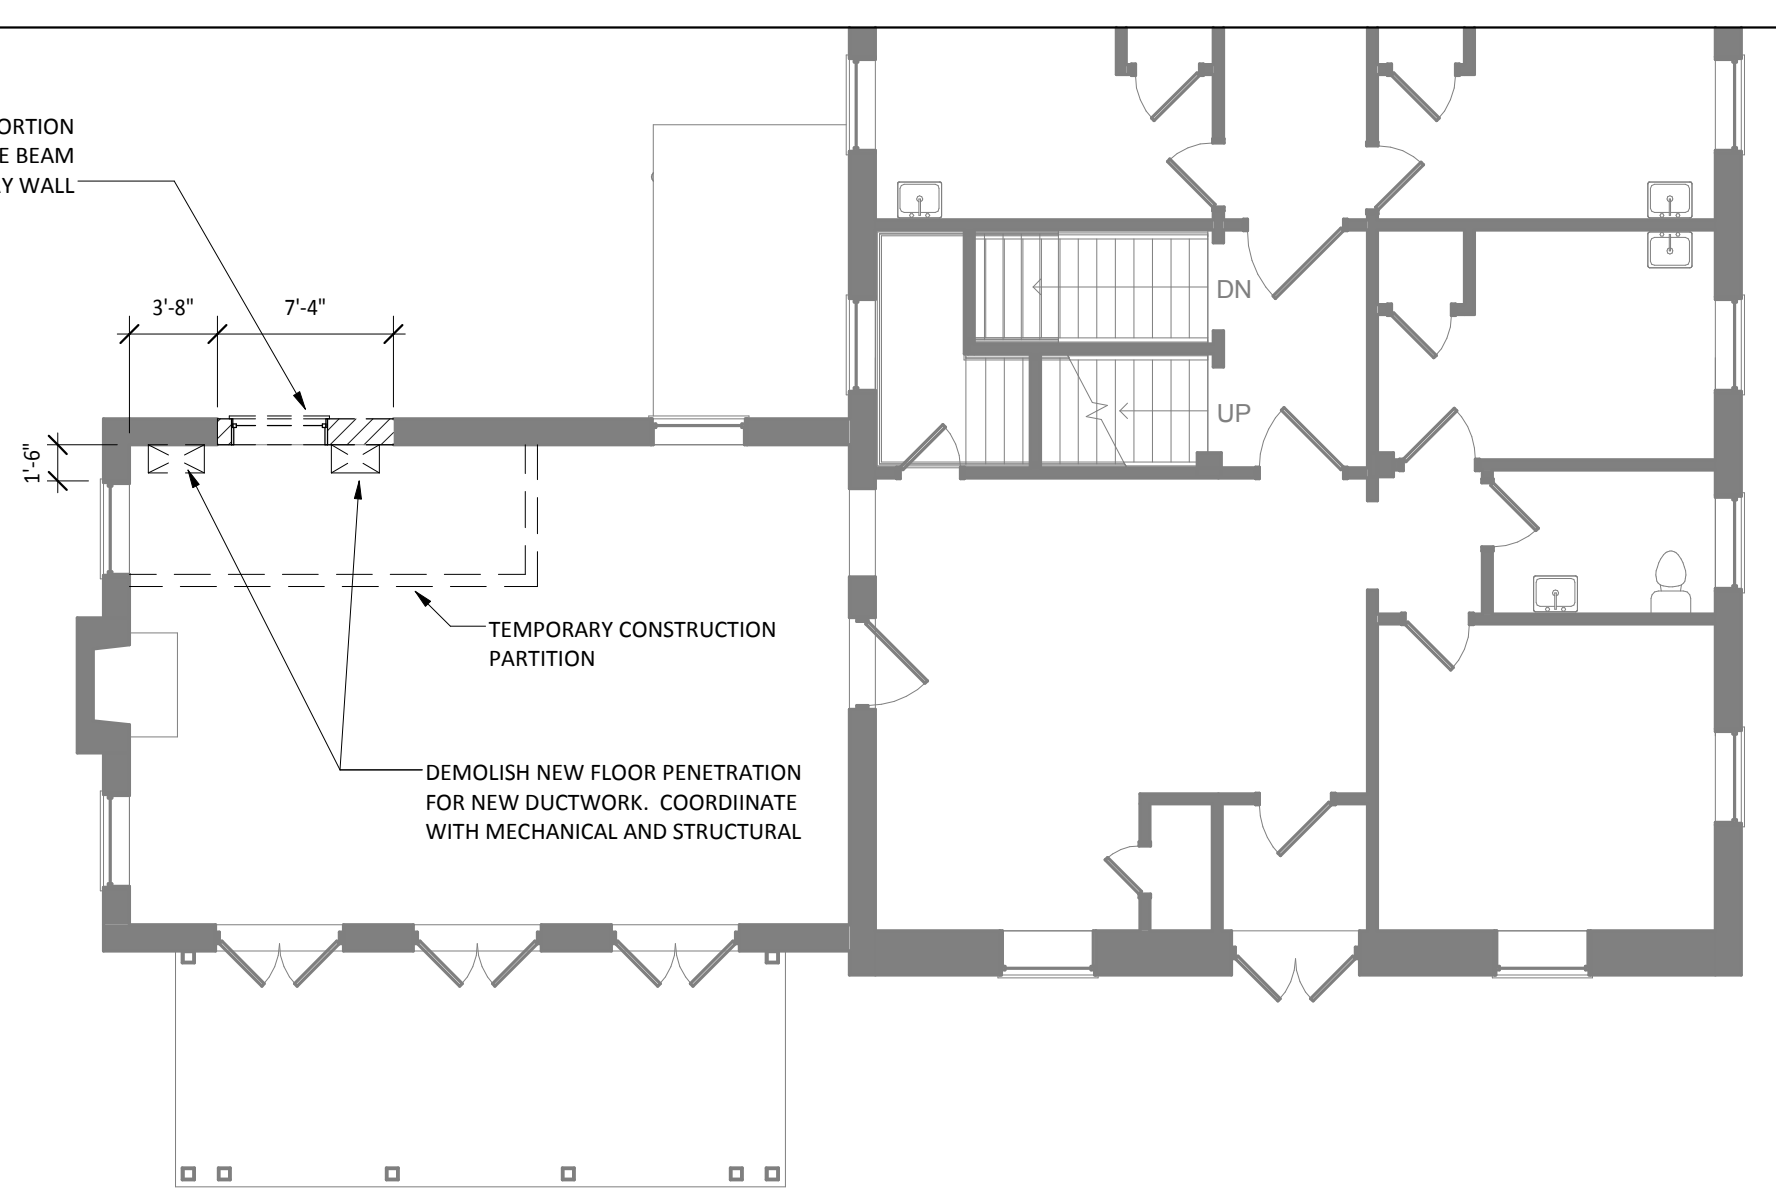

1 BUILDING 9/LINK TRANSITION
1/4" = 1'-0"

FLOOR PLAN GENERAL NOTES

- FOR TYPICAL BARRIER FREE TOILET ROOM TYPES AND ACCESSORIES REQ'TS AND LOCATIONS- SEE DWG.
- FOR TYPICAL HOUSEKEEPING CLOSETS ACCESSORIES REQ'TS AND MOUNTING LOCATIONS- SEE DWG.
- FOR TYPICAL METAL LOCKER ELEVATIONS AND TYPES "1" - SEE DWG. AX-XXX
- SEE CORE/SLAB DRAWINGS FOR ALL EXTERIOR BUILDING REQ'TS, INCLUDING LOCATIONS FOR SHAFTS, STAIR AND ELEVATOR FLOOR OPENINGS.
- ALL PARTITION TYPES () ARE "X" TYPICALLY UNLESS OTHERWISE NOTED.
- COORDINATE PARTITION FIRE RATED REQUIREMENTS AS INDICATED ON REFLECTED CEILING PLANS- DRAWING SERIES "AX-XXX THRU AX-XXX"
- ALL WALLS TO RECEIVE 2" ACOUSTICAL INSULATION U.O.N. - TYPICAL
- PROVIDE 6" MET STUDS PARTITIONS AT MECH. LOW EXIST LOCATIONS COORD. W/ MECH. DWG'S (TYP.)
- INDICATES PARTITIONS WITH LEAD LINING 7'-0" A.F.F. - CONTINUOUS WHERE POICHE IS REMOVED FOR CLARITY AT WINDOW AND DOOR LOCATIONS.
- TYPICALLY INSTALL SOAP DISPENSERS AND PAPER TOWEL DISPENSER AT ALL SINKS UNLESS NOTED OTHERWISE.
- PROVIDE WALL REINFORCEMENT PER DETAIL BX/A-XXX AT WALL-MOUNTED SHELVES AND STORAGE UNITS, MARKERBOARDS, BULLETIN BOARDS, TACK BOARDS, TELEVISIONS AND OTHER CONTRACTOR OR OWNER FURNISHED WALL-MOUNTED ITEMS (REFER TO ACCESSORIES AND EQUIPMENT SCHEDULE) SEE DWG AX-XXX.
- FOR ALL CARPET TYPE CHANGES BETWEEN ROOMS- TRANSITION SHALL OCCUR AT CENTERLINE OF DOOR FRAME TYPICALLY - U.O.N. SEE DWG AX-XXX.
- COORDINATE DIMENSIONS W/ ASTERISK (IE *X'-X") W/ EQUIPMENT VENDER.
- PROVIDE BULLNOSED CORNERS ON ALL CMU WALLS - TYPICAL
- ALL DIMENSIONS ARE TO FACE OF GYPSUM BOARD OR MASONRY UNLESS OTHERWISE NOTED.

NOTE: COORDINATE ALL FLOOR OPENING DIMENSIONS AND CLEARANCES FOR DUCTWORK W/ MECHANICAL CONTRACTOR - TYPICAL

KEYNOTES	
NO.	NOTE
1	MASONRY JOINT- SPACE EQ IN PORTIONS OF WALL W/O WINDOW TYP.
2	CONTROL JOINT- CONTINUOUS FROM WINDOW HEAD OF T.O. CAST STONE PANEL TO T.O. BRICK VENEER
3	EXIST CONCRETE DUCT BANK-VERIFY EXACT SIZE AND LOCATION. SEE STRUCTURAL FOR FOUNDATION WALL BRIDGING
4	PREFINISHED METAL FASCIA & SOFFIT
5	ALIGN TOP OF CAST STONE BAND WITH TOP OF BAND ON ADJACENT EXIST. BUILDING
6	REMOVE AND SALVAGE EXIST. ALUM DOOR AT INTERMEDIATE PSYCH BUILDING. REUSE FOR DOOR 131A AT NEW LINK.
7	DEMOLISH EXIST. STOOP AT INTERMEDIATE PSYCH BUILDING FOR NEW CONSTRUCTION.

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DATE: 12-20-2013
DANIEL J. MILLER, AIA
REG. NO.

DRAWING TITLE
LINK PLANS & ELEVATIONS

PROJECT TITLE
RECONFIGURE/EXPAND
BUILDINGS 28 & 9 FOR
RESIDENTIAL REHABILITATION
TREATMENT PROGRAM

BUILDING No. 9
CHECKED BY DJM
DRAWN ADB


LOCATION
ST. CLOUD VA MEDICAL CENTER
ST. CLOUD, MN 56303

DATE 12.20.13
PROJECT NO. 656-12-339
DRAWING NO. AS120



one eighth inch = one foot
one quarter inch = one foot
three eighths inch = one foot
one half inch = one foot
three quarters inch = one foot
one inch = one foot
one and one half inches = one foot
two inches = one foot
three inches = one foot


② SECOND FLOOR DEDUCT ALTERNATE #6
1/8" = 1'-0"

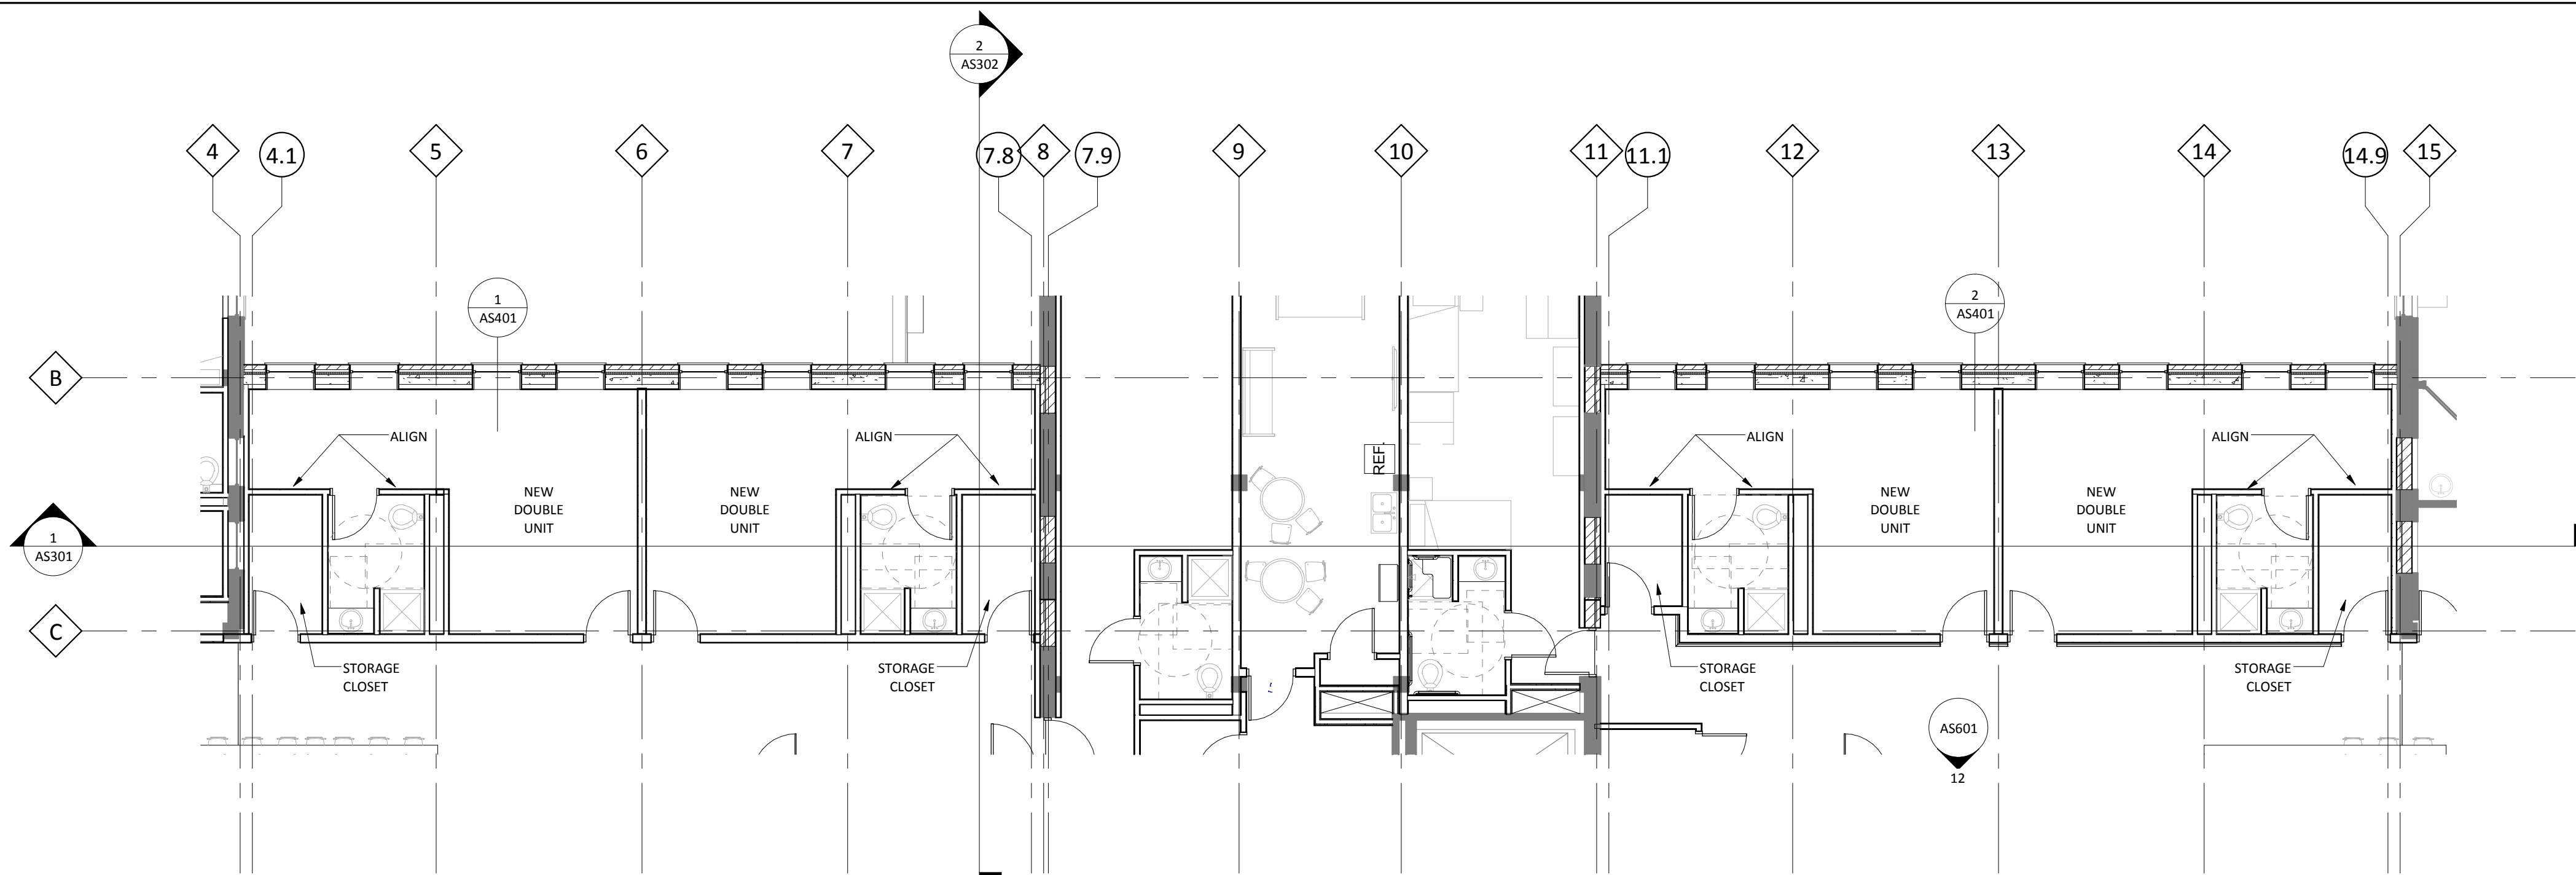

PROJECT ALTERNATES

- DEDUCT ALTERNATE #1 DEDUCT REDUNDANT HOT WATER GENERATOR. REFER TO MECHANICAL DRAWINGS AND SPECIFICATIONS FOR MORE INFORMATION.
- DEDUCT ALTERNATE #2 DEDUCT WEST SIDE BASEMENT INFILL FINISHES. THIS DEDUCT OMITTS ALL WALL TYPES 2B, CEILINGS, AND FLOOR FINISHES IN THIS SPACE. ELECTRICAL WORK ON WALLS TO BE SURFACE MOUNTED.
- DEDUCT ALTERNATE #3 DEDUCT EAST SIDE BASEMENT INFILL FINISHES. THIS DEDUCT OMITTS ALL WALL TYPES 2B, CEILINGS, AND FLOOR FINISHES IN THIS SPACE. ELECTRICAL WORK ON WALLS TO BE SURFACE MOUNTED.
- DEDUCT ALTERNATE #4 NO NEW WORK IN EXISTING PATIENT UNIT BATHROOMS. REFER TO PLAN DRAWING ON THIS SHEET FOR LOCATIONS.
- DEDUCT ALTERNATE #5 DEDUCT WEST SIDE FIRST FLOOR INFILL FINISHES. THIS DEDUCT OMITTS ALL WALL TYPES 2B, CEILINGS, AND FLOOR FINISHES IN THIS SPACE. ELECTRICAL WORK ON WALLS TO BE SURFACE MOUNTED.
- DEDUCT ALTERNATE #6 EIGHT SINGLE PATIENT UNITS ON SECOND FLOOR TO BE CONSTRUCTED AS DOUBLE UNITS. REFER TO PLAN DRAWING ON THIS SHEET.
- DEDUCT ALTERNATE #7 DEDUCT EAST SIDE FIRST FLOOR INFILL FINISHES. THIS DEDUCT OMITTS ALL WALL TYPES 2B, CEILINGS, AND FLOOR FINISHES IN THIS SPACE. ELECTRICAL WORK ON WALLS TO BE SURFACE MOUNTED.
- DEDUCT ALTERNATE #8 DEDUCT CONNECTING CORRIDOR CONSTRUCTION AT BUILDING 9.
- DEDUCT ALTERNATE #9 DEDUCT LED LIGHTS AND DIMMERS TO FLOURESCENT. SEE ELECTRICAL DRAWINGS AND SPECIFICATIONS FOR MORE INFORMATION.
- DEDUCT ALTERNATE #10 DEDUCT SOLID SURFACE WINDOW SILLS IN LIEU OF GWB RETURNS AT ALL WINDOW SILL LOCATIONS.
- DEDUCT ALTERNATE #11 DEDUCT SECOND FLOOR CONVECTORS. SEE MECHANICAL DRAWINGS AND SPECIFICATIONS FOR MORE INFORMATION.

① SECOND FLOOR DEDUCT ALTERNATE #4
1/8" = 1'-0"

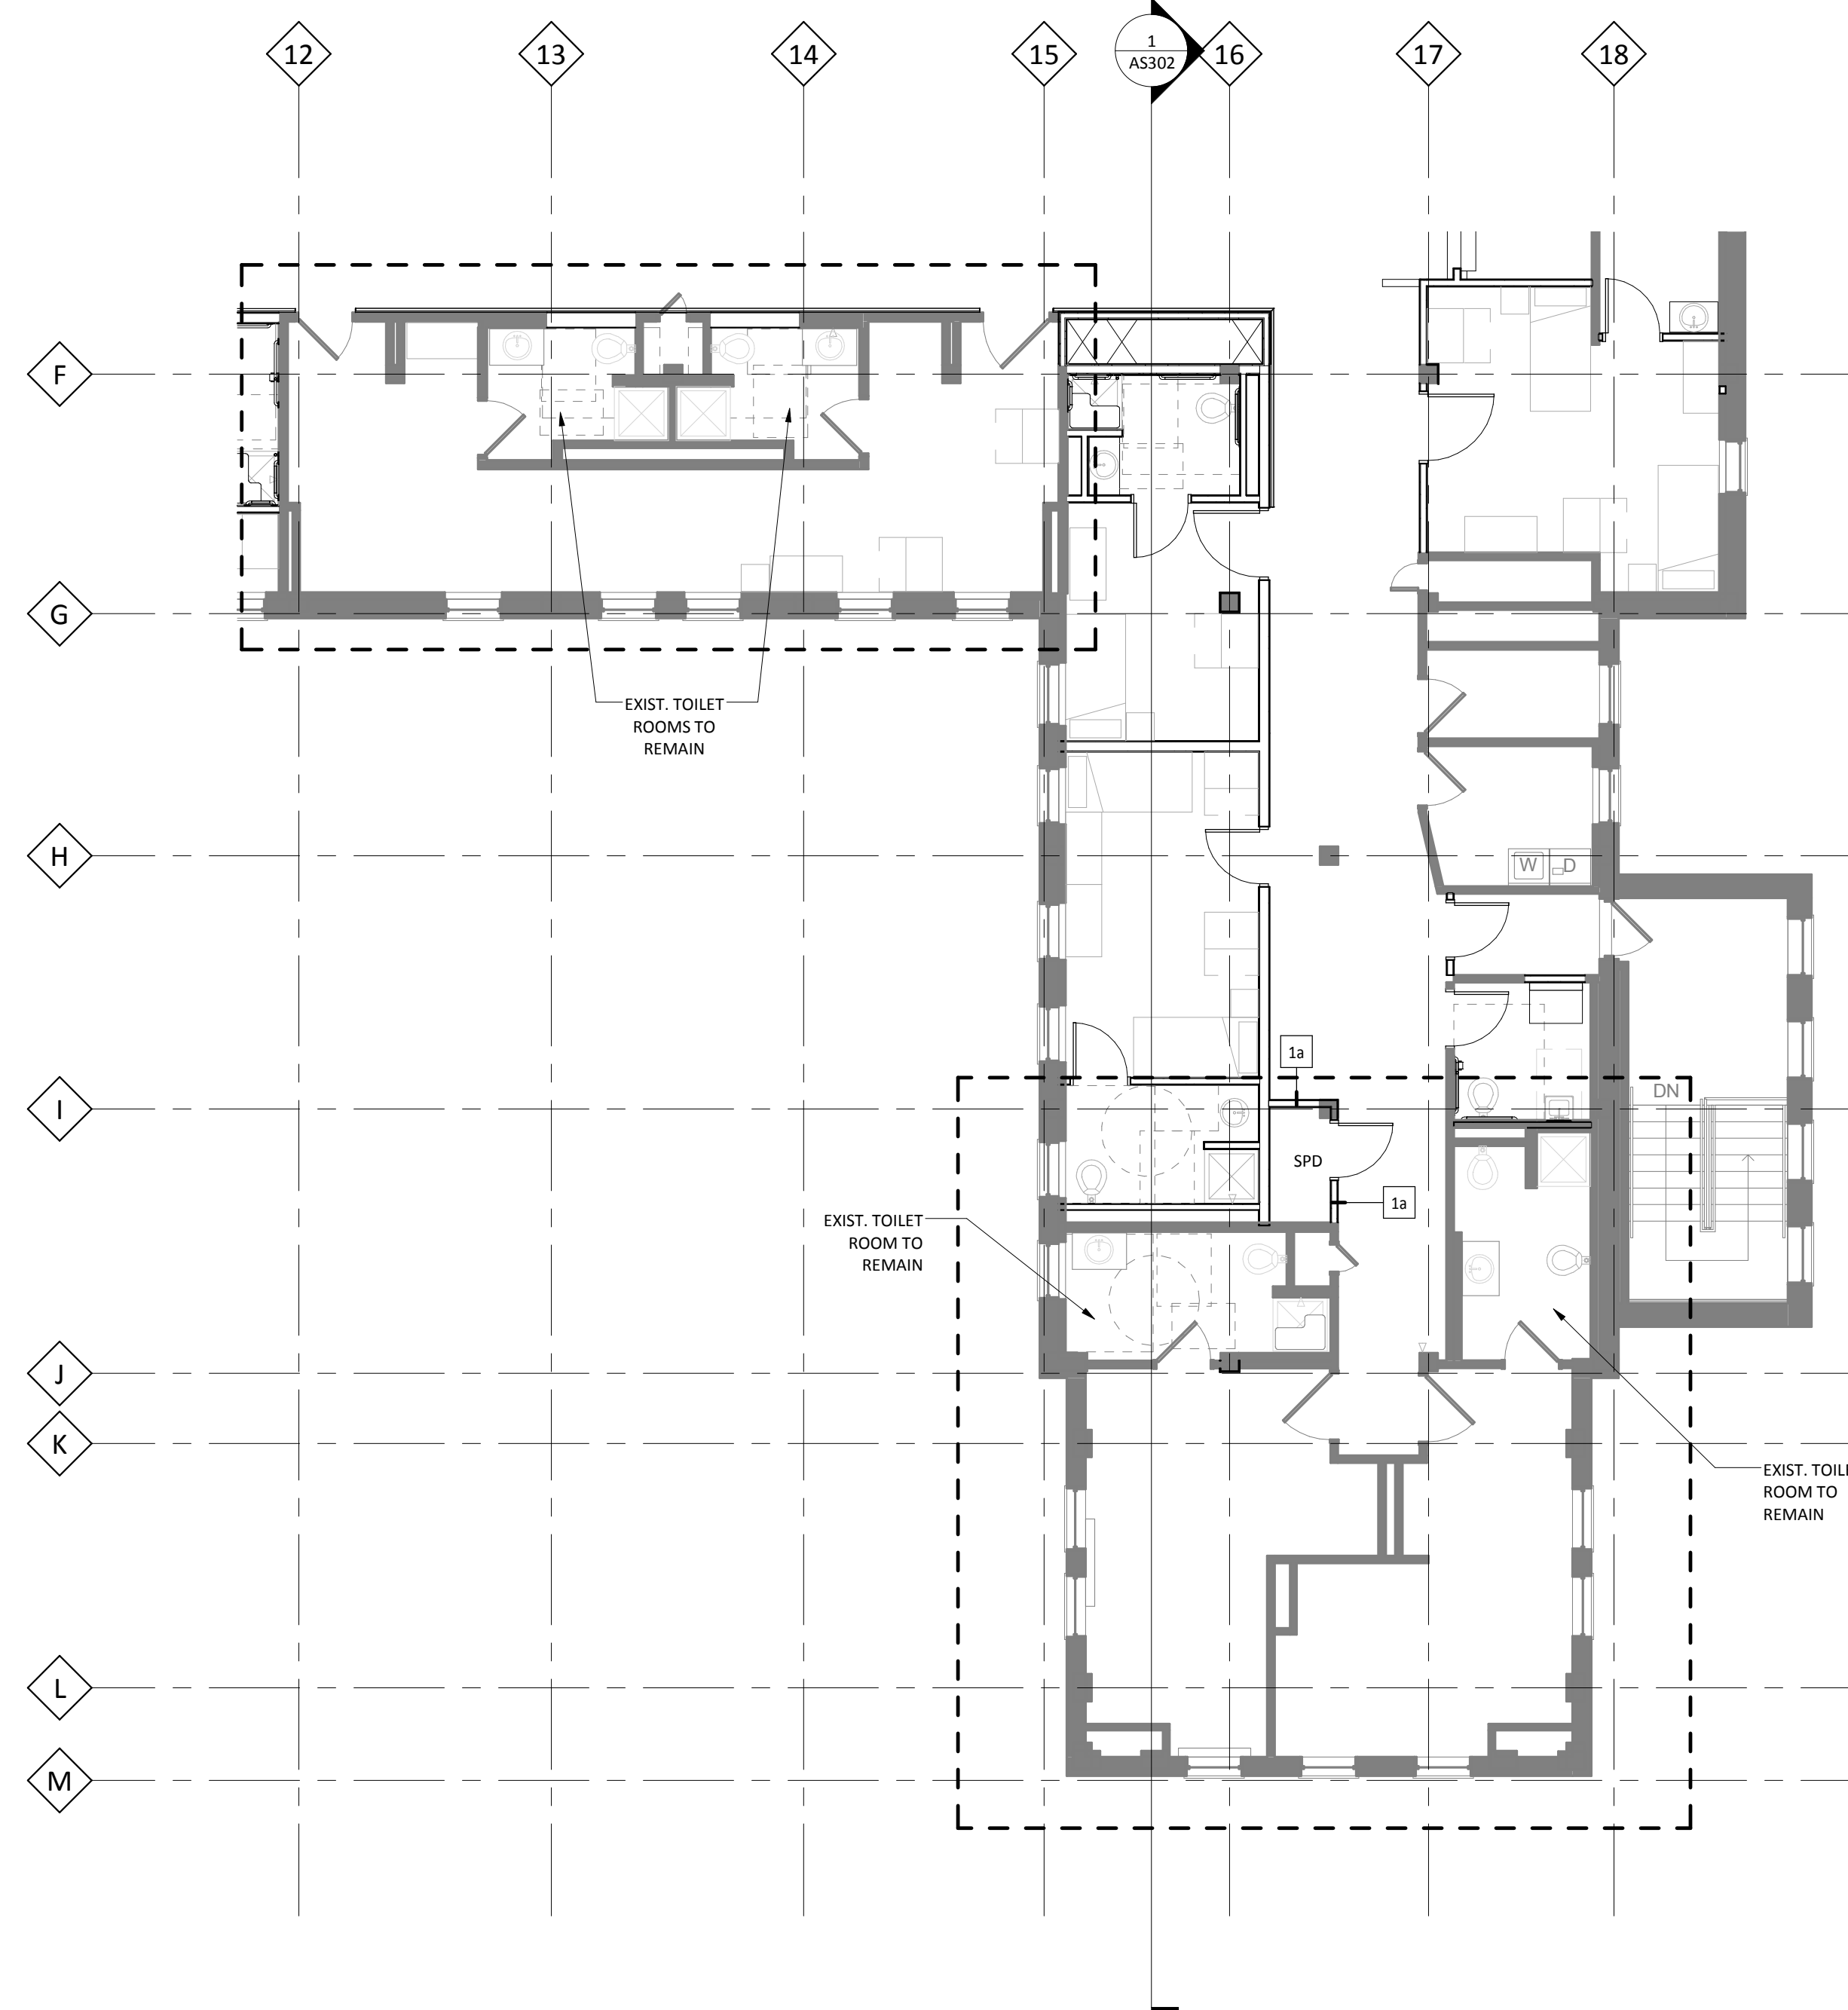

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NO	REVISION	DATE

VA FORM 08-6231



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UNDER THE LAWS OF THE STATE OF MINNESOTA.

DANIEL J. MILLER, AIA
DATE: 12-20-2013
MIN. REG. NO.
REG. NO.

DRAWING TITLE
PROJECT ALTERNATES


PROJECT TITLE
RECONFIGURE/EXPAND
BUILDINGS 28 & 9 FOR
RESIDENTIAL REHABILITATION
TREATMENT PROGRAM

BUILDING No. 28
CHECKED BY DJM
DRAWN ADB
DATE FILE
LOCATION
ST. CLOUD VA MEDICAL CENTER
ST. CLOUD, MN 56303


DATE 12.20.13
PROJECT SCALE AS NOTED
PROJECT NO. 656-12-339
DRAWING NO. AS131




one eighth inch = one foot
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one half inch = one foot
three quarters inch = one foot
one inch = one foot
one and one half inches = one foot
two inches = one foot
three inches = one foot

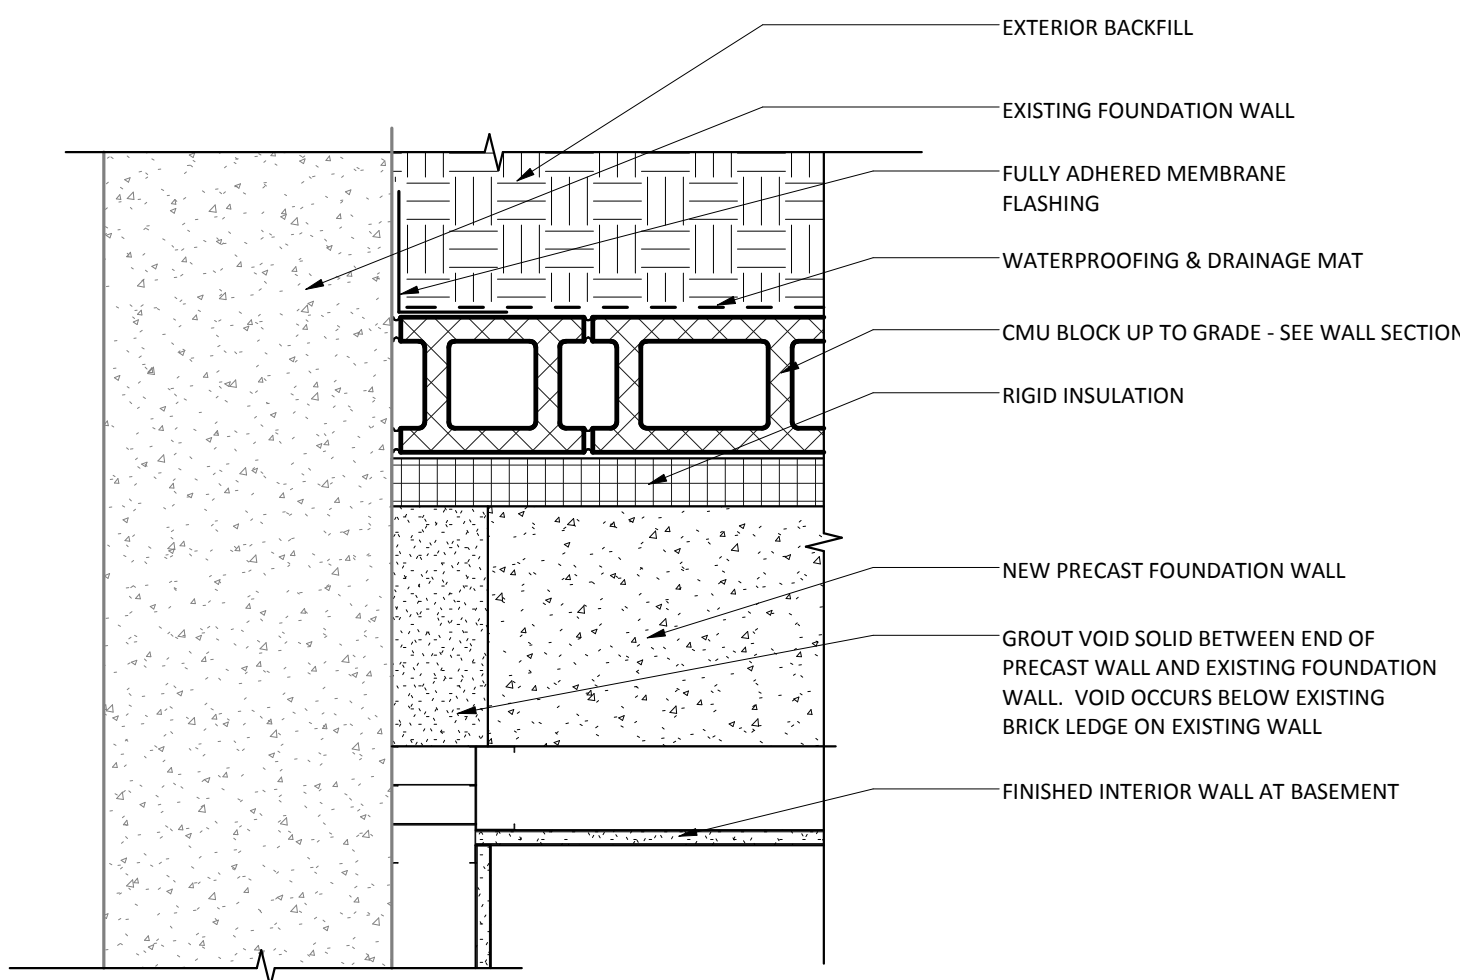


10 NEW FOUNDATION WALL BELOW BRICK LEDGE
1 1/2" = 1'-0"

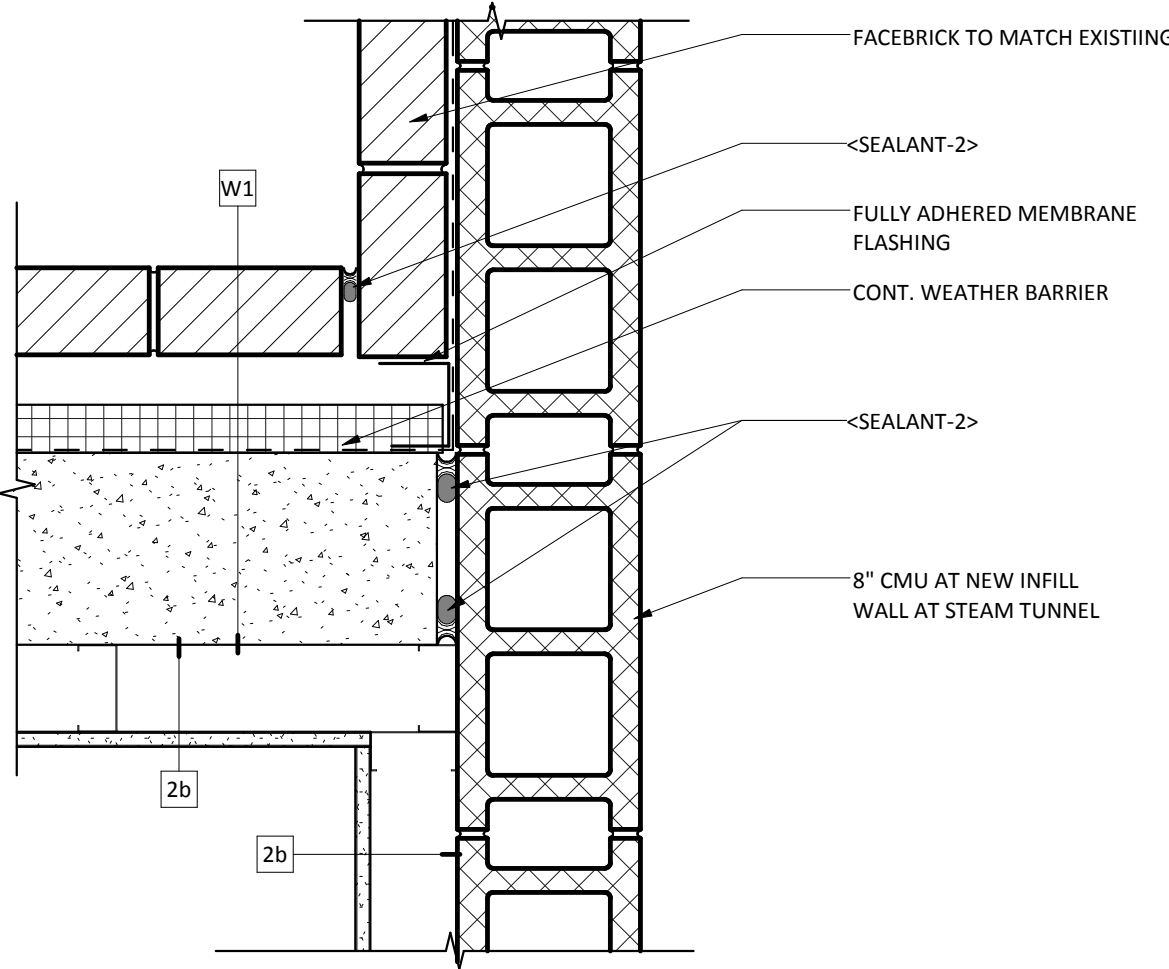


9 NEW INFILL WALL AT STEAM TUNNEL
1 1/2" = 1'-0"

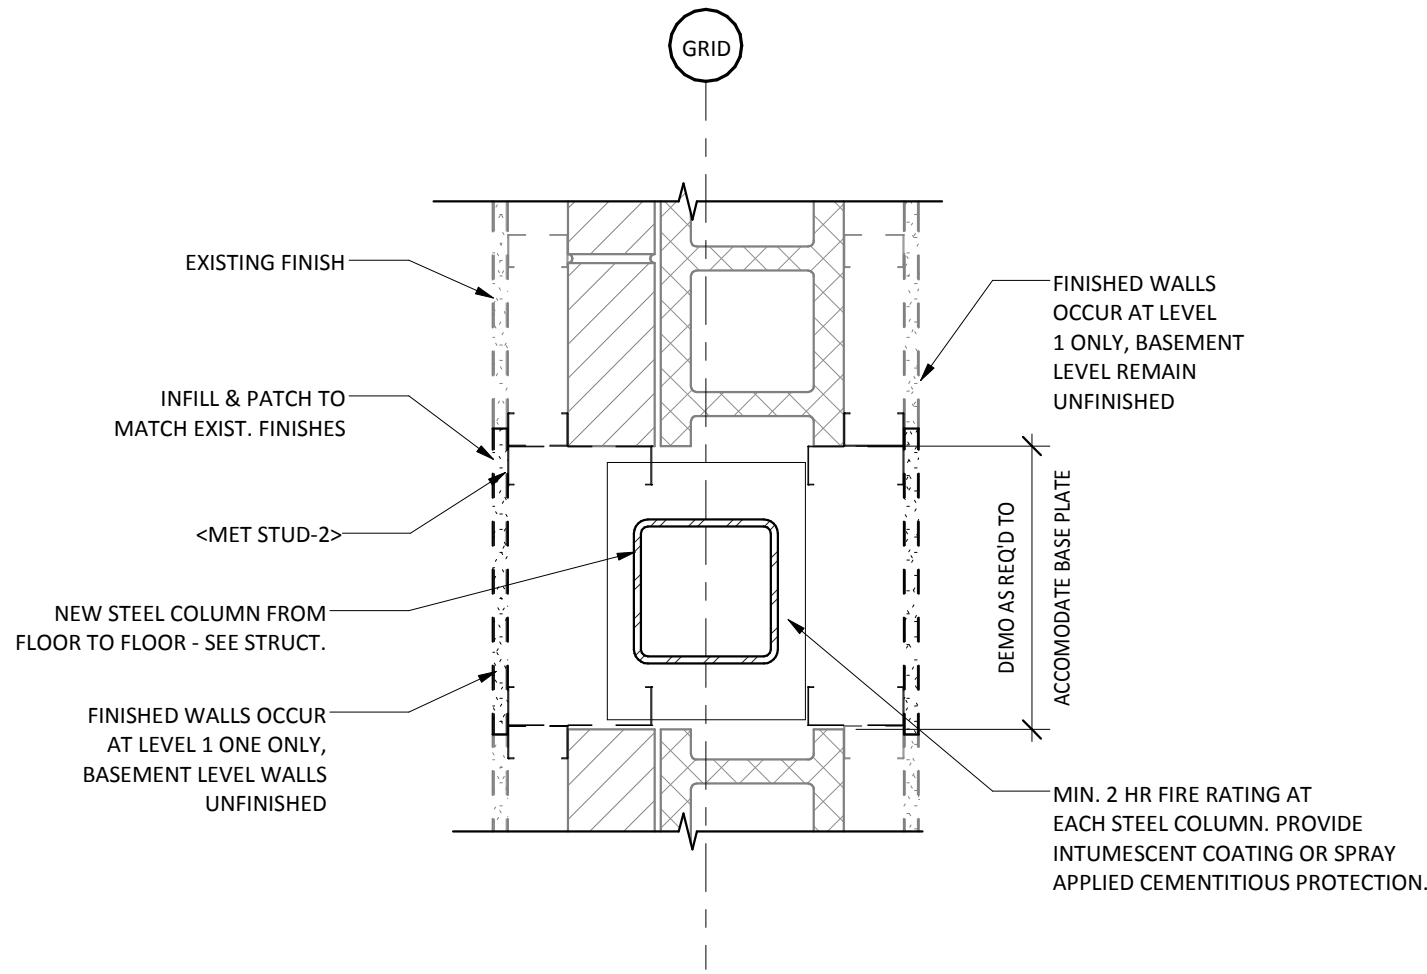


8 NEW STEEL COLUMN IN EXIST. WALL
1 1/2" = 1'-0"

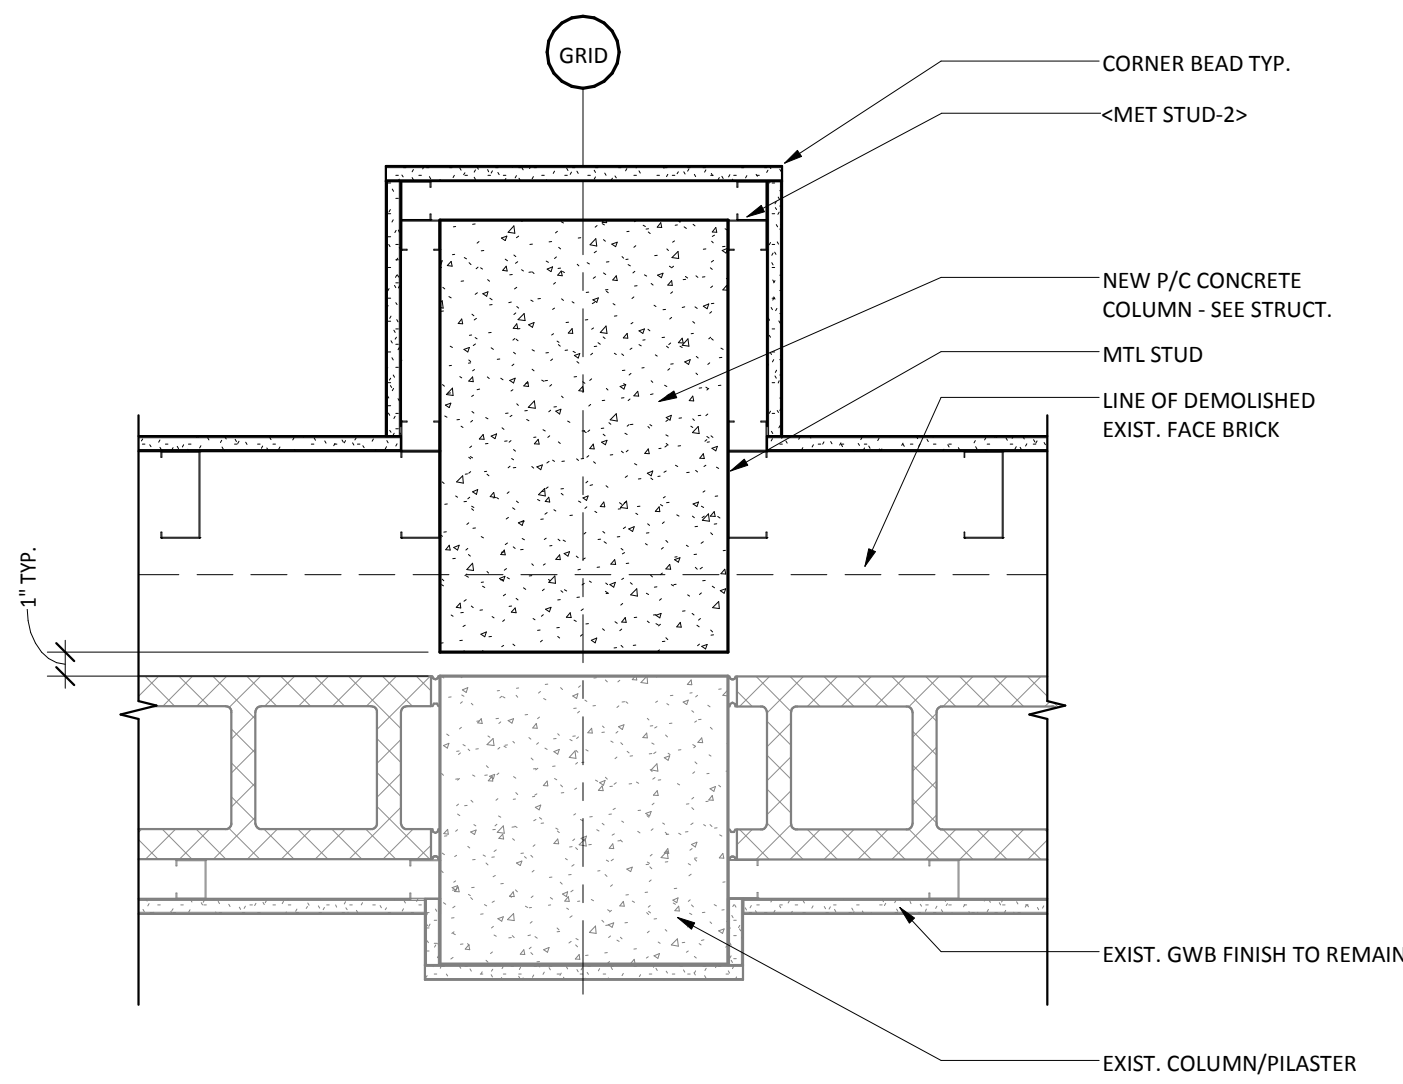


7 NEW COLUMN AT INFILL TYP.
1 1/2" = 1'-0"

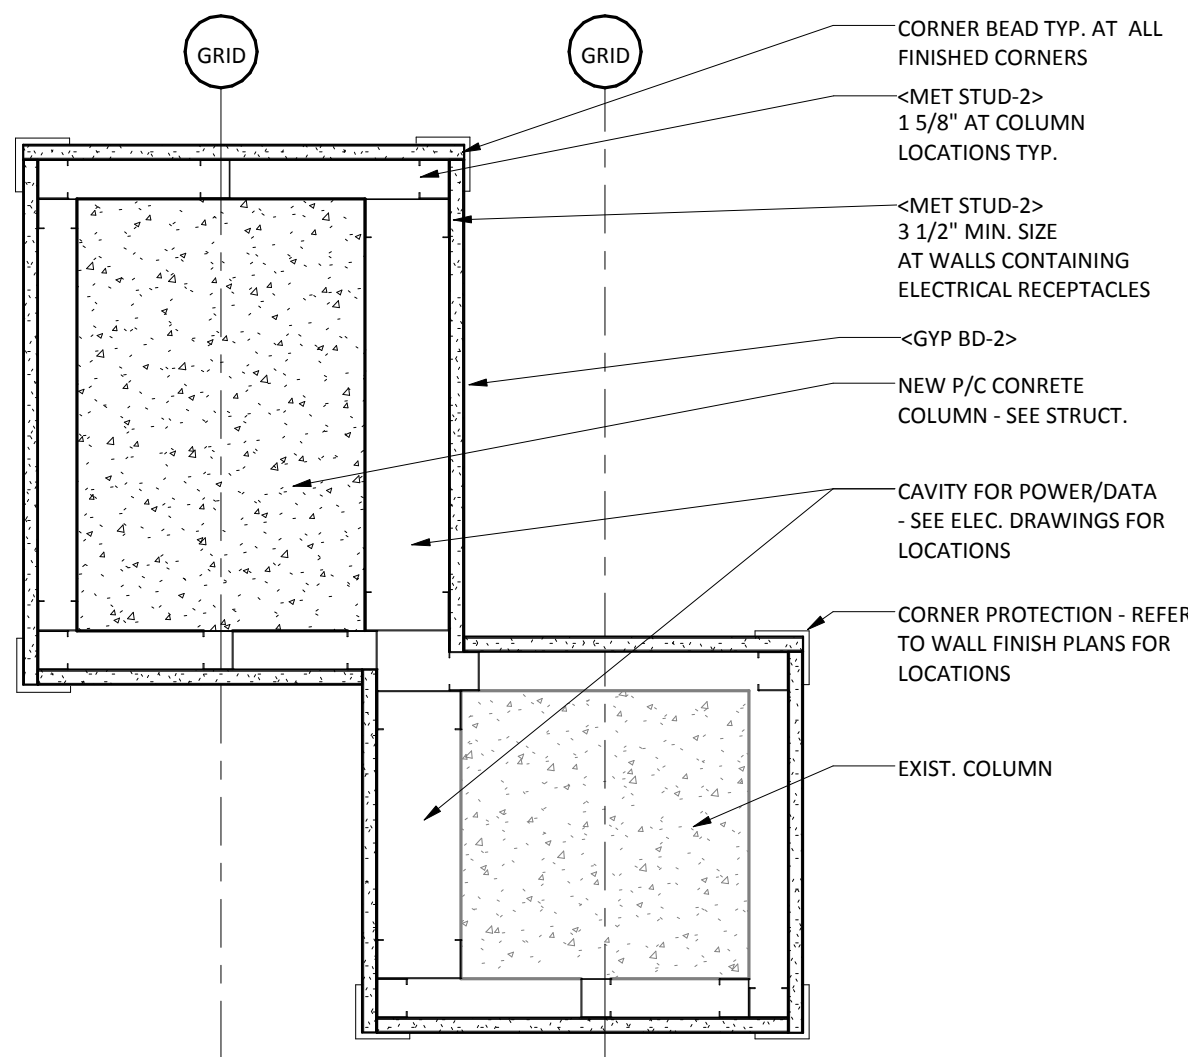


6 NEW COLUMN/EXISTING AT LOUNGE
1 1/2" = 1'-0"

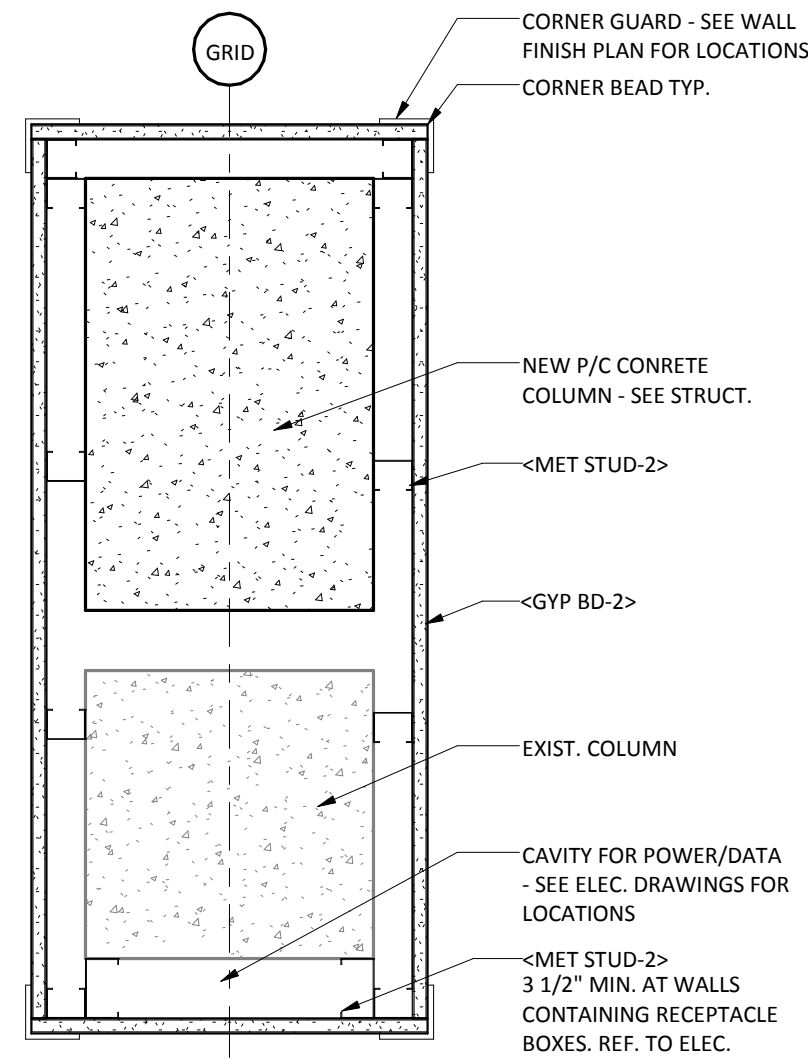


5 NEW COLUMN/EXISTING TYP.
1 1/2" = 1'-0"

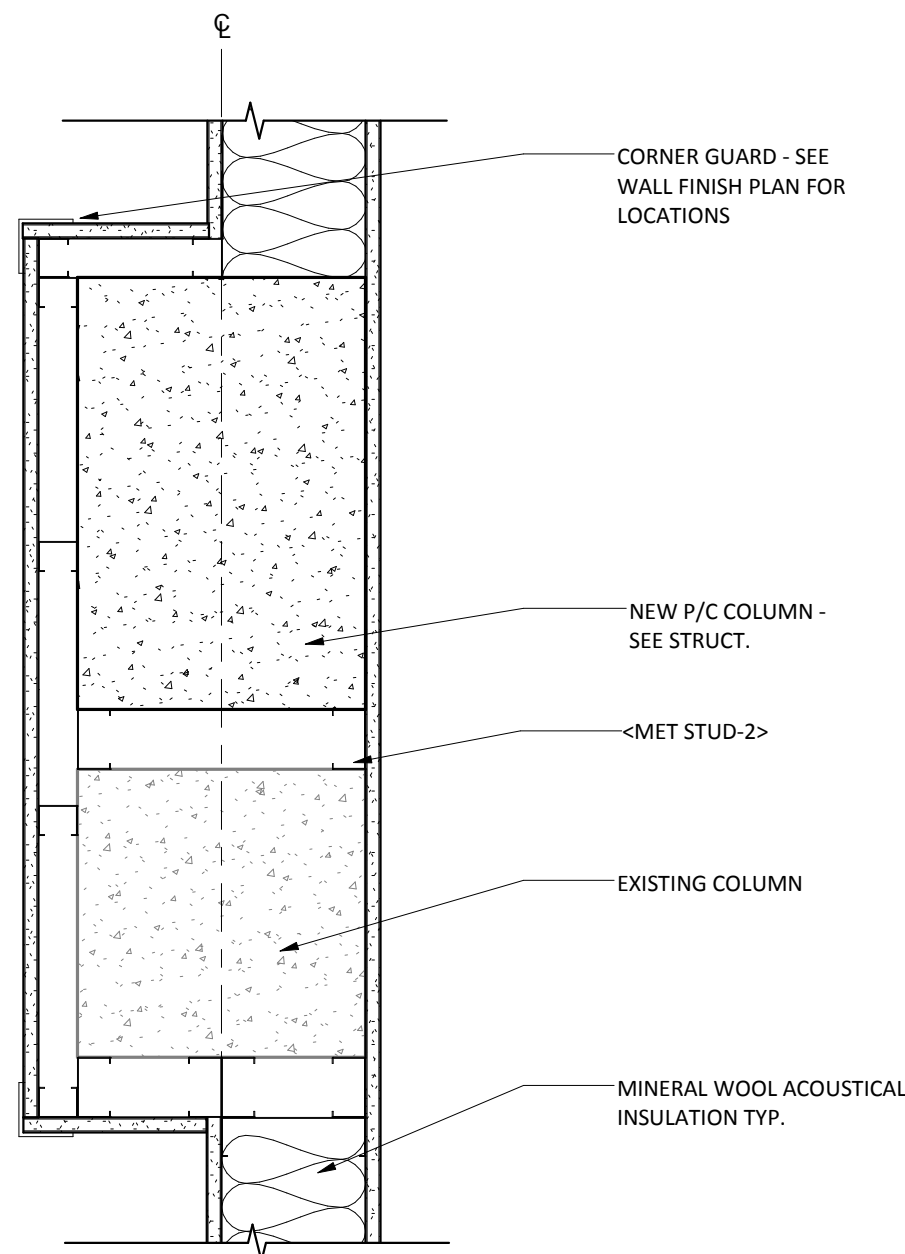


4 COLUMNS AT MULTI-PURPOSE ROOM
1 1/2" = 1'-0"

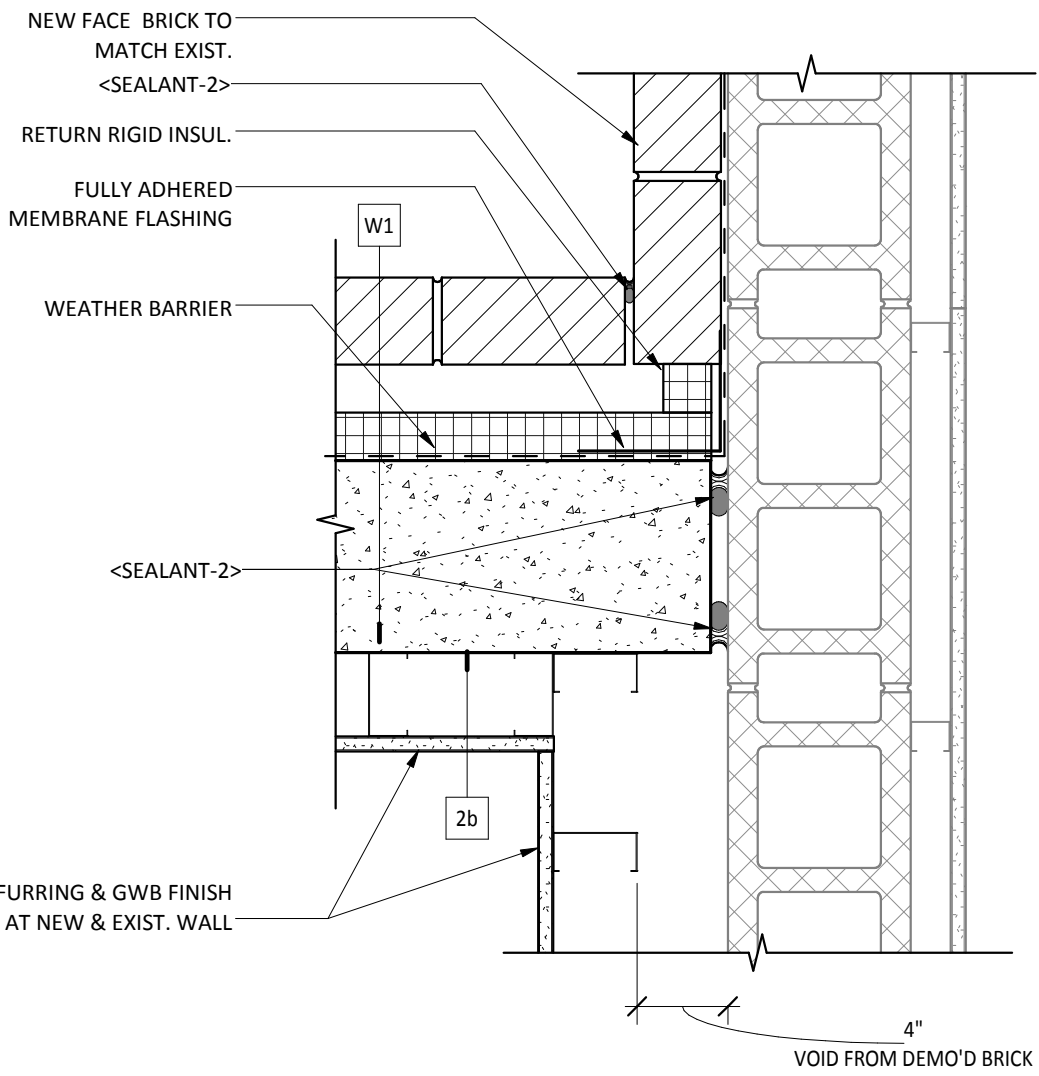

3 NEW EXTERIOR WALL AT EXIST. WALL JOINT
1 1/2" = 1'-0"

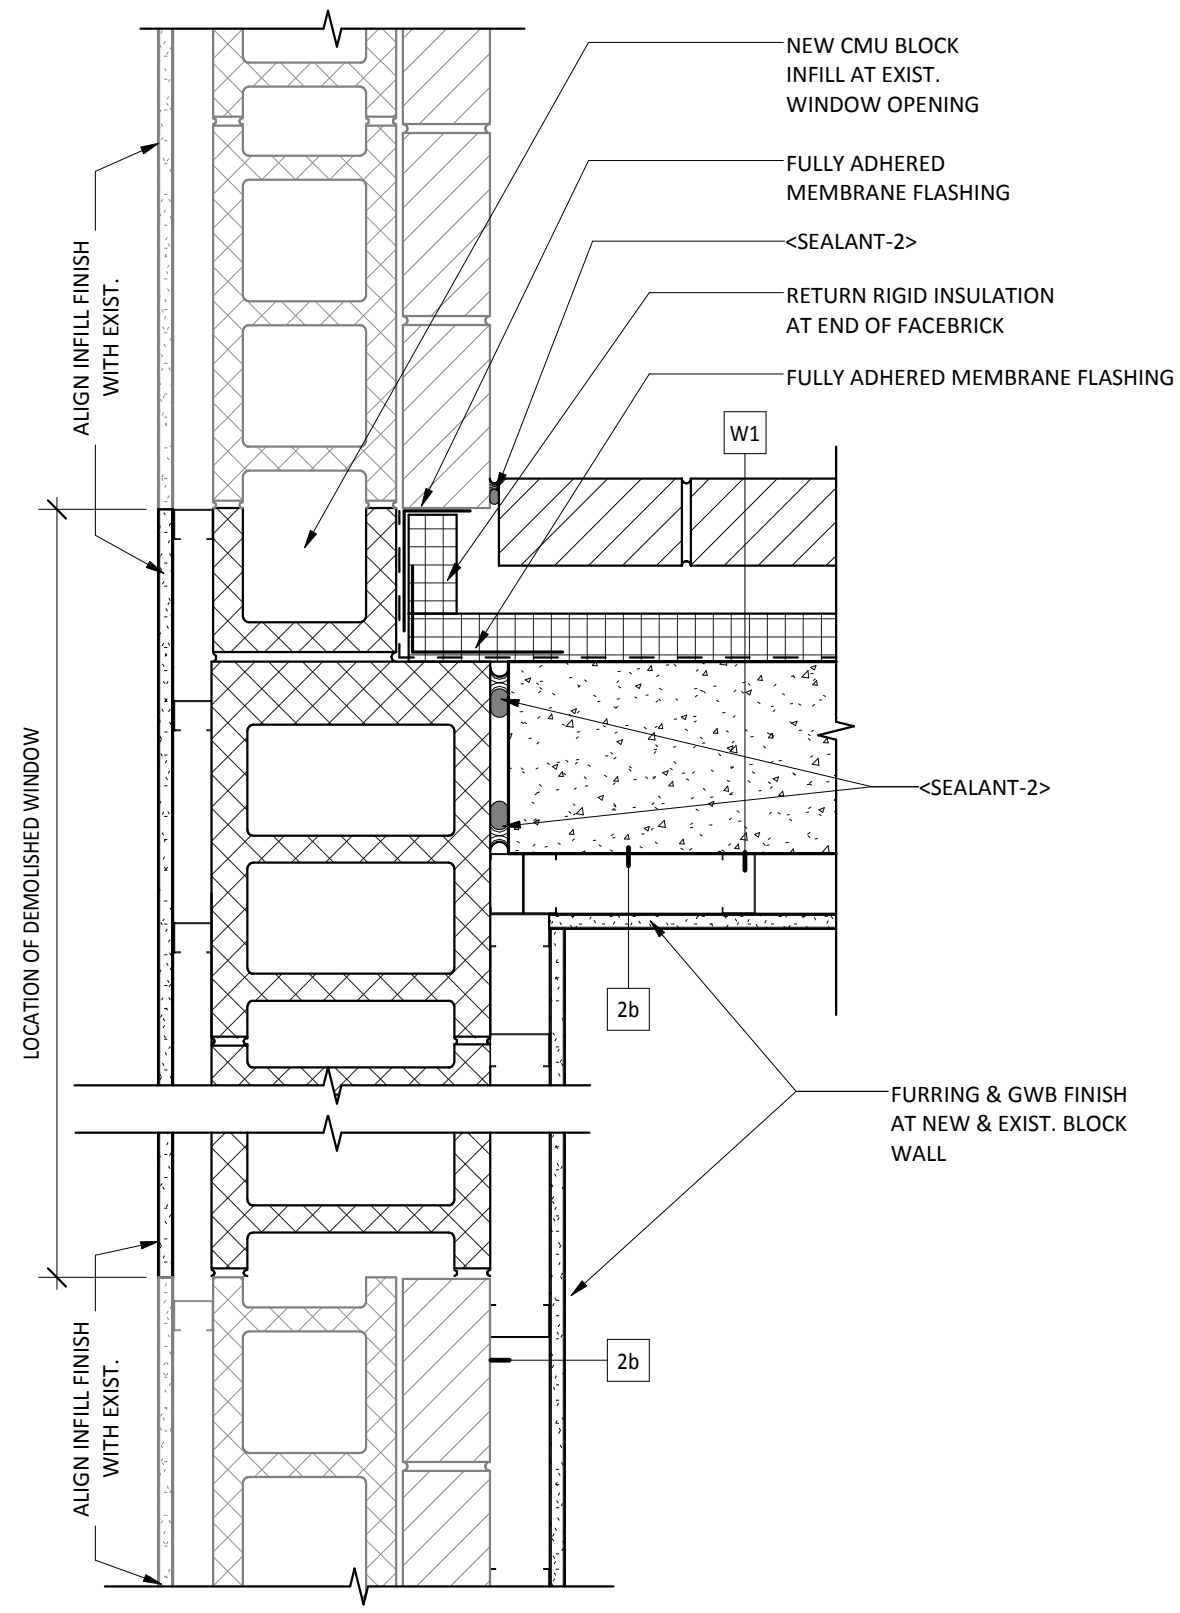


2 NEW EXTERIOR WALL AT DEMO'D WINDOW
1 1/2" = 1'-0"

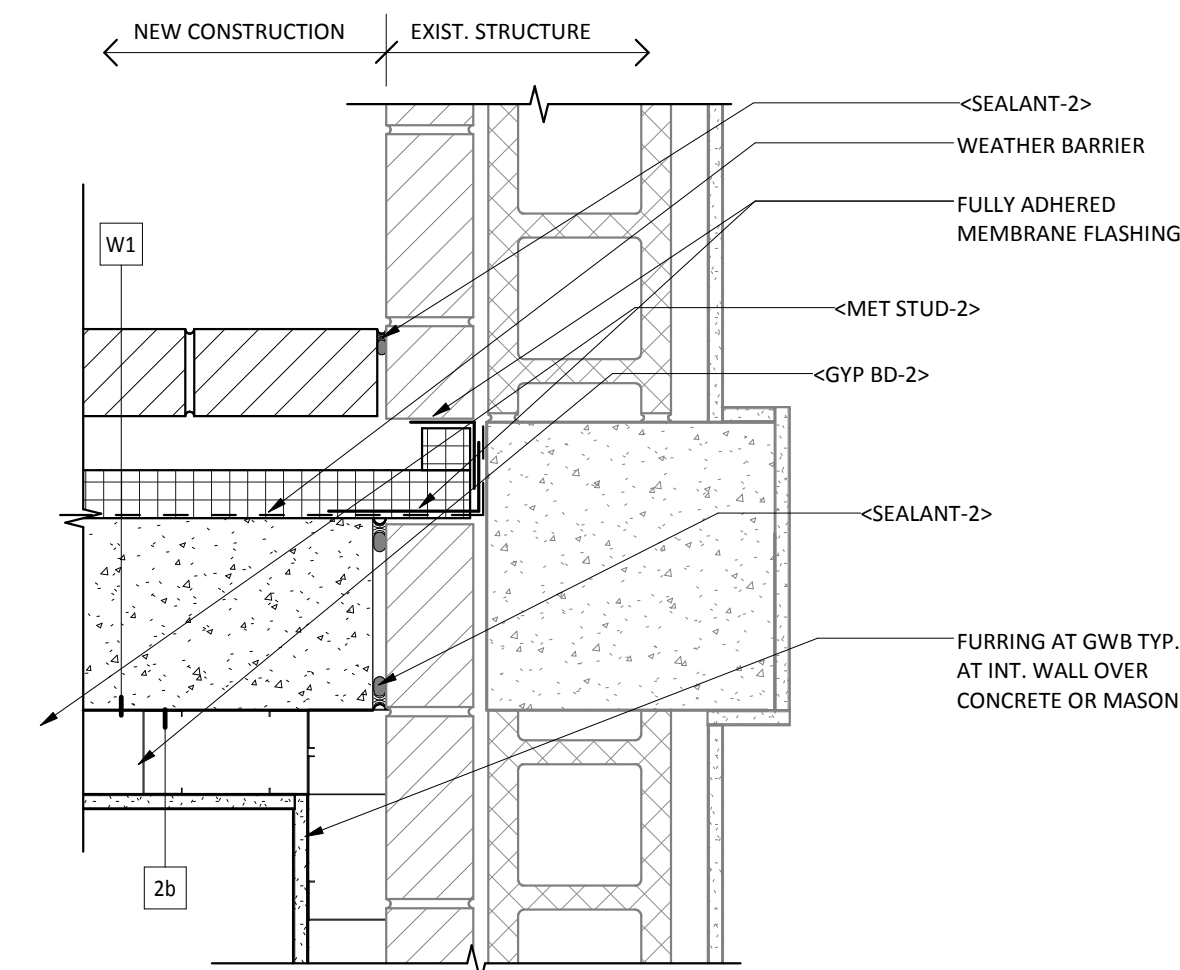


1 NEW/EXISTING EXT. WALL JOINT
1 1/2" = 1'-0"


three inches = one foot
one and one half inches = one foot
one inch = one foot
three quarters inch = one foot
three eighths inch = one foot
one half inch = one foot
one quarter inch = one foot
one eighth inch = one foot
one eighth inch = one foot

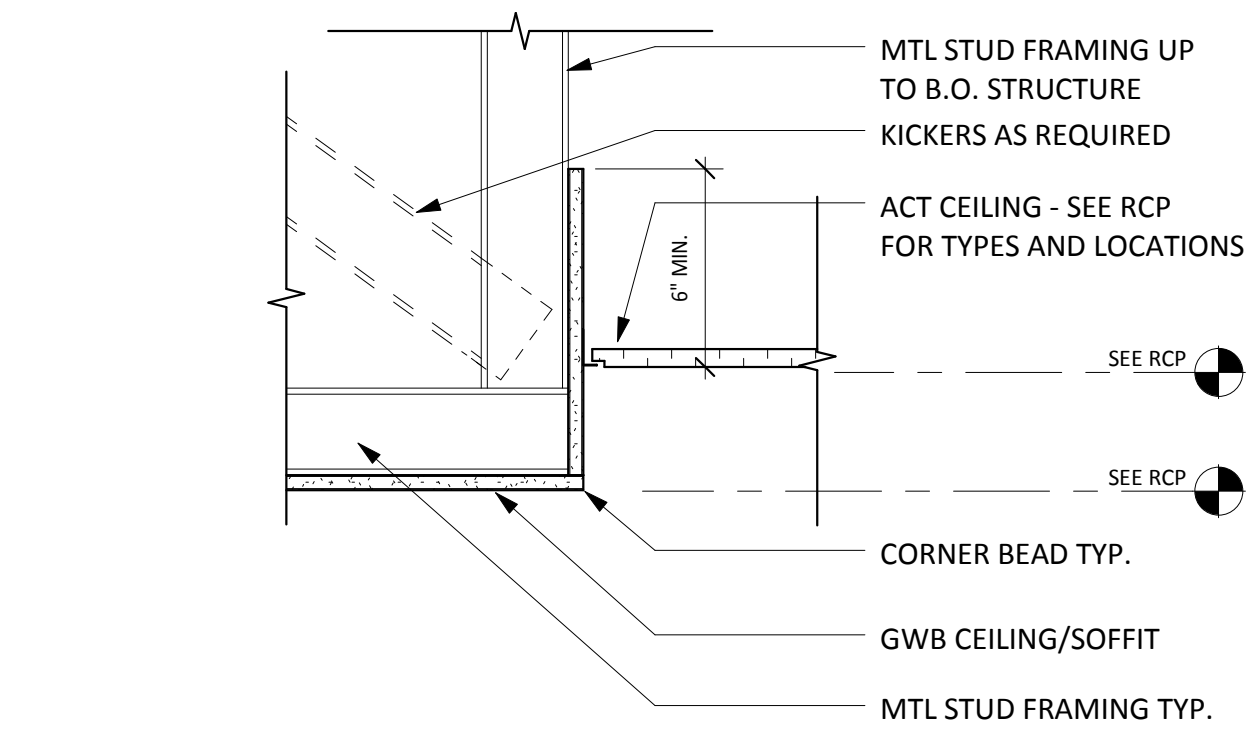


④ SOFFIT CORNER DETAIL
1 1/2" = 1'-0"

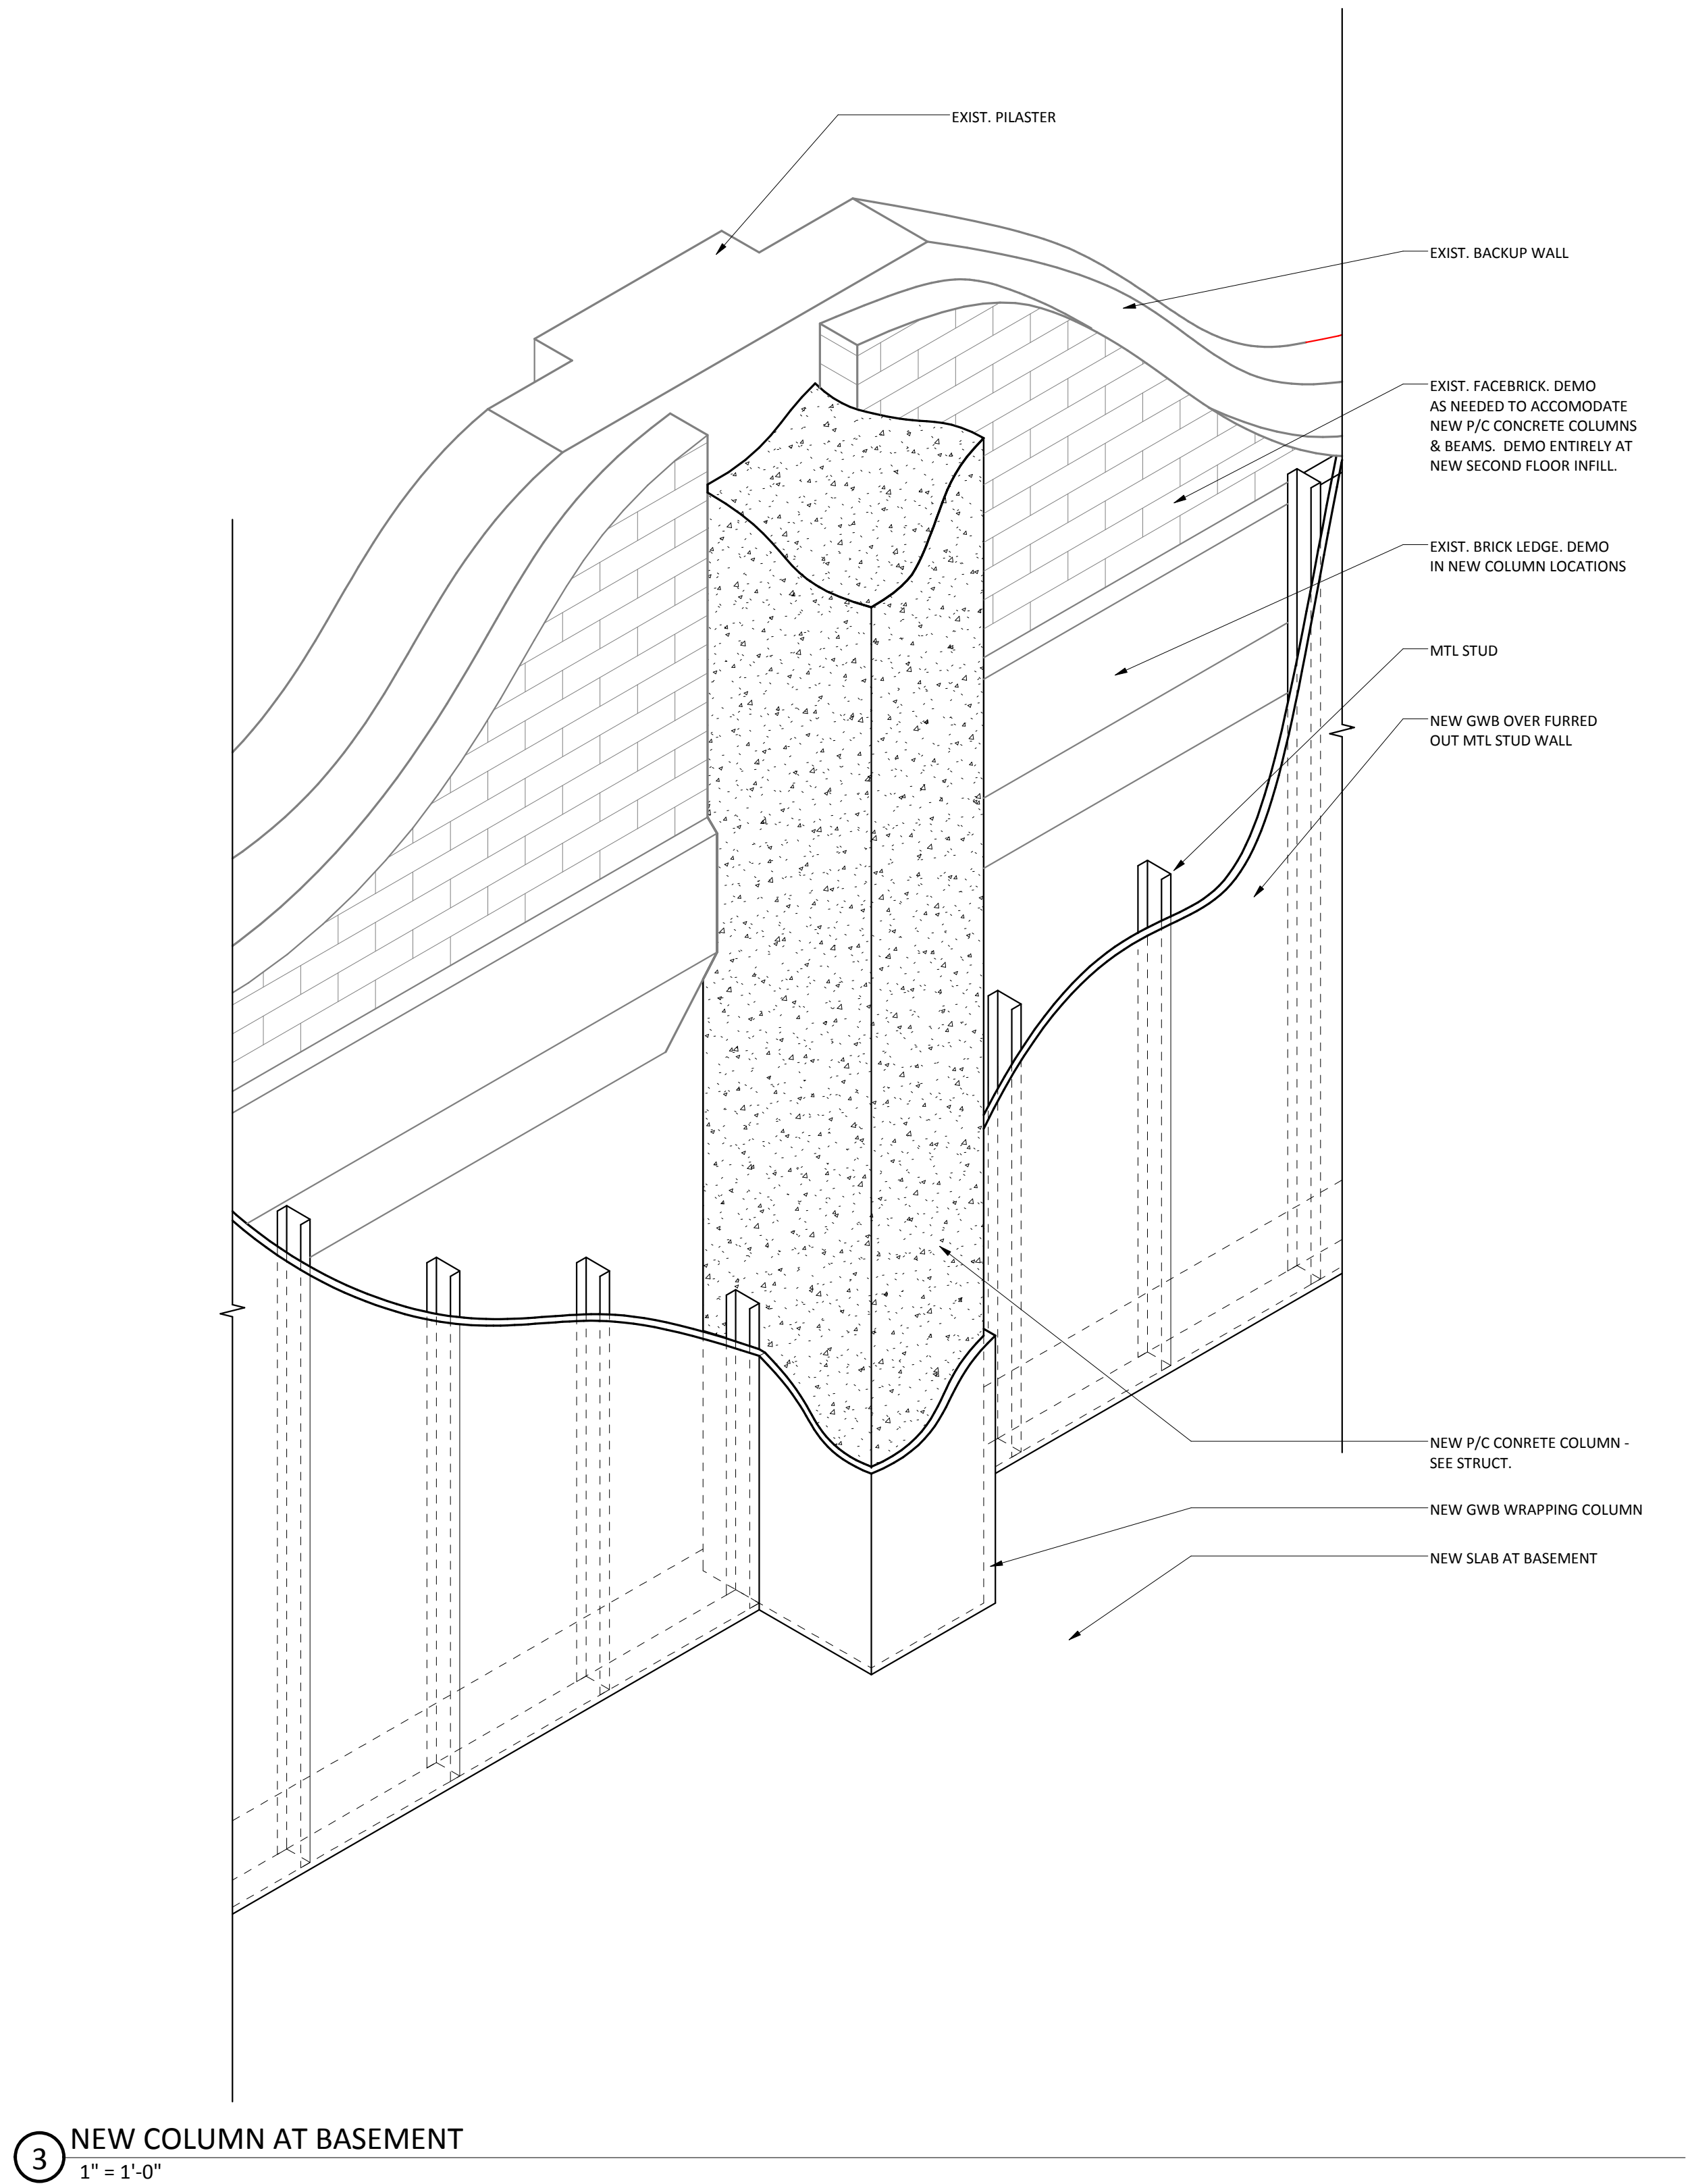

③ NEW COLUMN AT BASEMENT
1" = 1'-0"

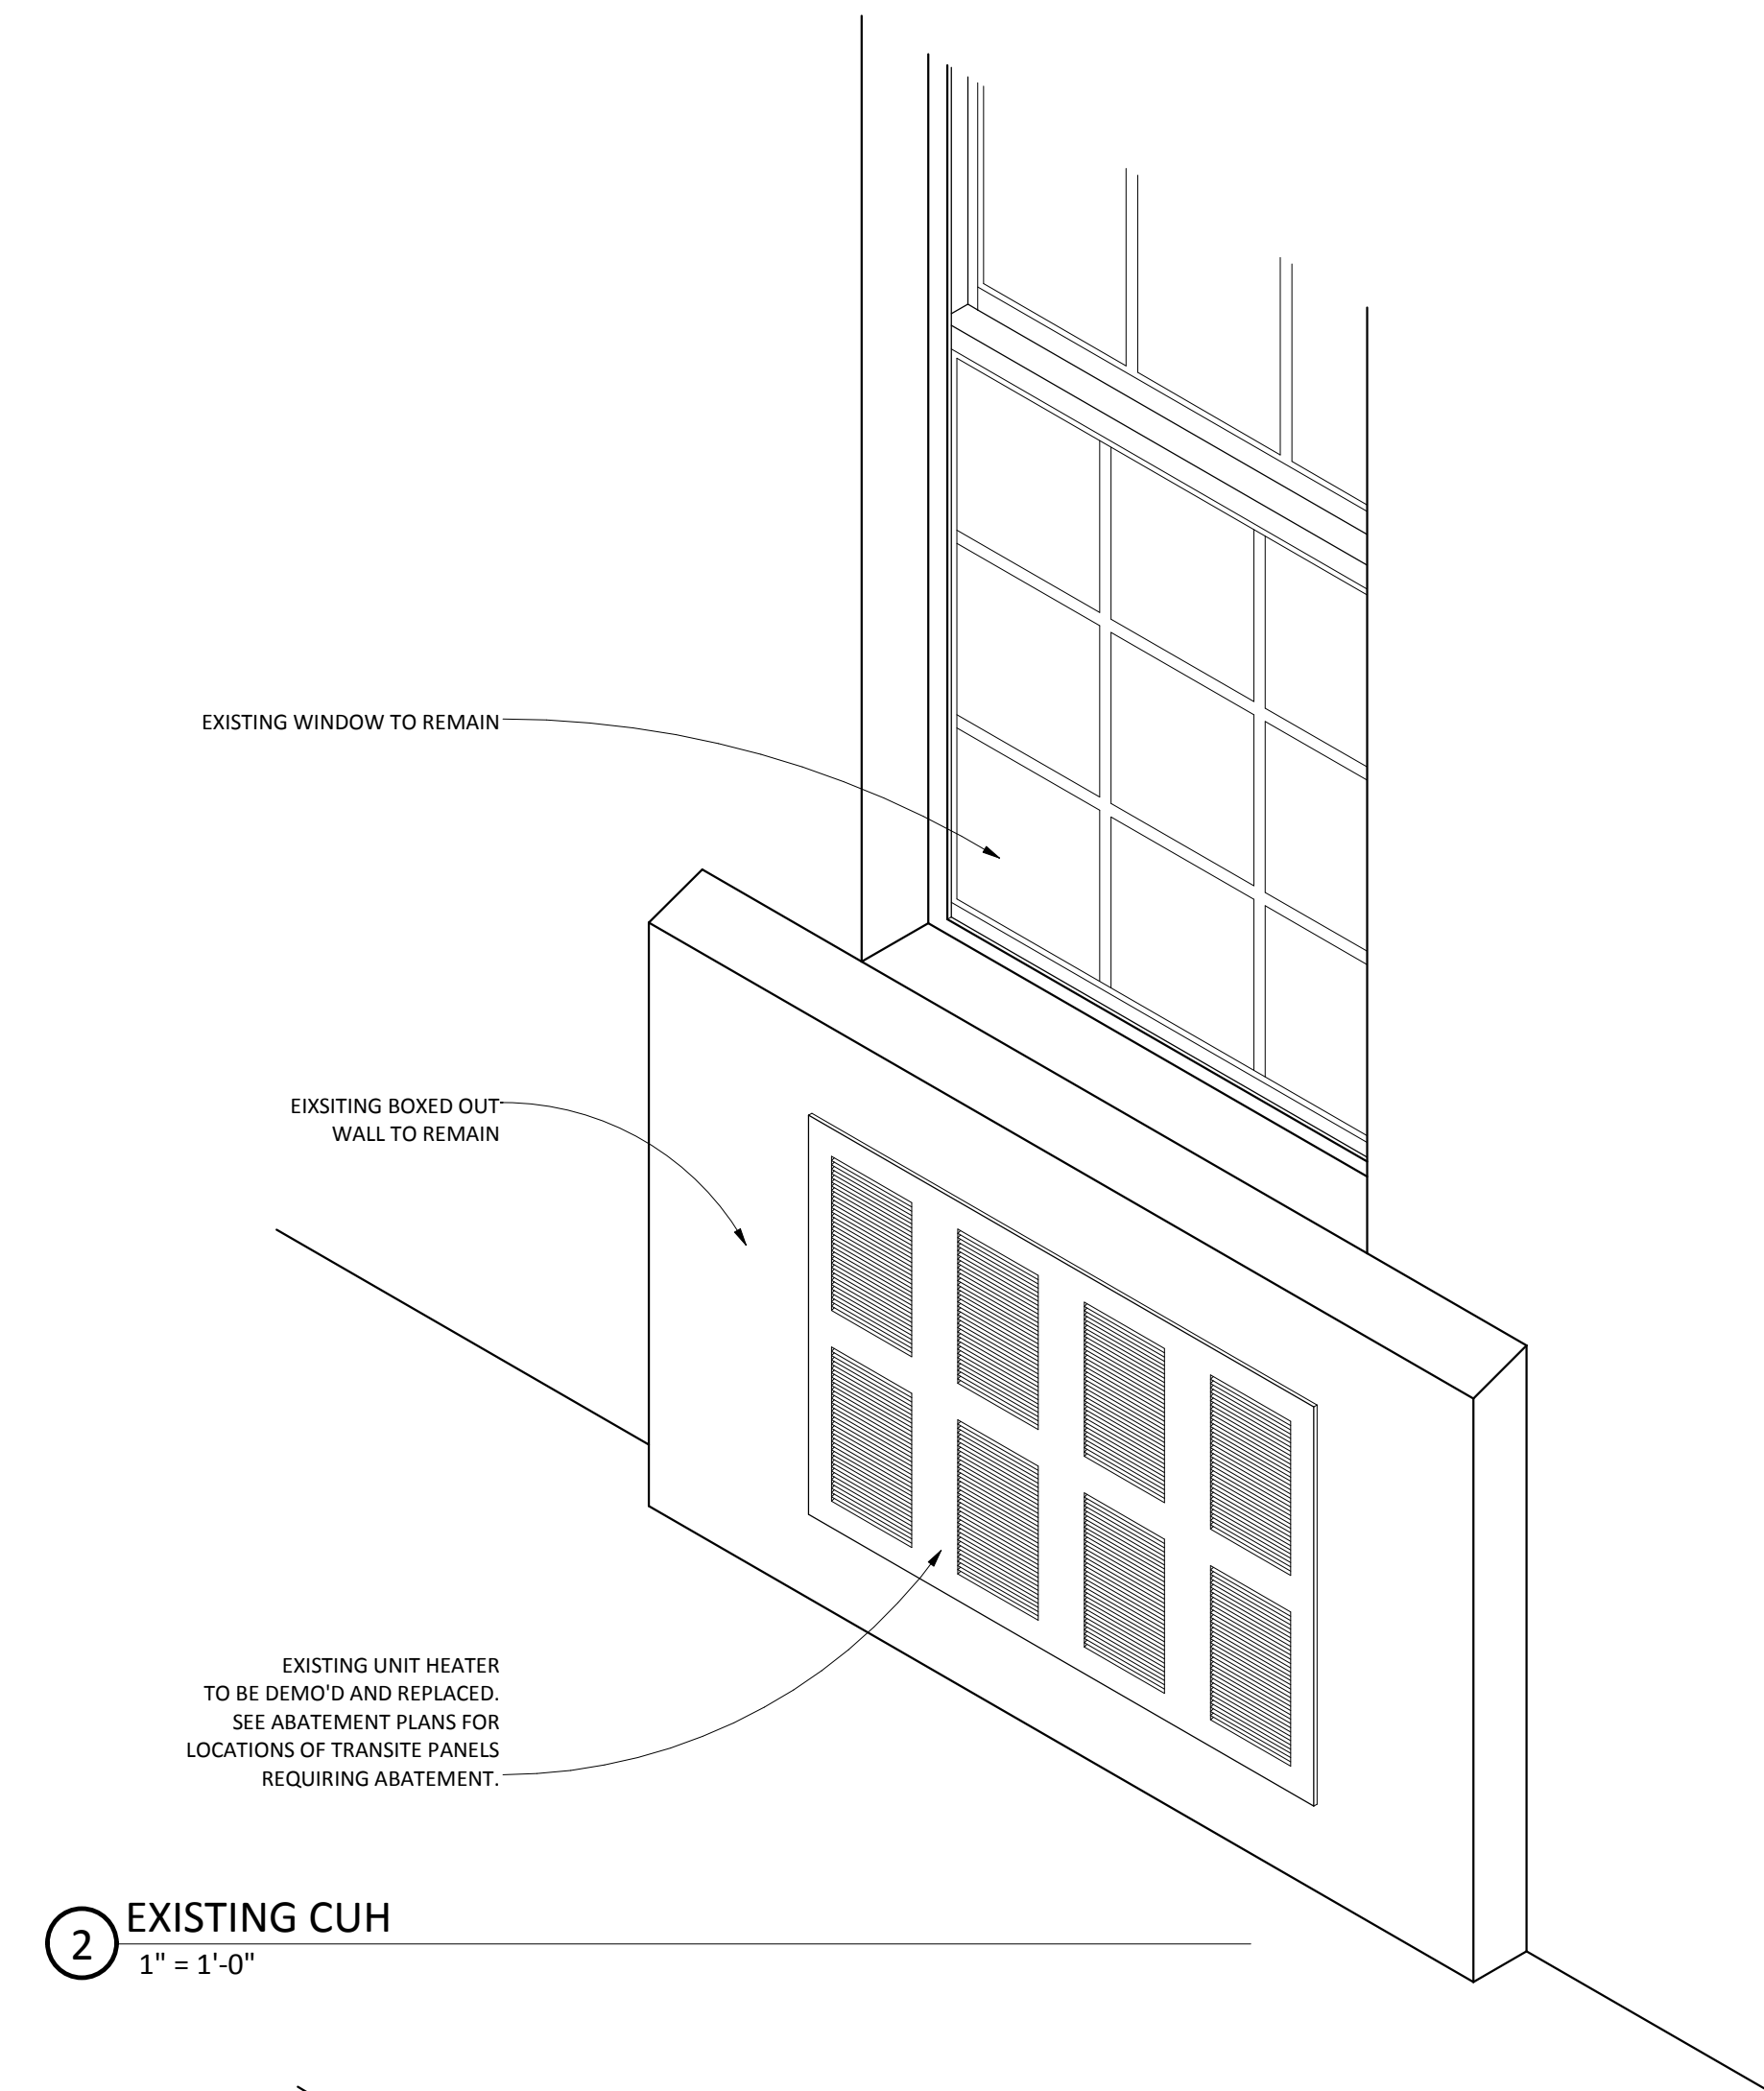

② EXISTING CUH
1" = 1'-0"

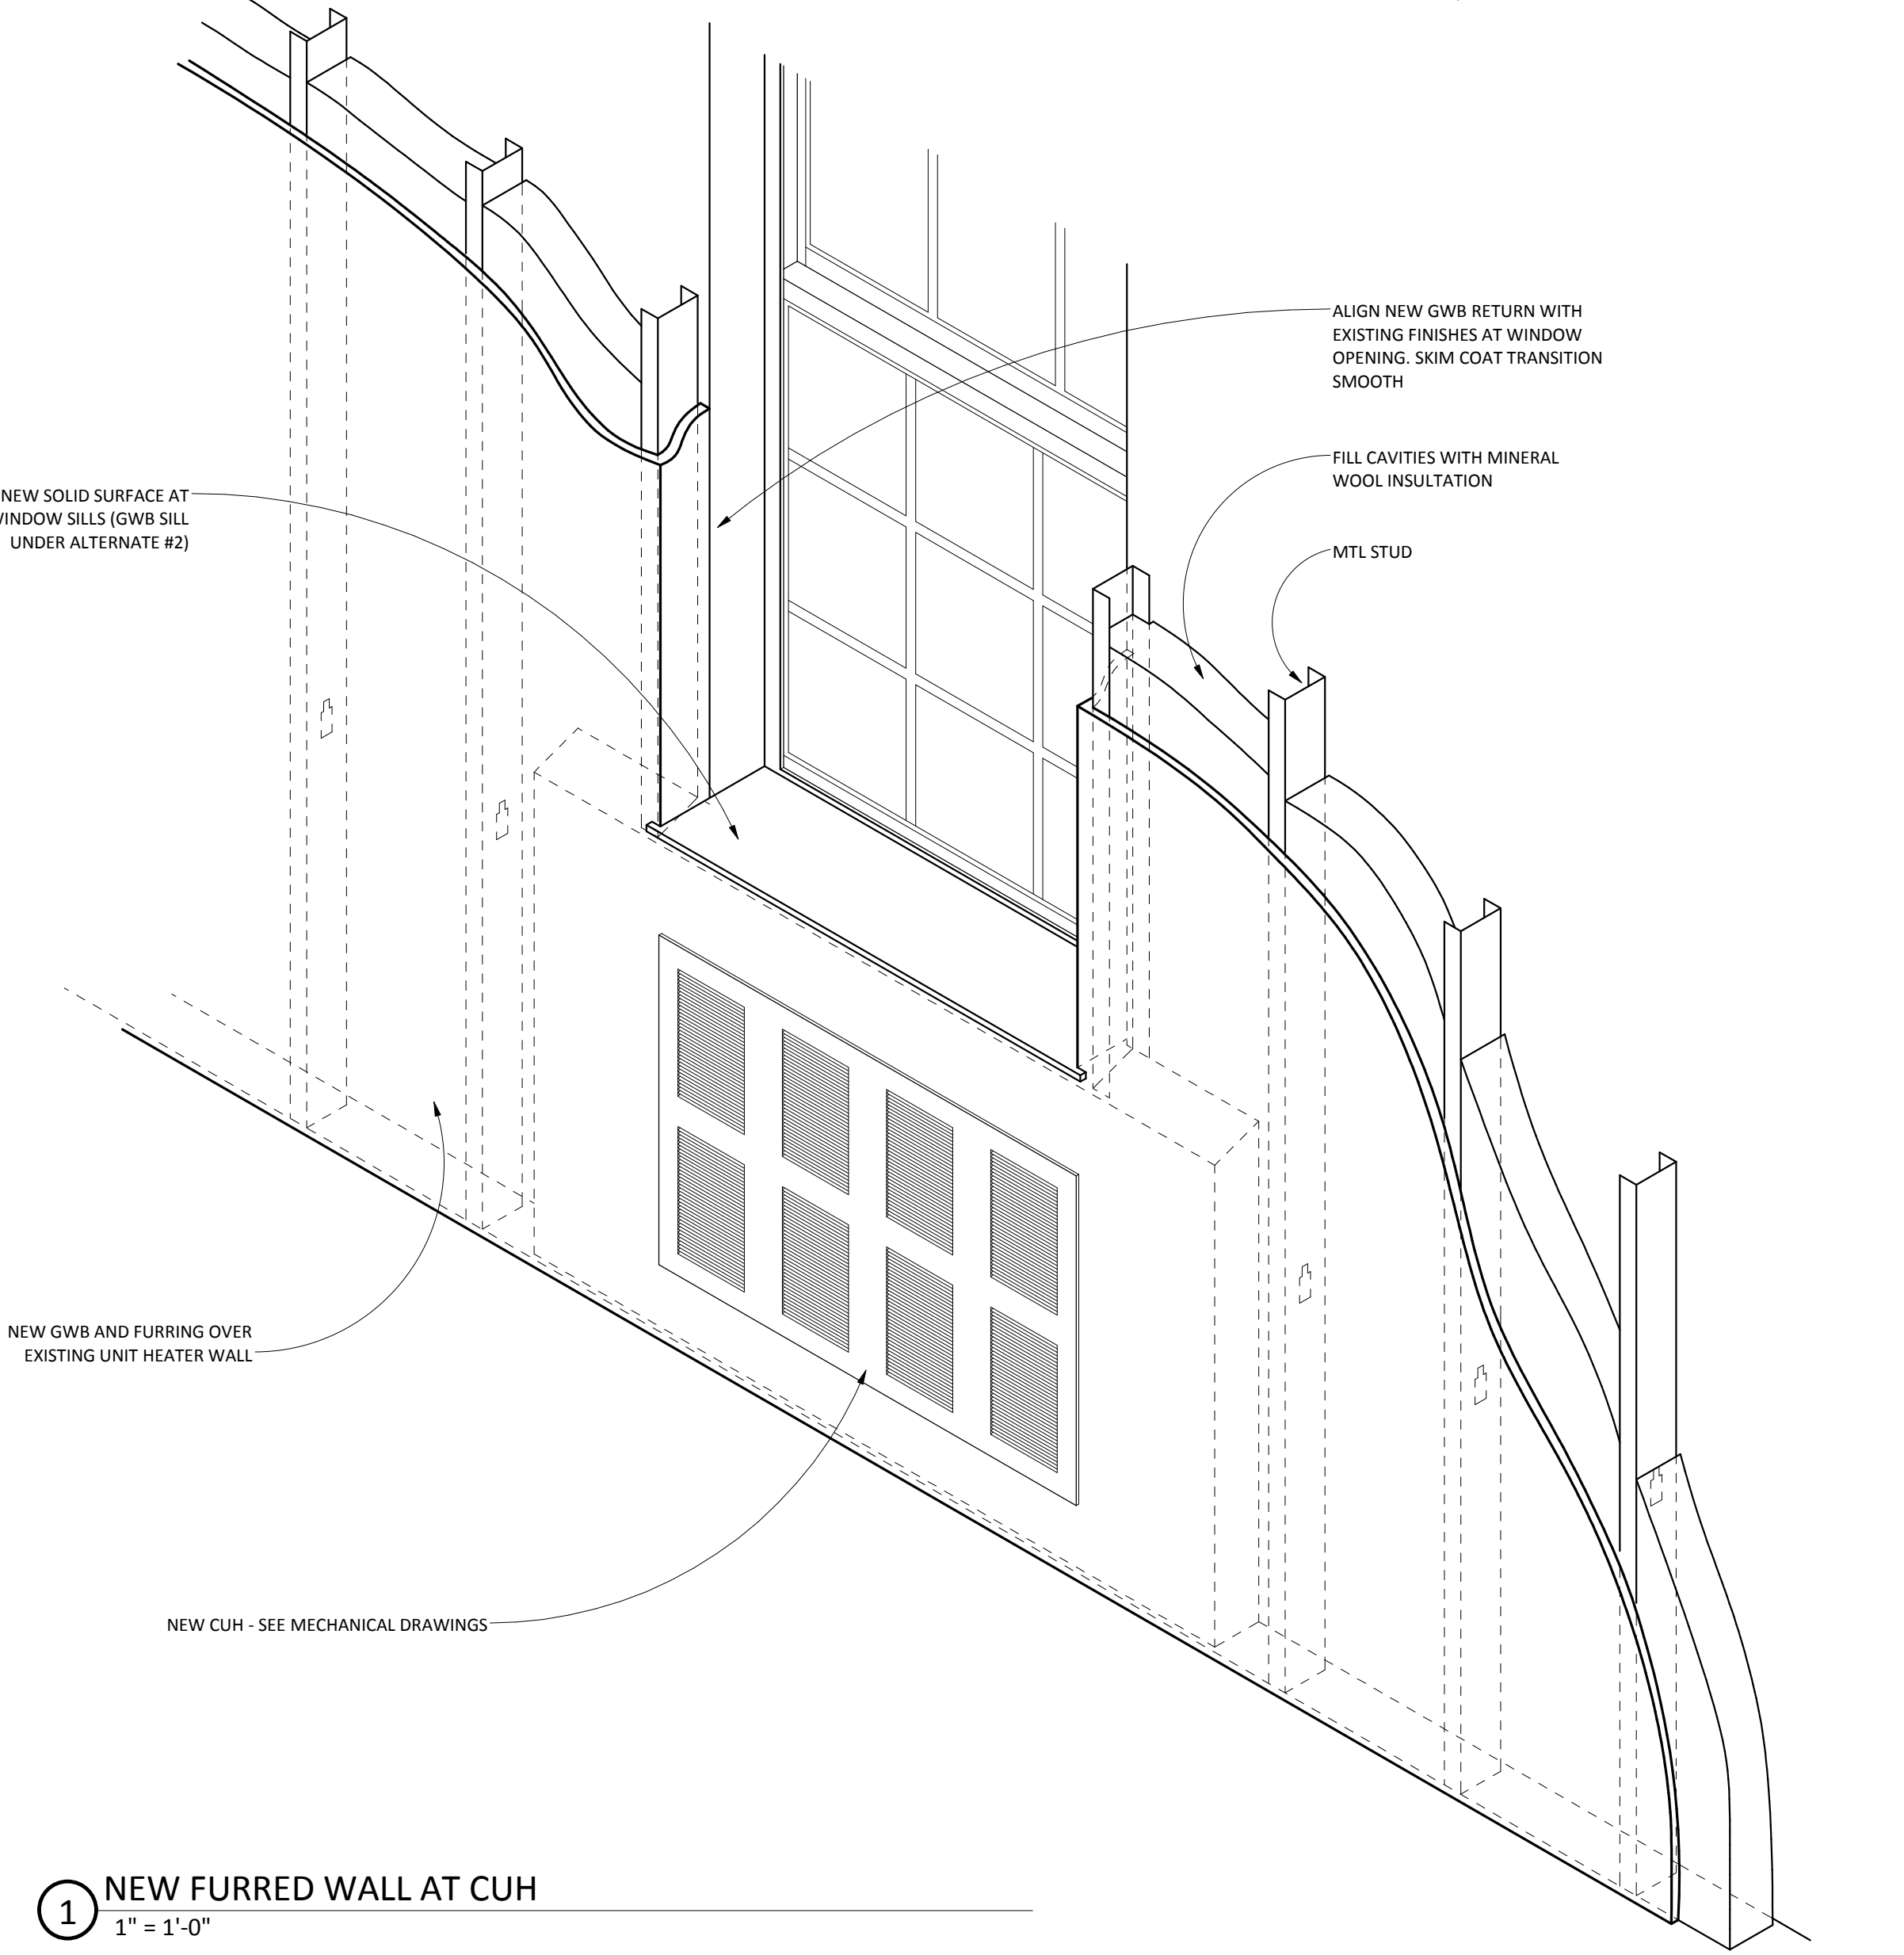

① NEW FURRED WALL AT CUH
1" = 1'-0"

No	REVISION	DATE



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UNDER THE LAWS OF THE STATE OF MINNESOTA
DANIEL J. MILLER, AIA
DATE: 12-20-2013
MIN. JOB NO.
REG. NO.

DRAWING TITLE
INTERIOR DETAILS

PROJECT TITLE
RECONFIGURE/EXPAND
BUILDINGS 28 & 9 FOR
RESIDENTIAL REHABILITATION
TREATMENT PROGRAM

BUILDING No. 28
CHECKED BY DJM
DRAWN ADB
LOCATION
ST. CLOUD VA MEDICAL CENTER
ST. CLOUD, MN 56303

DATE 12.20.13
PROJECT NO. 656-12-339


DWG FILE
DRAWING NO. AS152



100% CD SET

FOR CONSTRUCTION


three inches = one foot
one and one half inches = one foot
one inch = one foot
three quarters inch = one foot
one half inch = one foot
three eighths inch = one foot
one quarter inch = one foot
one eighth inch = one foot

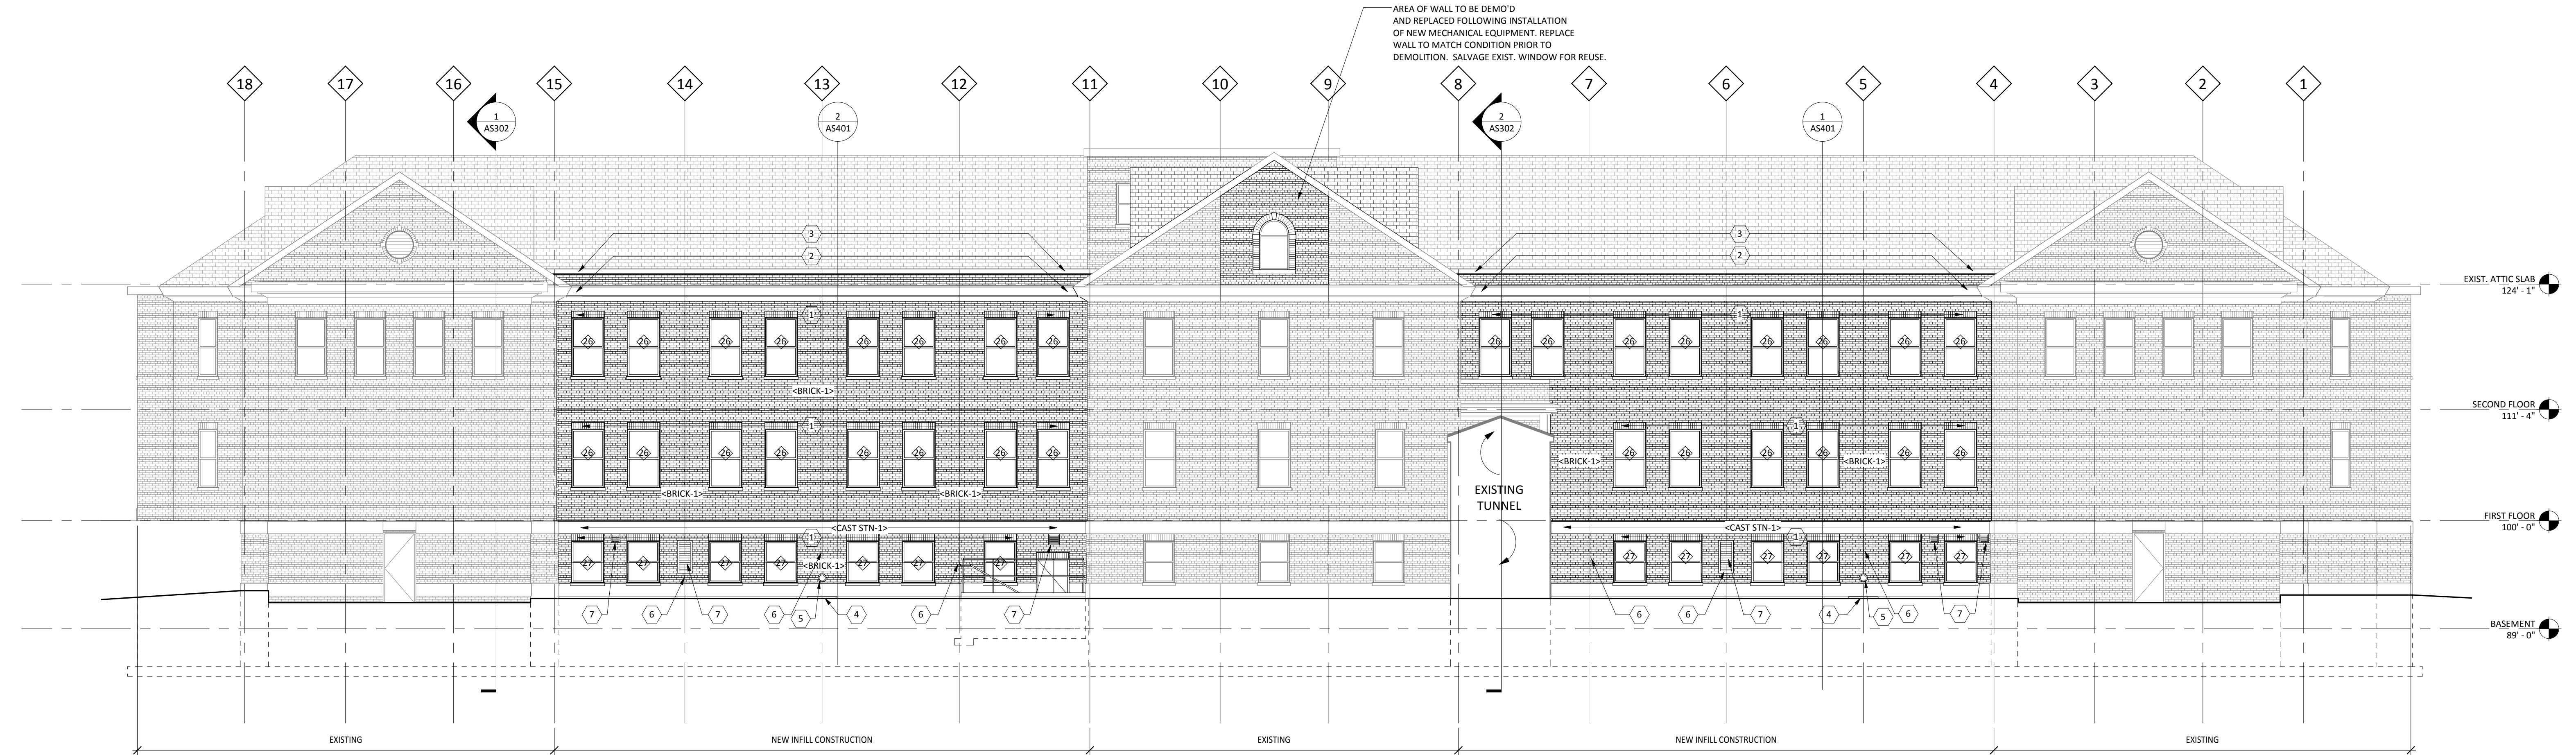

3 NORTH ELEVATION
1/8" = 1'-0"

SHEET MATERIAL ID LIST	
MATERIAL ID	SPEC SECTION & DESCRIPTION
BRICK-1	04 2000 - FACE BRICK
CAST STN-1	04 7200 - CAST STONE SILL, HEADER, WALL CAP

ELEVATION KEYNOTES	
NO.	Note
1	SOLDIER COURSE
2	DECORATIVE CORNICE/GUTTER TO MATCH EXISTING
3	PREFIN. METAL PARAPET CAP
4	CONCRETE SPLASH PAD
5	SCUPPER AT GRADE
6	MASONRY CONTROL JOINT
7	MECH. PENETRATION. SEE MECH. DRAWINGS

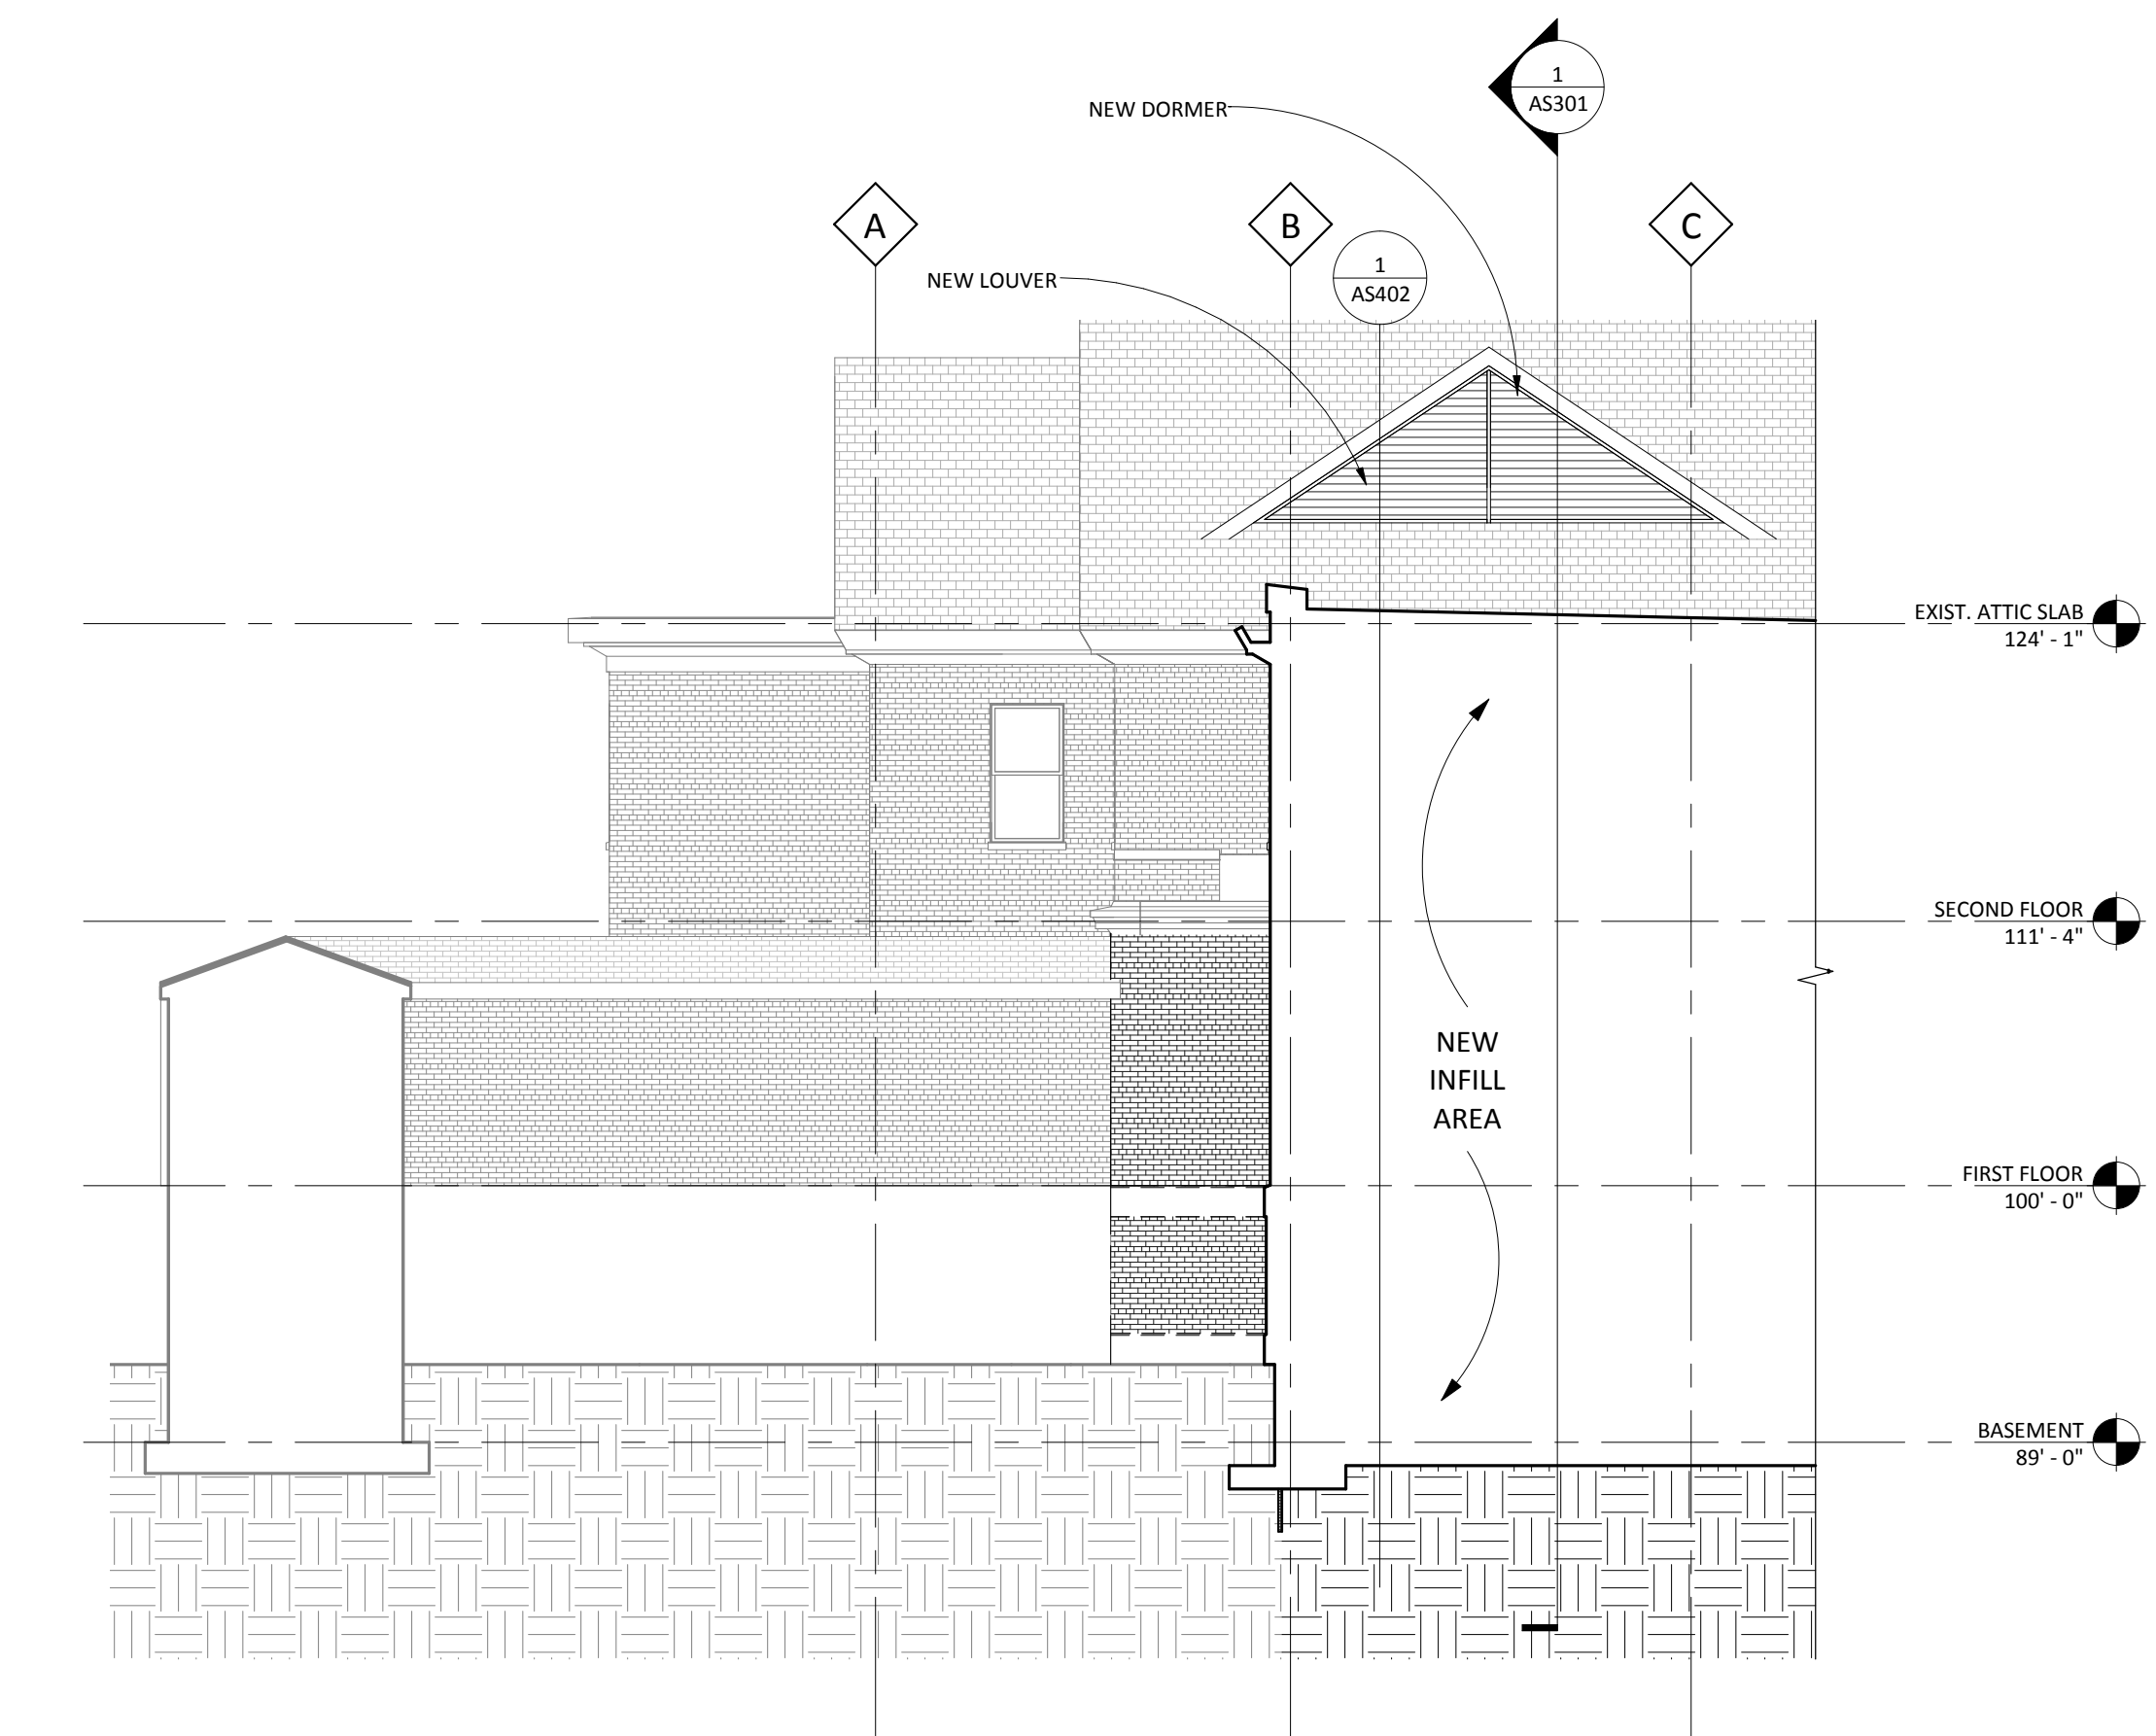

2 INFILL ELEVATION AT TUNNEL
1/8" = 1'-0"



1 HORIZONTAL PRECAST WALL ELEVATION
1/8" = 1'-0"

*CONTRACTOR TO FIELD VERIFY ALL MEASUREMENTS

NO.	REVISION	DATE

VA FORM 05-6231



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DATE: 12-20-2013
MIN. REG. NO. 12-20-2013

DRAWING TITLE
EXTERIOR ELEVATIONS

PROJECT TITLE
RECONFIGURE/EXPAND
BUILDINGS 28 & 9 FOR
RESIDENTIAL REHABILITATION
TREATMENT PROGRAM
BUILDING No. 28
CHECKED BY DJM
DRAWN ADB
DATE 12-20-2013
LOCATION
ST. CLOUD VA MEDICAL CENTER
ST. CLOUD, MN 56303


DATE
12.20.13
AS NOTED
PROJECT NO.
656-12-339
DOW FILE
DRAWING NO.
AS201




100% CD SET

FOR CONSTRUCTION

three inches = one foot
one and one half inches = one foot
one inch = one foot
three quarters inch = one foot
one half inch = one foot
three eighths inch = one foot
one quarter inch = one foot
one eighth inch = one foot

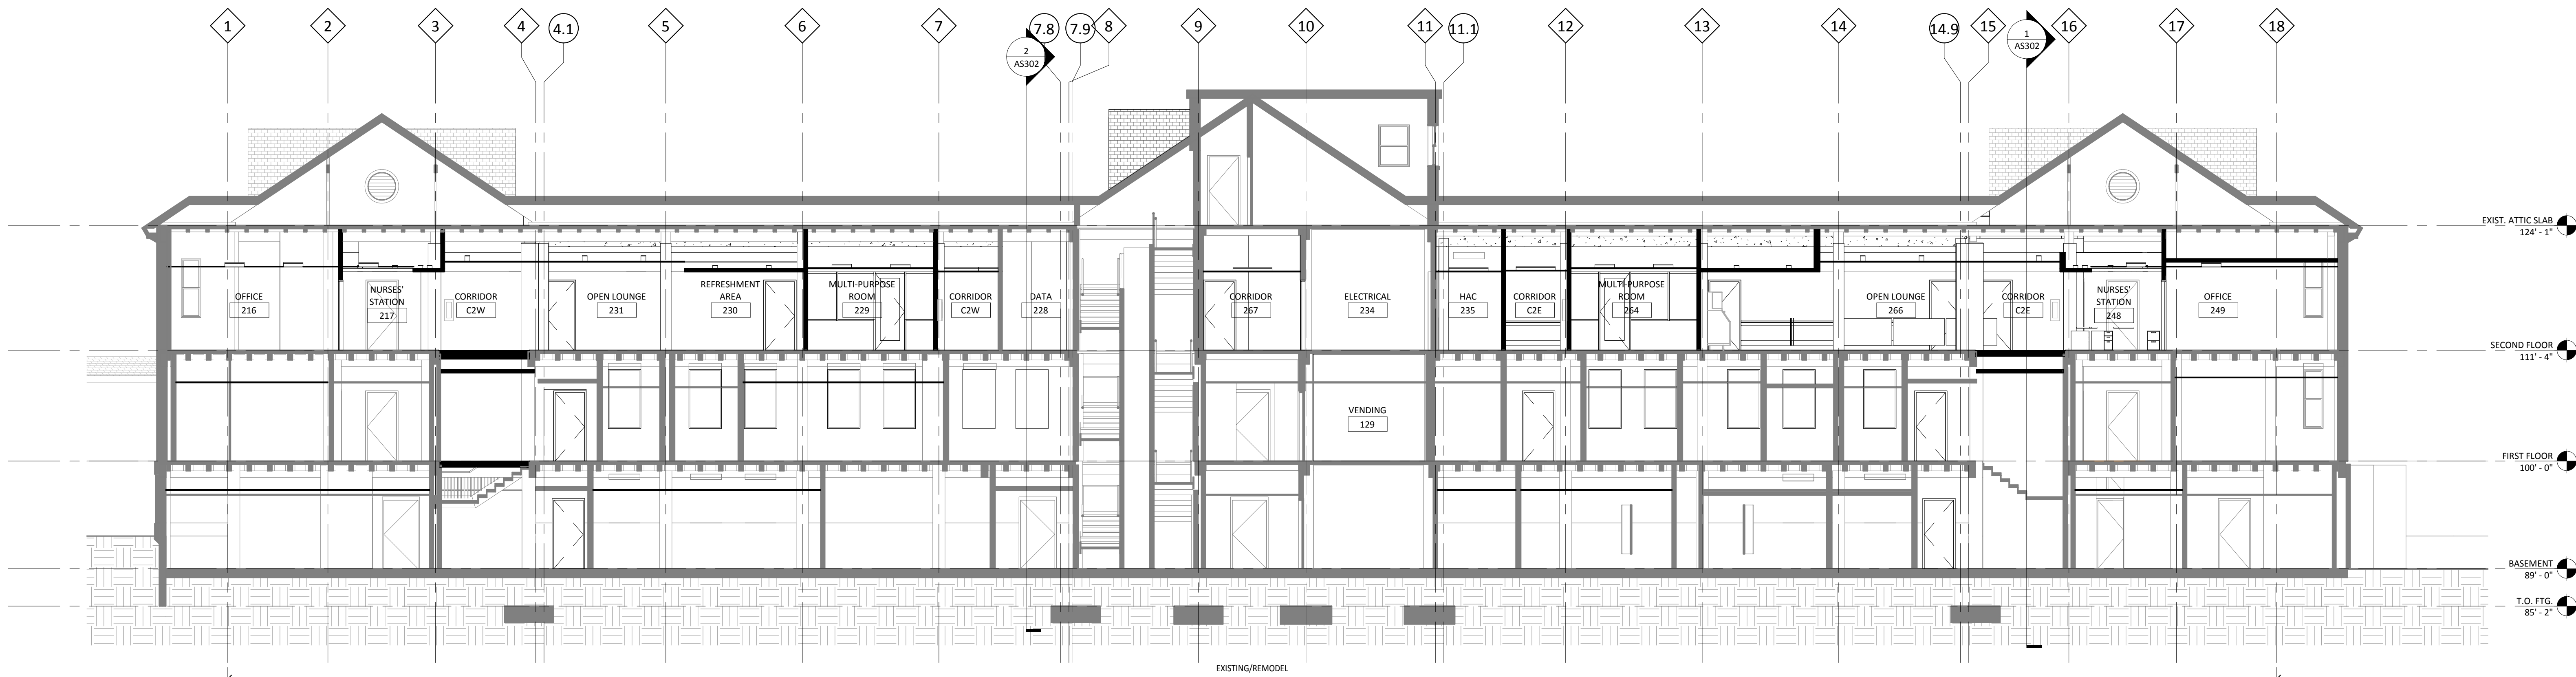

2 BUILDING SECTION AT ELEVATOR PENTHOUSE
1/8" = 1'-0"

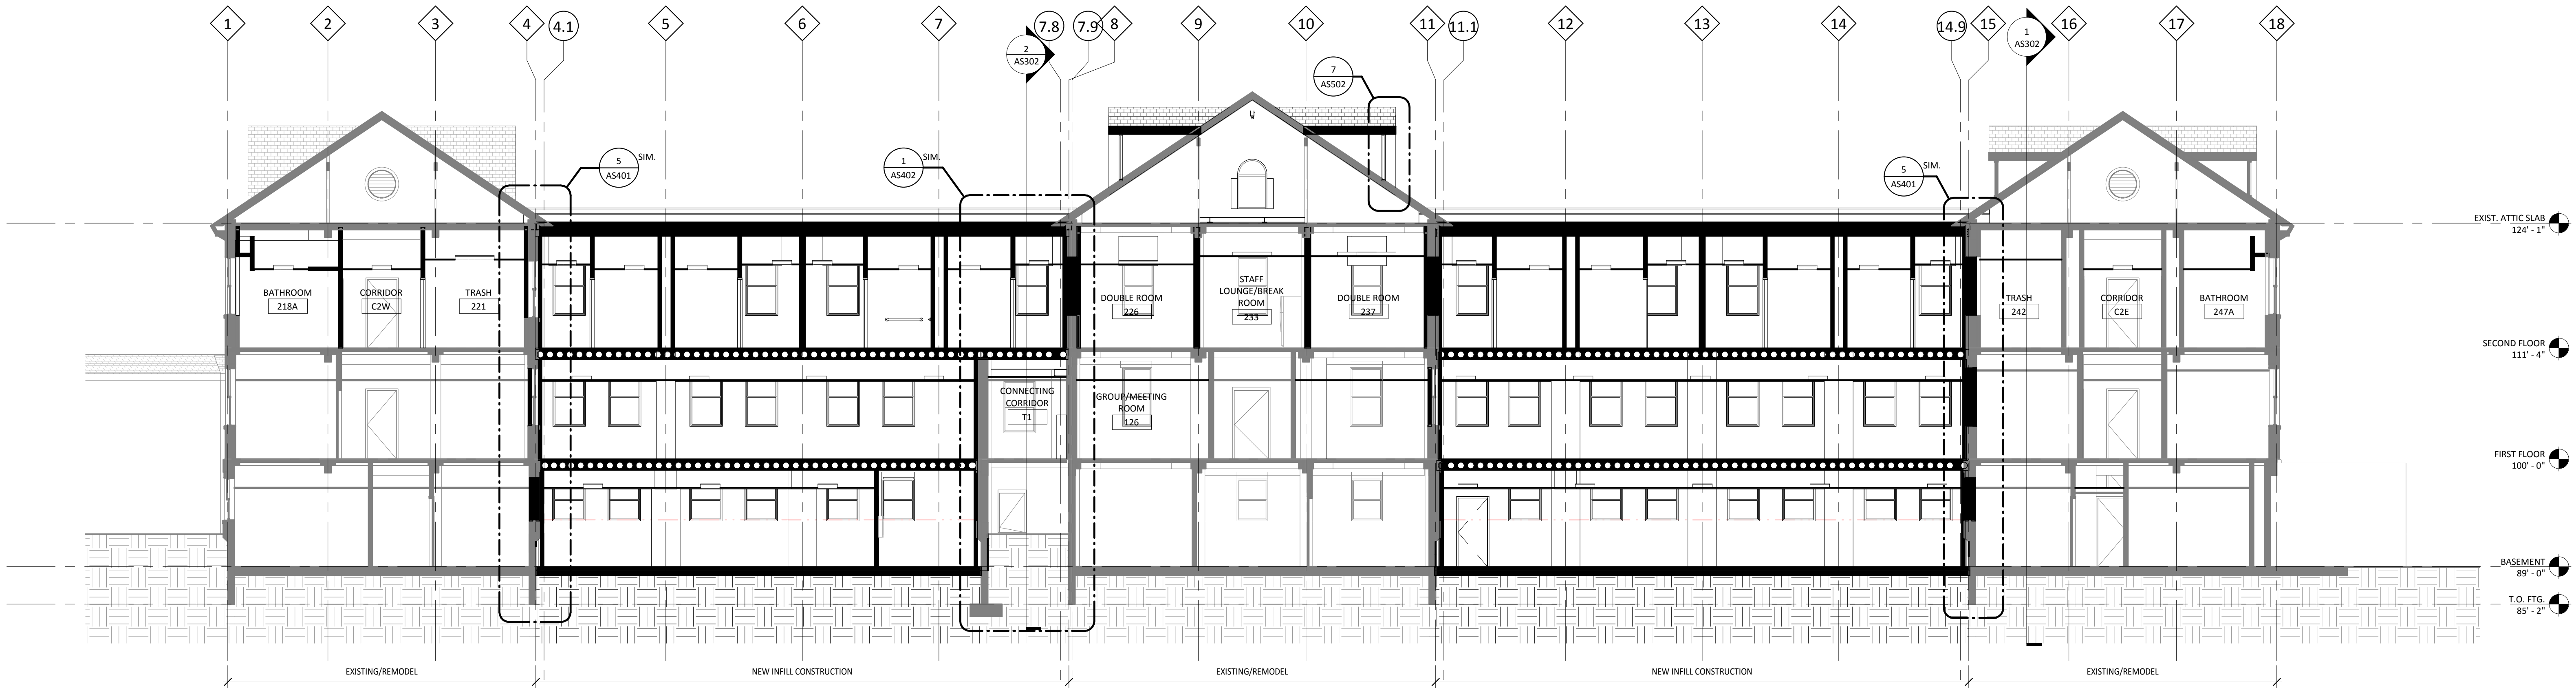

1 BUILDING SECTION AT INFILL
1/8" = 1'-0"

100% CD SET

FOR
CONSTRUCTION

NO	REVISION	DATE



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DANIEL J. MILLER, AIA
DATE: 12-20-2013
REG. NO. 656-12-339


DRAWING TITLE
BUILDING SECTION

PROJECT TITLE
RECONFIGURE/EXPAND
BUILDINGS 28 & 9 FOR
RESIDENTIAL REHABILITATION
TREATMENT PROGRAM

BUILDING No. 28
CHECKED BY DJM
DRAWN ADB
DATE 12-20-2013
REG. NO. 656-12-339

DATE 12.20.13
PROJECT NO. 656-12-339
DRAWING NO. AS301



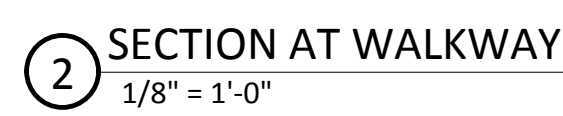


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MN 41-
REG-

DANIEL J. MILLER, AIA

DATE: 12-20-2013

DRAWING TITLE

BUILDING SECTIONS

PROJECT TITLE	RECONFIGURE/EXPAND BUILDINGS 28 & 9 FOR RESIDENTIAL REHABILITATION TREATMENT PROGRAM
---------------	-----------------------------------------------------------------------------------------------

BUILDING No	CHECKED BY	DRAWN
28	DJM	AD
LOCATION		
ST. CLOUD VA MEDICAL CENTER		
ST. CLOUD, MN 56303		

DATE	12.20.13
PLOT SCALE	AS NOTED
PROJECT NO.	656-12-339
CAD FILE	
DRAWING NO.	AS302




St. Cloud VA
Health Care System
 Brainerd | Montevideo | Alexandria

100% CD SET

FOR
CONSTRUCTION

three eighths inch = one foot
one eighth inch = one foot
one quarter inch = one foot
three quarters inch = one foot
one half inch = one foot
one inch = one foot
one and one half inches = one foot
two inches = one foot
three inches = one foot
four inches = one foot
five inches = one foot
six inches = one foot
seven inches = one foot
eight inches = one foot
nine inches = one foot
ten inches = one foot
eleven inches = one foot
twelve inches = one foot
thirteen inches = one foot
fourteen inches = one foot
fifteen inches = one foot
sixteen inches = one foot
seventeen inches = one foot
eighteen inches = one foot
nineteen inches = one foot
twenty inches = one foot
twenty one inches = one foot
twenty two inches = one foot
twenty three inches = one foot
twenty four inches = one foot
twenty five inches = one foot
twenty six inches = one foot
twenty seven inches = one foot
twenty eight inches = one foot
twenty nine inches = one foot
thirty inches = one foot
thirty one inches = one foot
thirty two inches = one foot
thirty three inches = one foot
thirty four inches = one foot
thirty five inches = one foot
thirty six inches = one foot
thirty seven inches = one foot
thirty eight inches = one foot
thirty nine inches = one foot
forty inches = one foot
forty one inches = one foot
forty two inches = one foot
forty three inches = one foot
forty four inches = one foot
forty five inches = one foot
forty six inches = one foot
forty seven inches = one foot
forty eight inches = one foot
forty nine inches = one foot
fifty inches = one foot
fifty one inches = one foot
fifty two inches = one foot
fifty three inches = one foot
fifty four inches = one foot
fifty five inches = one foot
fifty six inches = one foot
fifty seven inches = one foot
fifty eight inches = one foot
fifty nine inches = one foot
sixty inches = one foot
sixty one inches = one foot
sixty two inches = one foot
sixty three inches = one foot
sixty four inches = one foot
sixty five inches = one foot
sixty six inches = one foot
sixty seven inches = one foot
sixty eight inches = one foot
sixty nine inches = one foot
seventy inches = one foot
seventy one inches = one foot
seventy two inches = one foot
seventy three inches = one foot
seventy four inches = one foot
seventy five inches = one foot
seventy six inches = one foot
seventy seven inches = one foot
seventy eight inches = one foot
seventy nine inches = one foot
eighty inches = one foot
eighty one inches = one foot
eighty two inches = one foot
eighty three inches = one foot
eighty four inches = one foot
eighty five inches = one foot
eighty six inches = one foot
eighty seven inches = one foot
eighty eight inches = one foot
eighty nine inches = one foot
ninety inches = one foot
ninety one inches = one foot
ninety two inches = one foot
ninety three inches = one foot
ninety four inches = one foot
ninety five inches = one foot
ninety six inches = one foot
ninety seven inches = one foot
ninety eight inches = one foot
ninety nine inches = one foot
one hundred inches = one foot

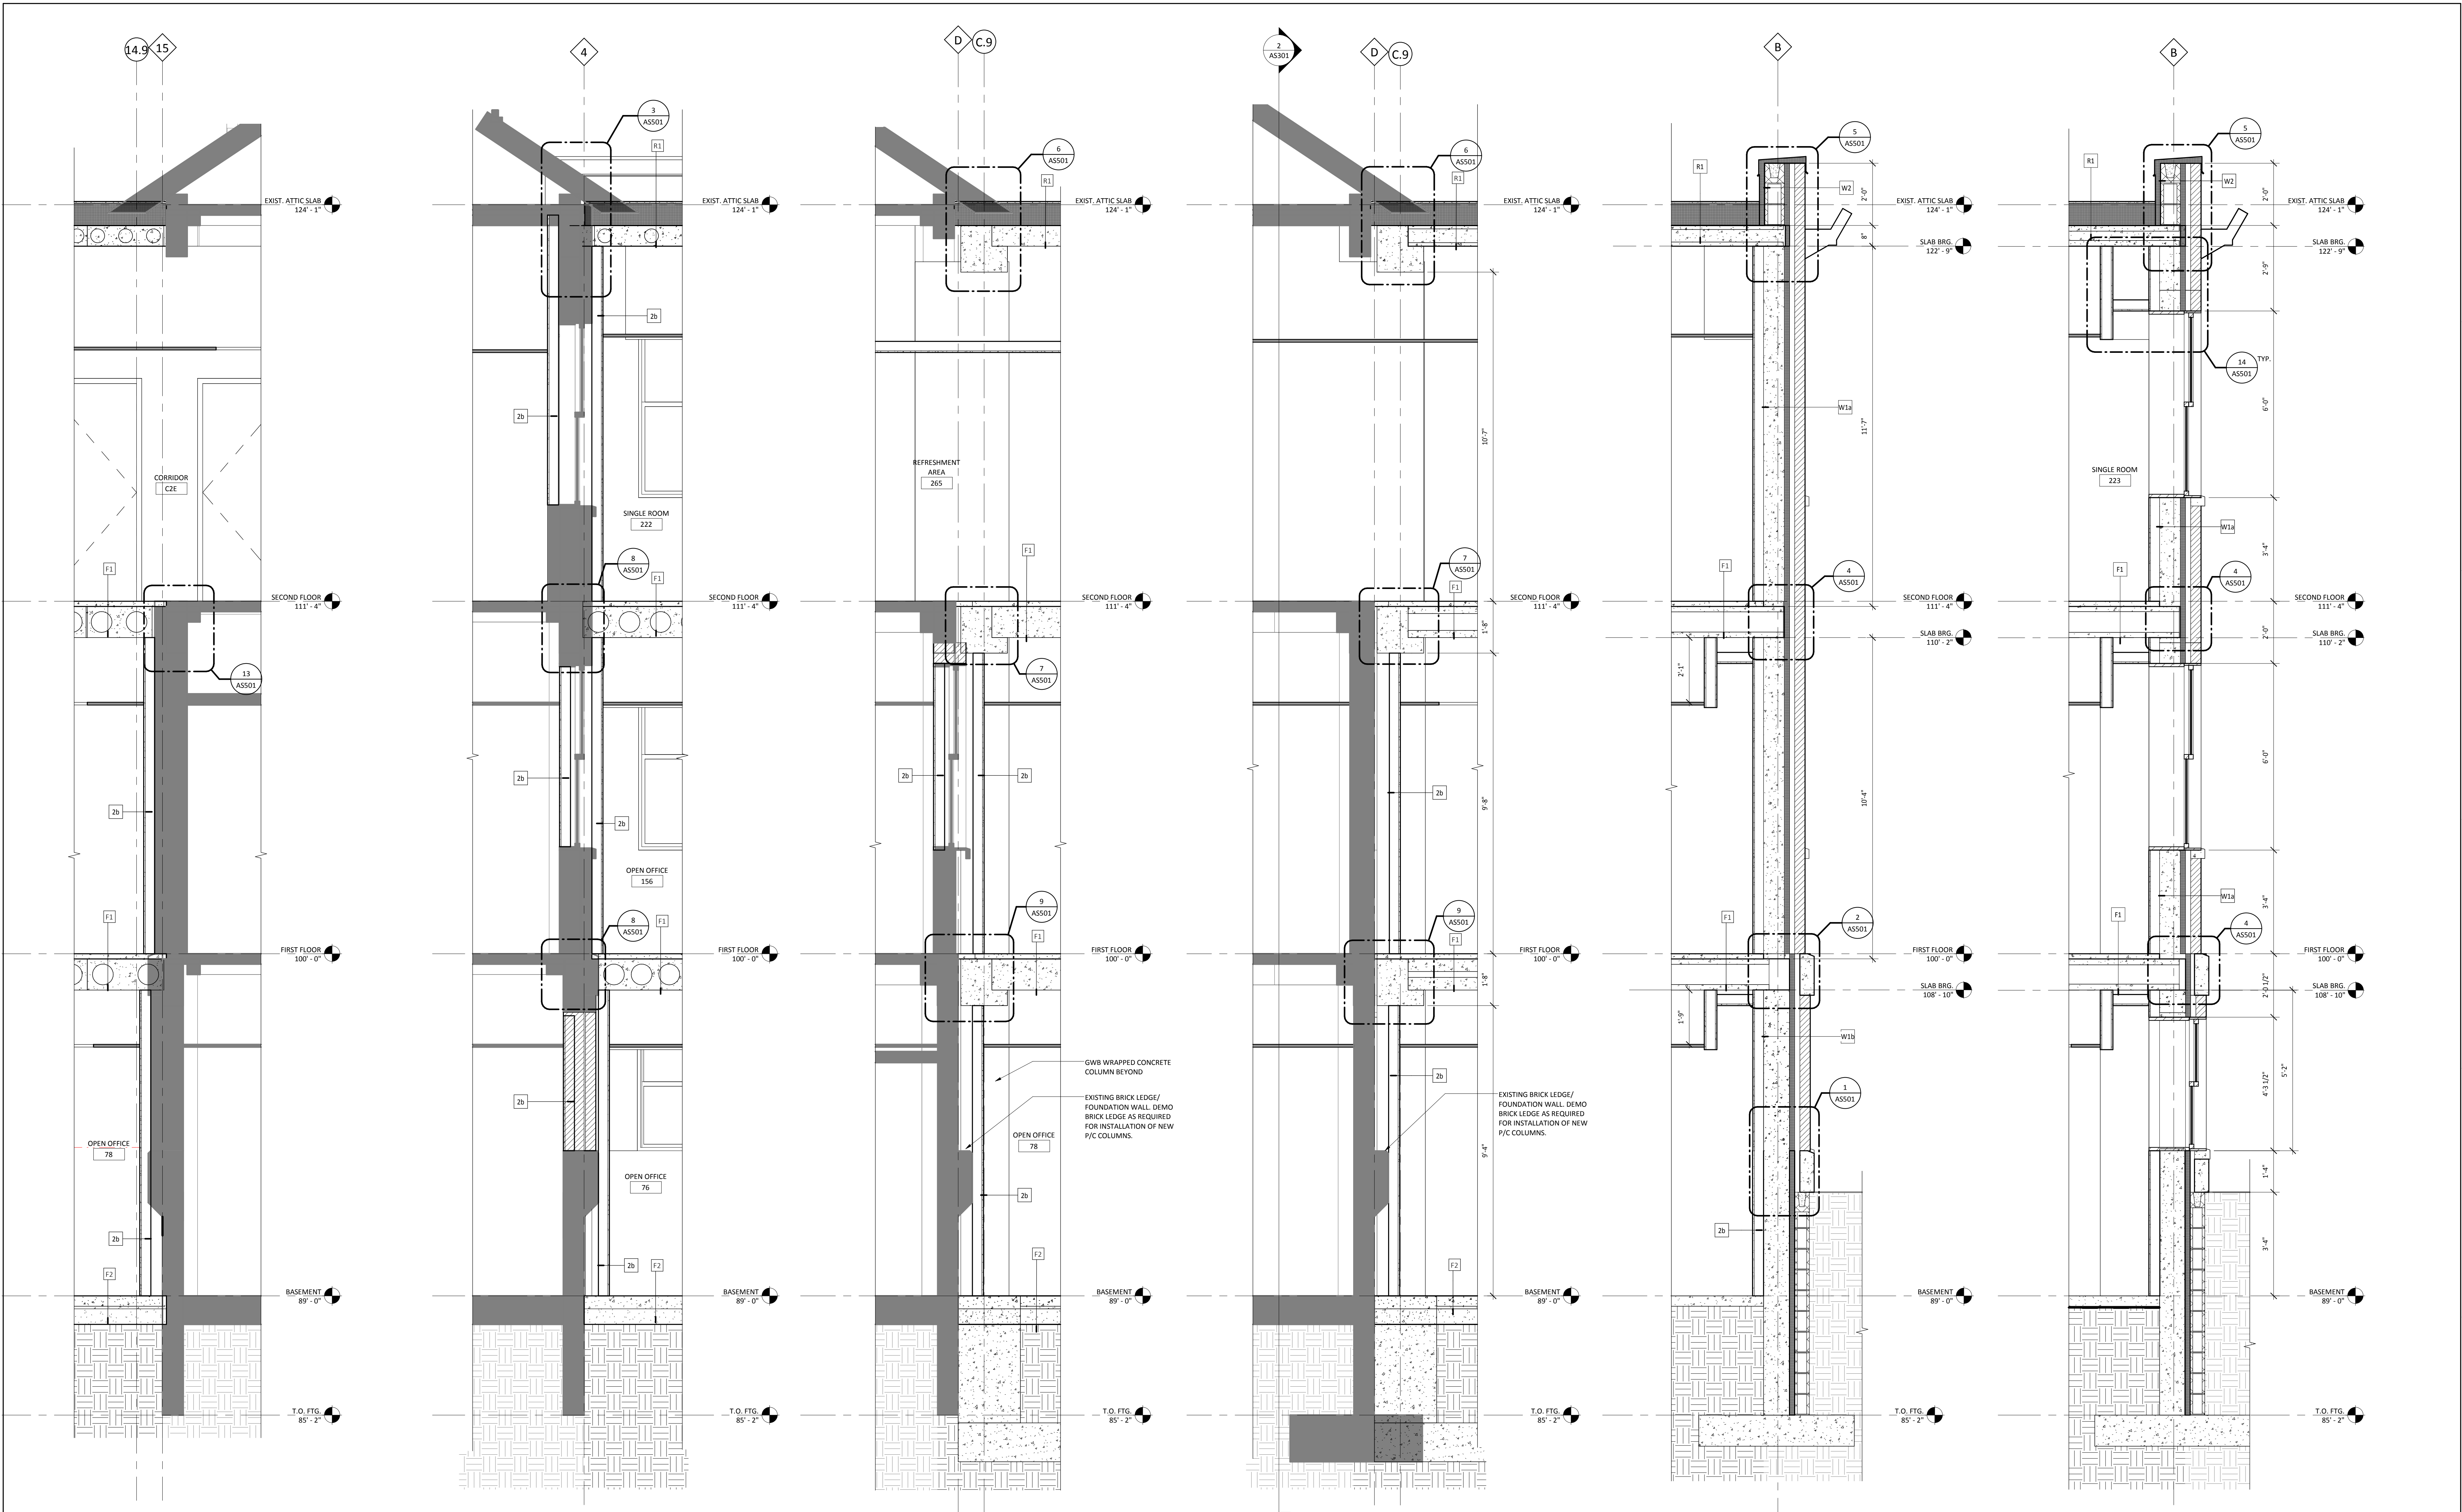


6 EAST WALL EAST INFILL 1/2" = 1'-0"
5 WEST WALL WEST INFILL 1/2" = 1'-0"
4 Section 24 1/2" = 1'-0"
3 WALL SECTION AT NEW COLUMN LINE 1/2" = 1'-0"
2 WALL SECTION AT CAVITY WALL 1/2" = 1'-0"
1 WALL SECTION AT EXT. WALL 1/2" = 1'-0"


100% CD SET FOR CONSTRUCTION

<div>STAMPED 12.20.13 PROJECT NO. 656-12-339 DRAWING NO. AS401</div>		<div>PROJECT TITLE RECONFIGURE/EXPAND BUILDINGS 28 & 9 FOR RESIDENTIAL REHABILITATION TREATMENT PROGRAM</div>	<div>DATE 12.20.13 PROJECT NO. 656-12-339 DRAWING NO. AS401</div>	<div>ST. CLOUD VA Health Care System Brainerd Montevideo Alexandria</div>
<div>REVISION DATE</div>		<div>FOR CONSTRUCTION</div>		


three inches = one foot
one and one half inches = one foot
one inch = one foot
three quarters inch = one foot
one half inch = one foot
three eighths inch = one foot
one quarter inch = one foot
one eighth inch = one foot

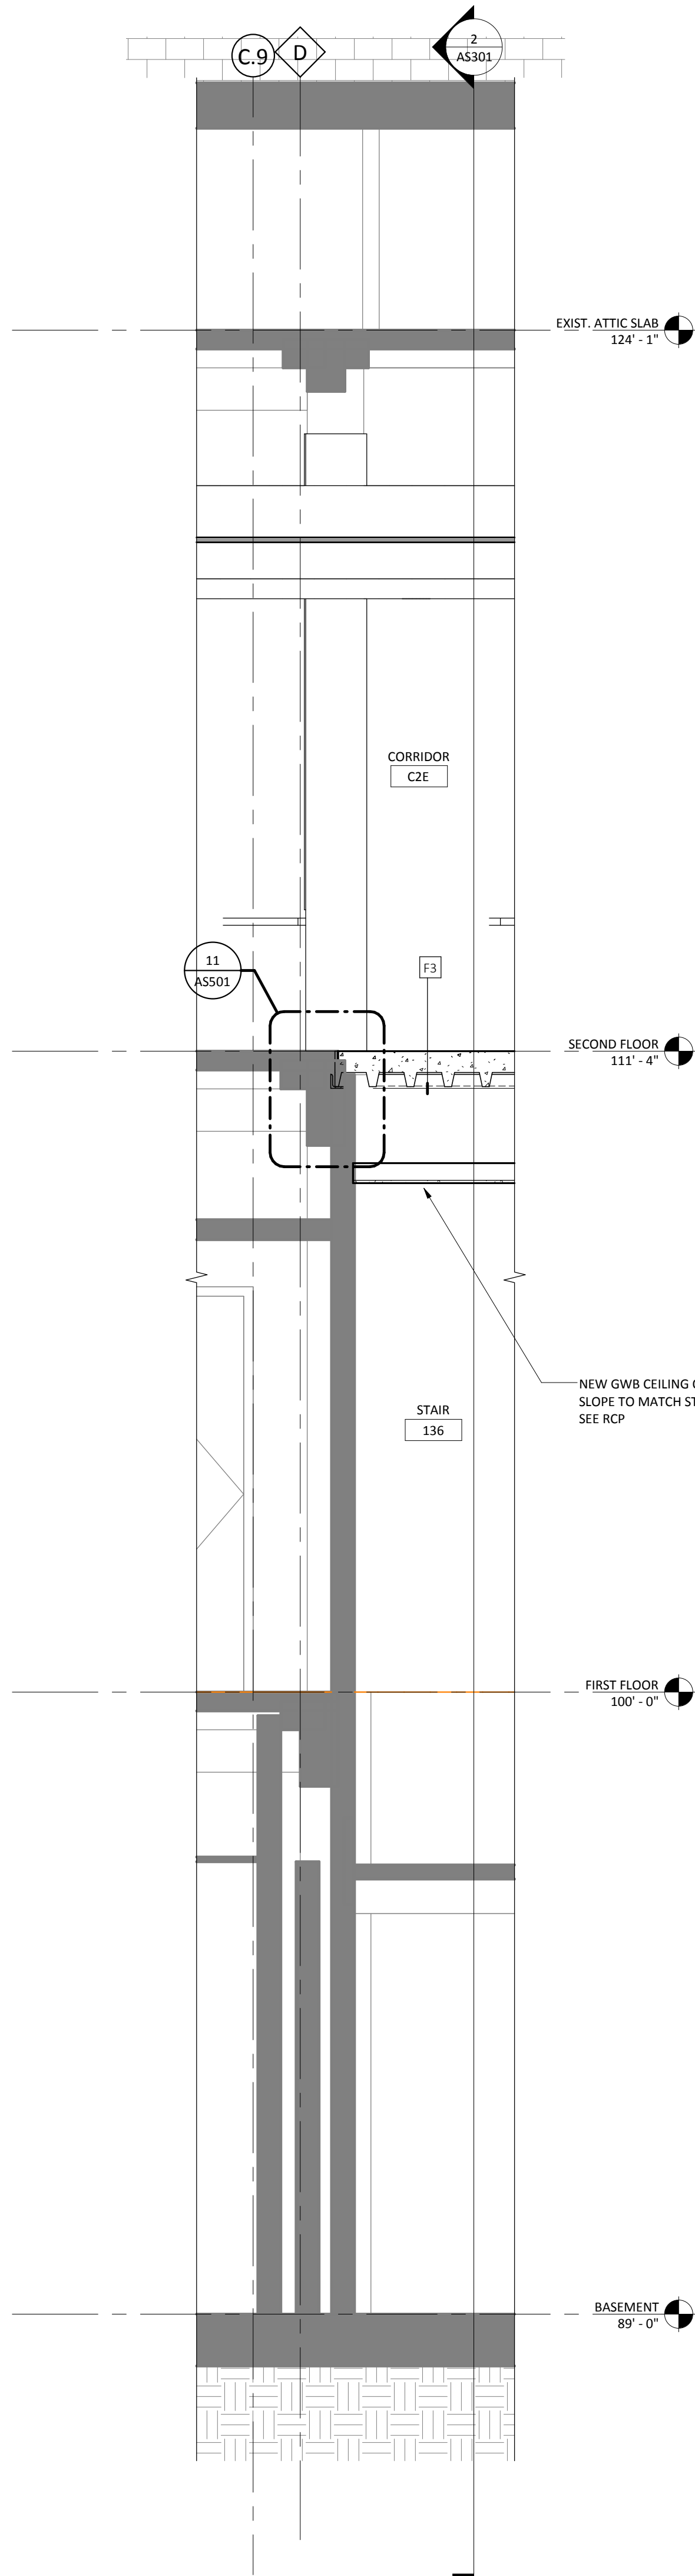

3 WALL SECTION AT STAIR INFILL
1/2" = 1'-0"

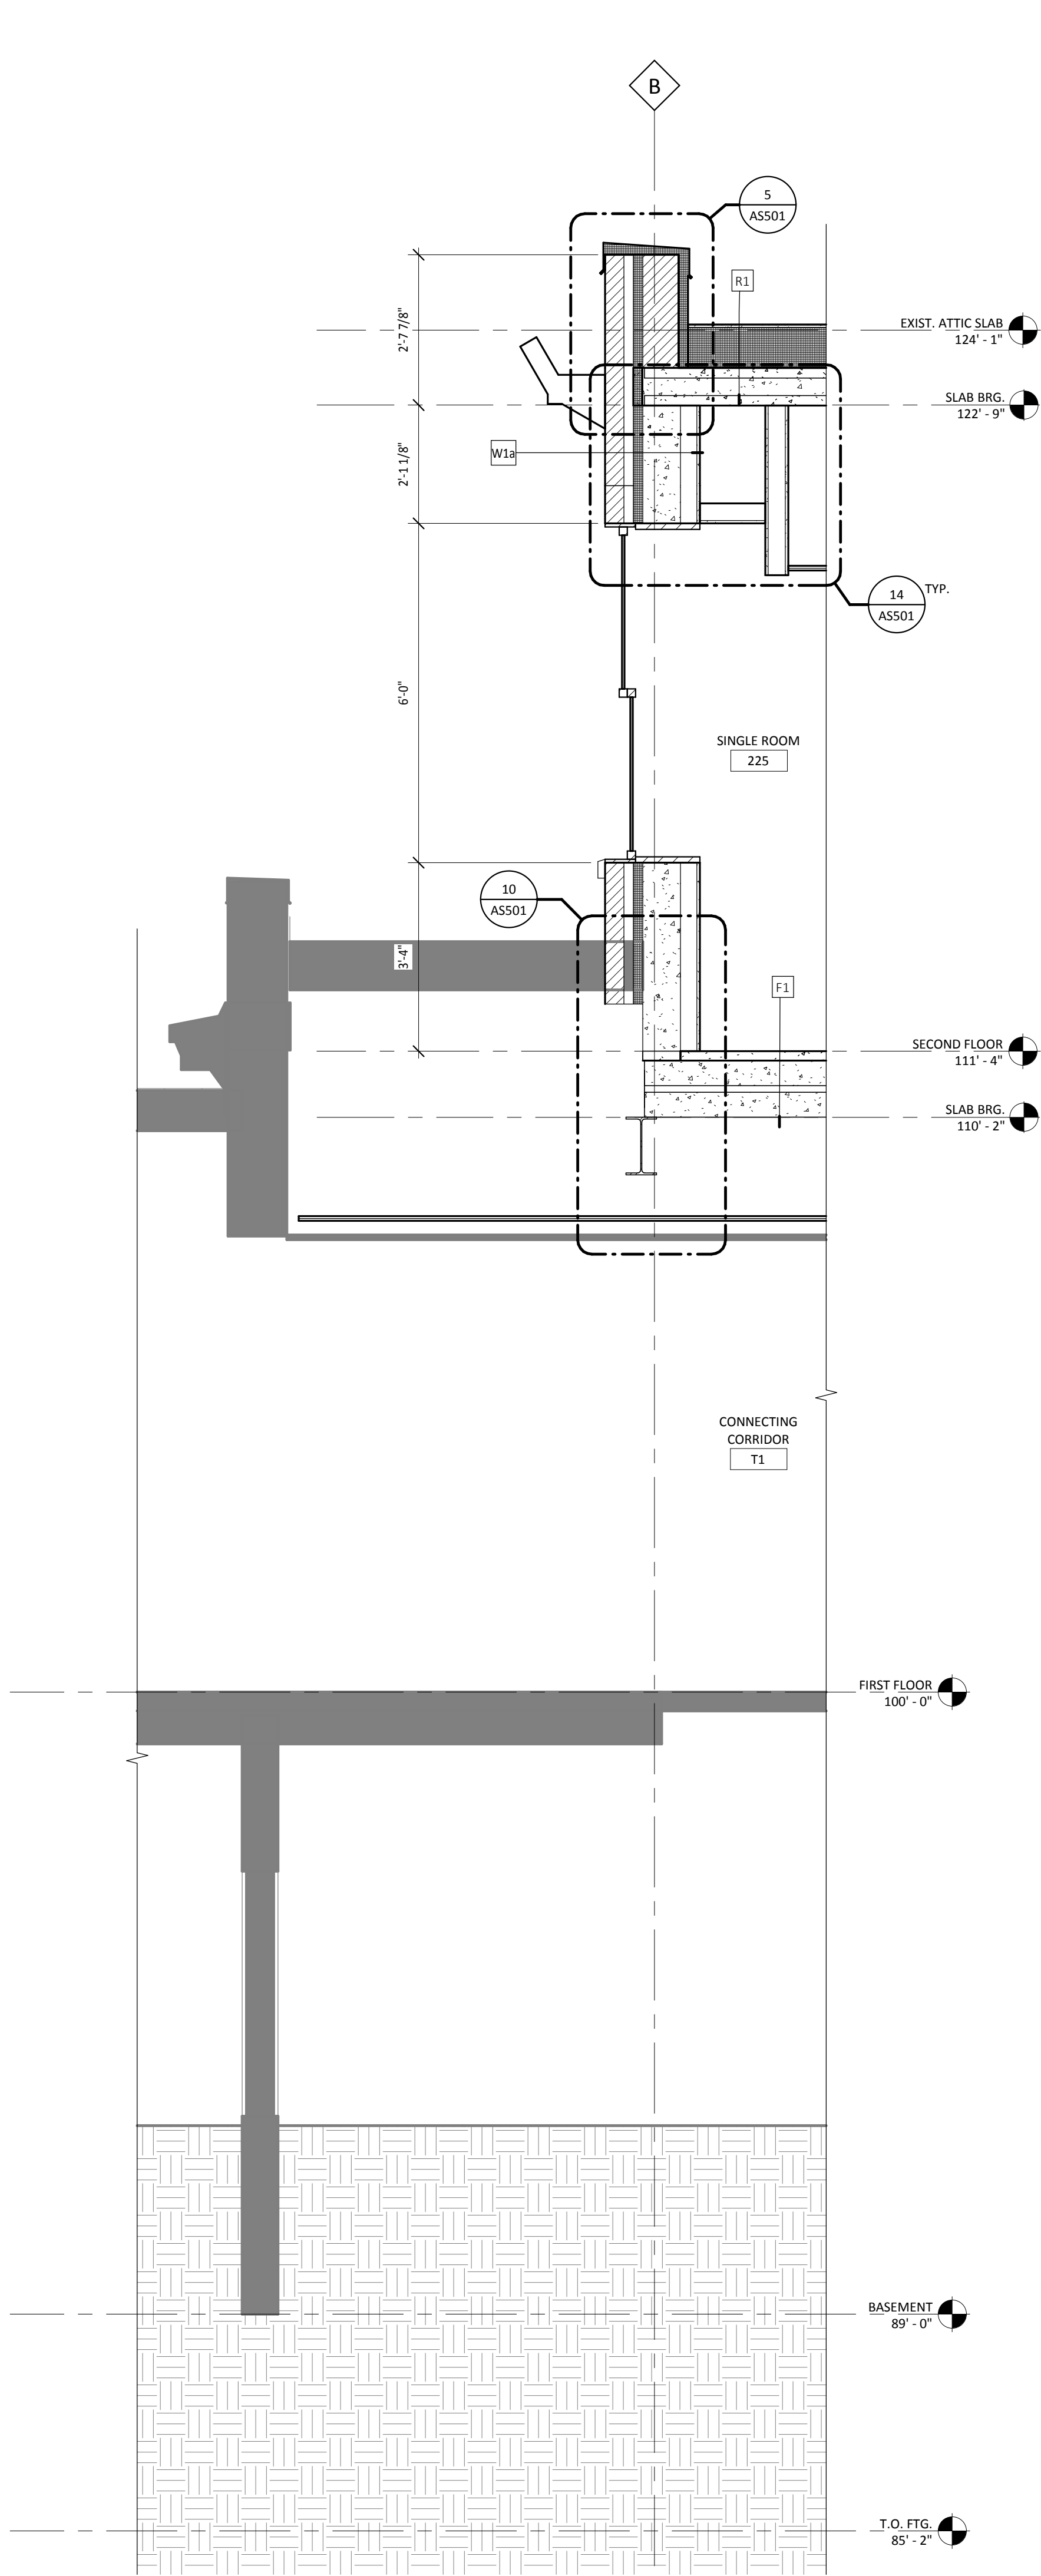

2 Callout of SECTION AT WALKWAY
1/2" = 1'-0"

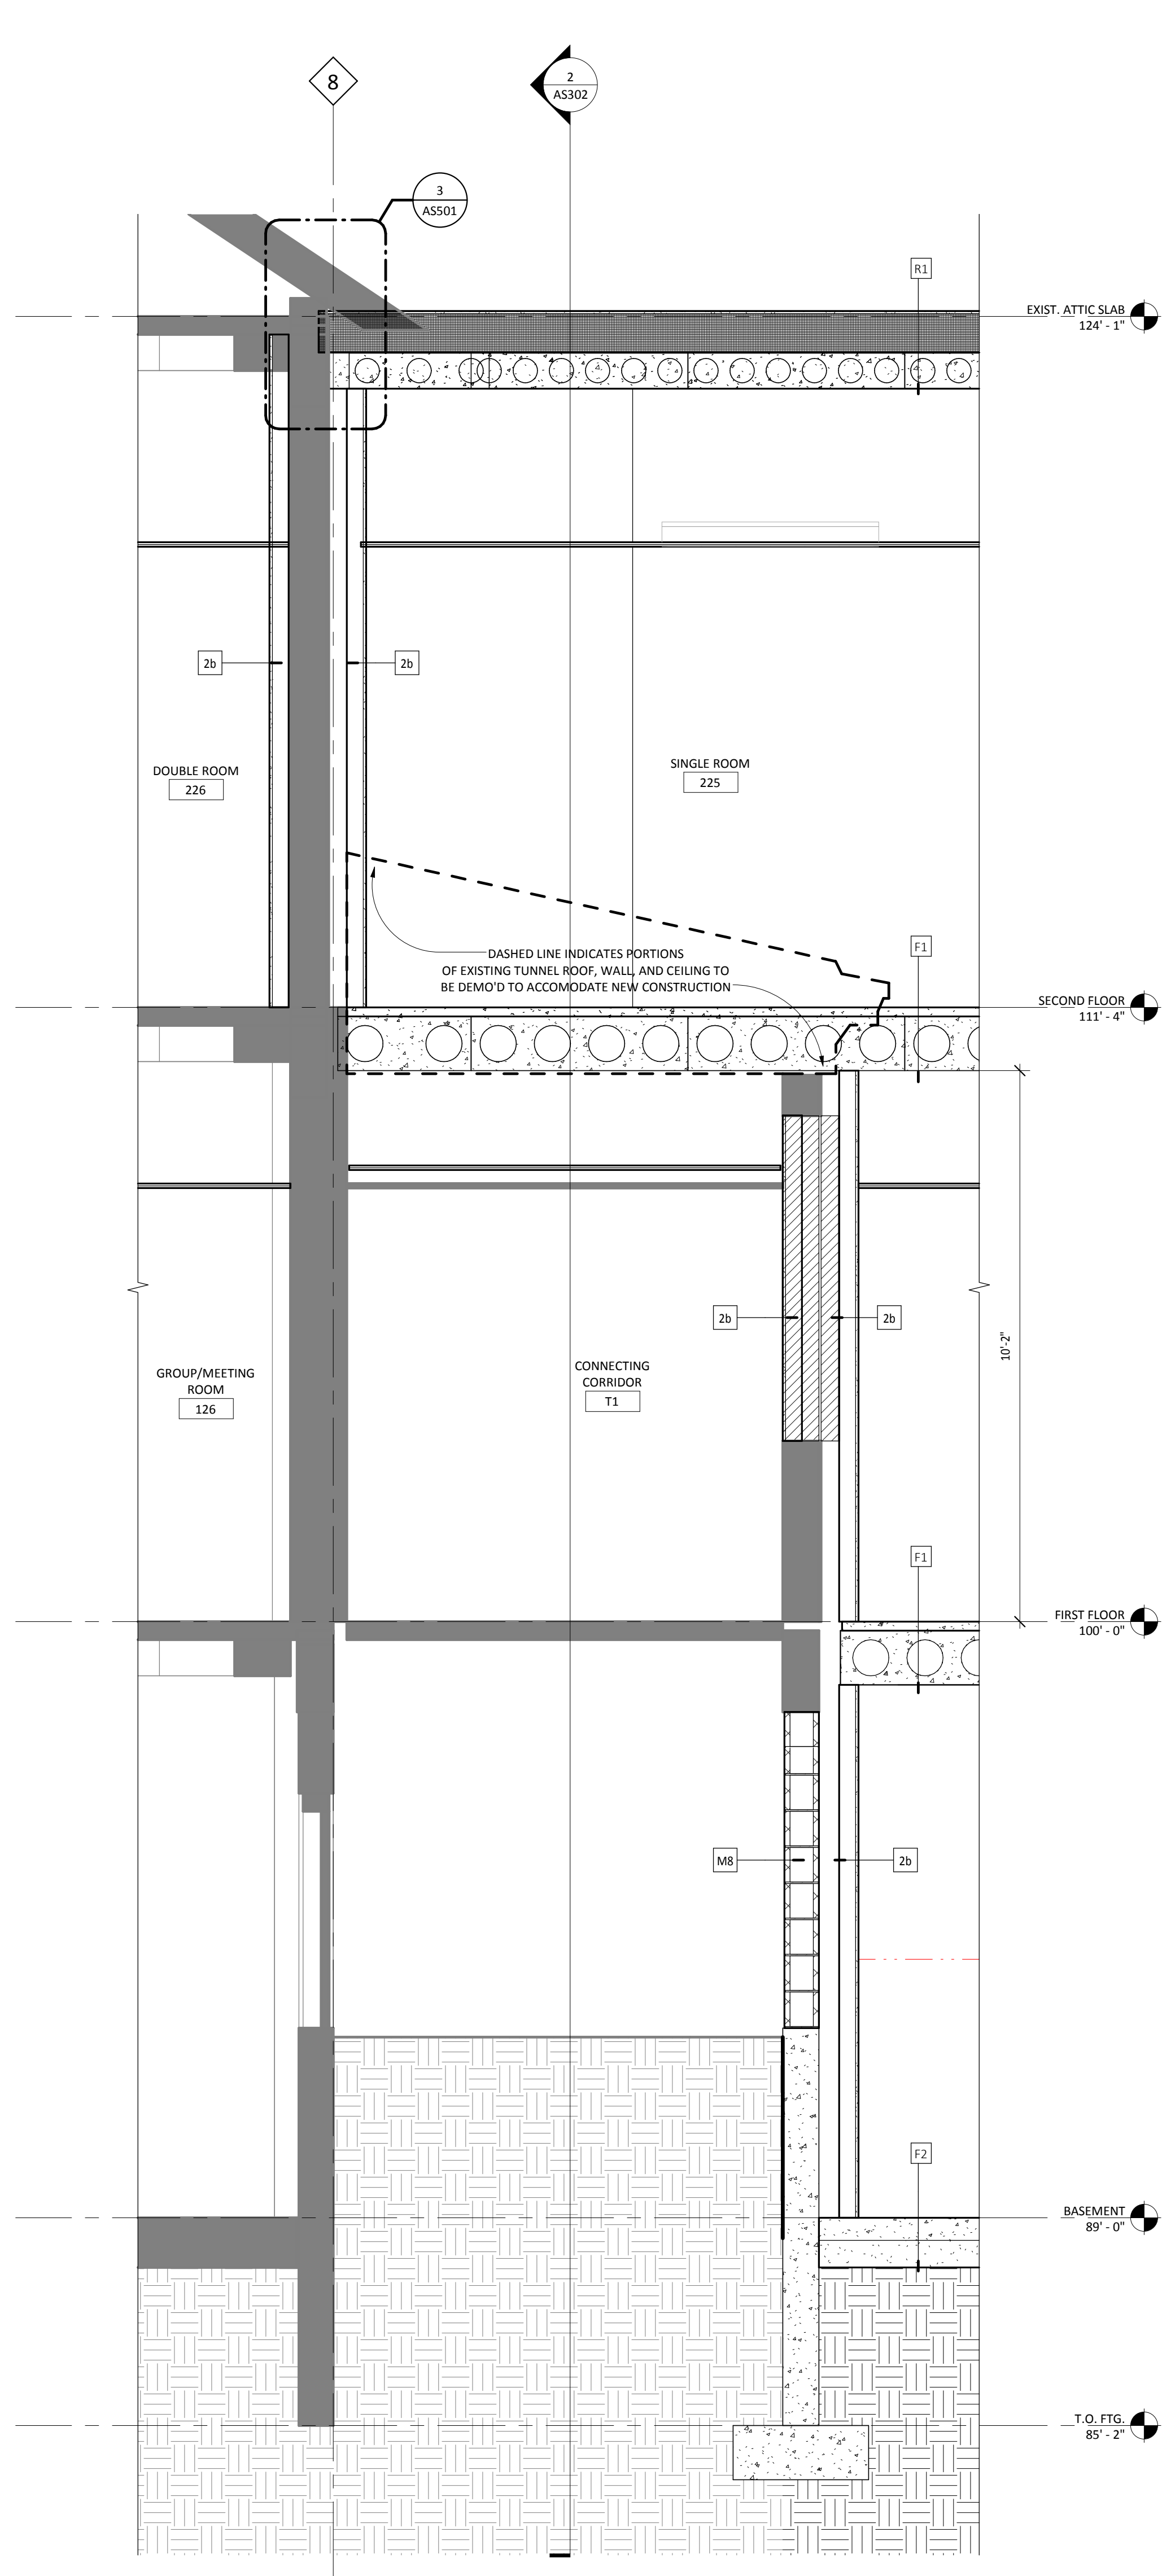

1 WALL SECTION AT TUNNEL
1/2" = 1'-0"



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CHECKED BY: [Signature]
DATE: 12-20-2013
MIN. 0819
REG. NO.

DRAWING TITLE
WALL SECTIONS

PROJECT TITLE
RECONFIGURE/EXPAND
BUILDINGS 28 & 9 FOR
RESIDENTIAL REHABILITATION
TREATMENT PROGRAM

BUILDING No. 28
CHECKED BY: DJM
DRAWN BY: ADB
LOCATION: ST. CLOUD VA MEDICAL CENTER
ST. CLOUD, MN 56303

DATE: 12.20.13
PROJECT NO.: 656-12-339


DWG. FILE: AS402

100% CD SET


FOR CONSTRUCTION




three inches = one foot
one and one half inches = one foot
one inch = one foot
three quarters inch = one foot
one half inch = one foot
three eighths inch = one foot
one quarter inch = one foot
one eighth inch = one foot

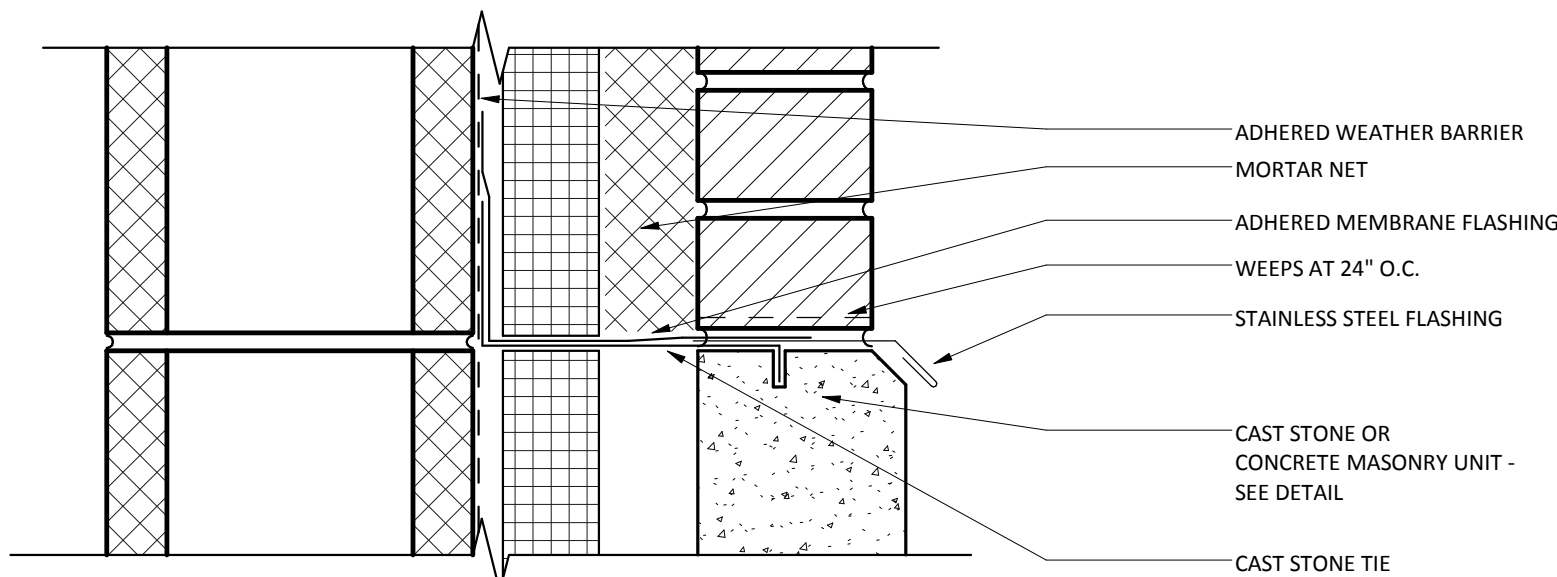


12 BASE FLASHING AT MASONRY
3\"/>

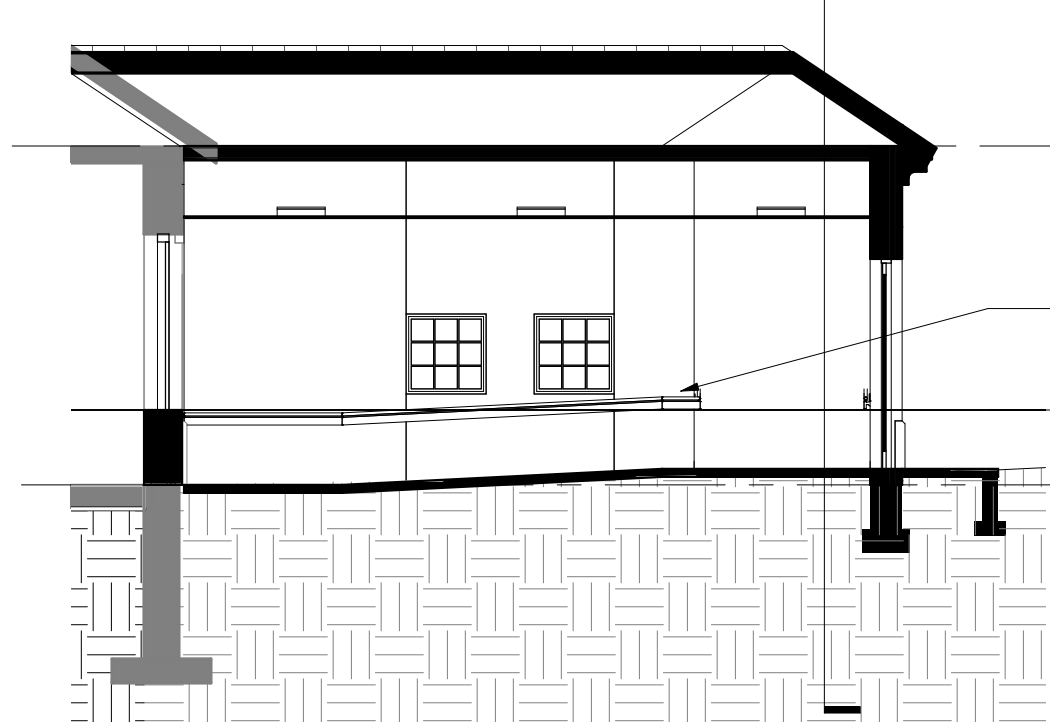


9 LINK SECTION 6
1/8\"/>

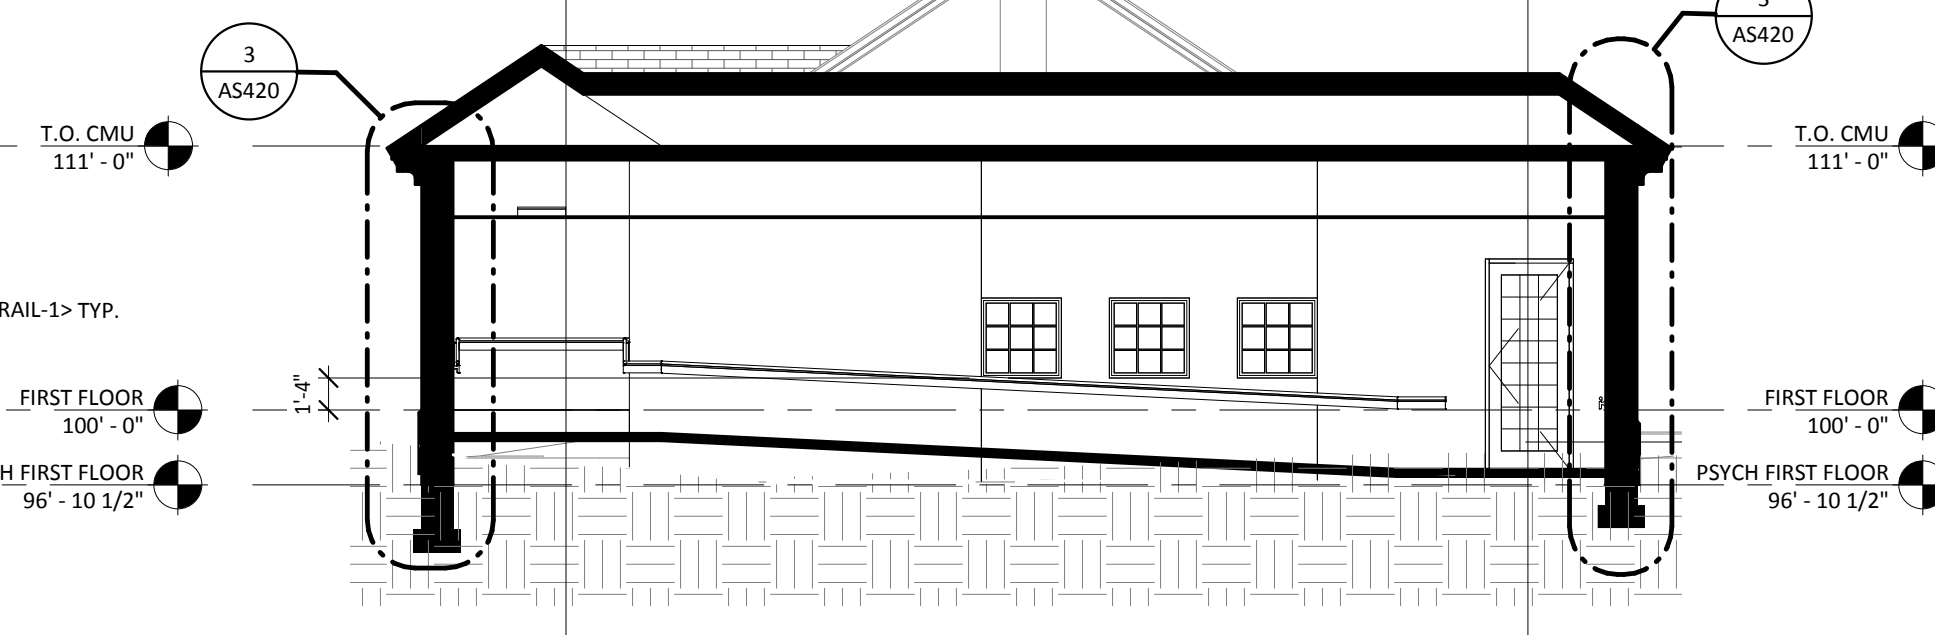


7 LINK SECTION 4
1/8\"/>

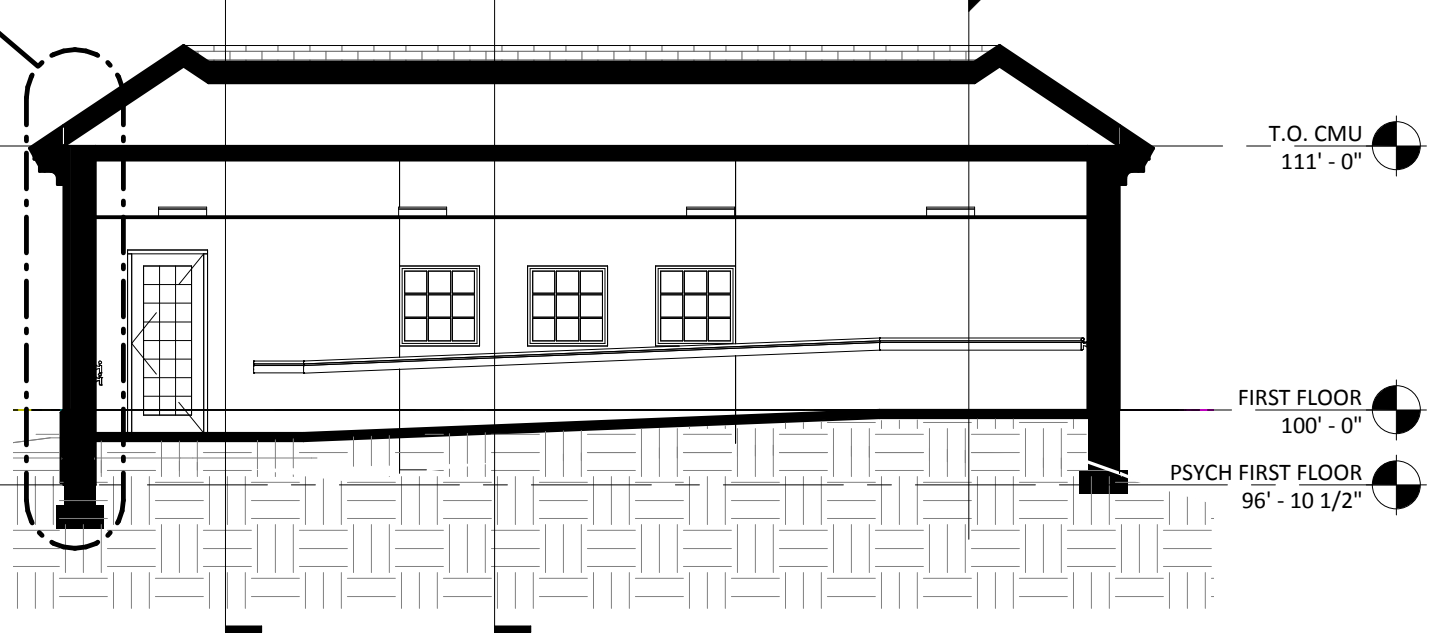


4 LINK SECTION 3
1/8\"/>

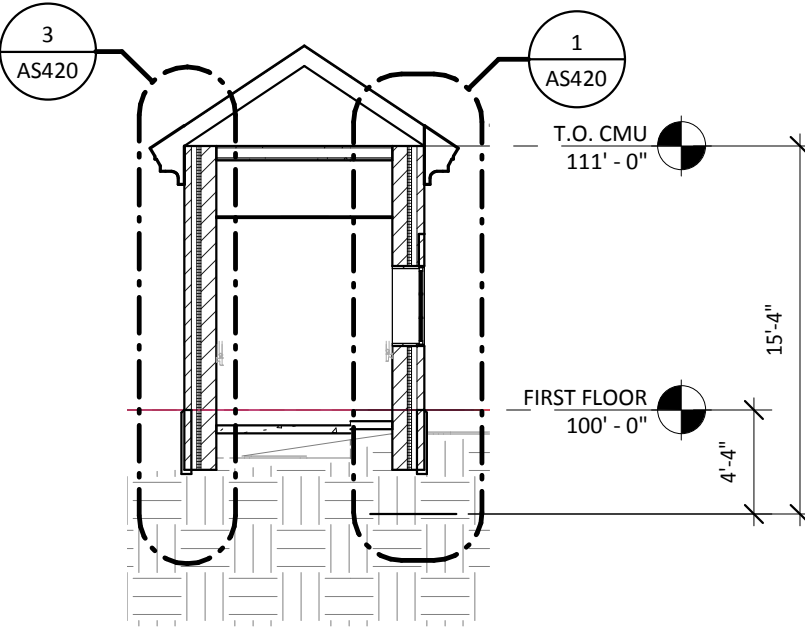


2 LINK CROSS SECTION TYP.
1/8\"/>

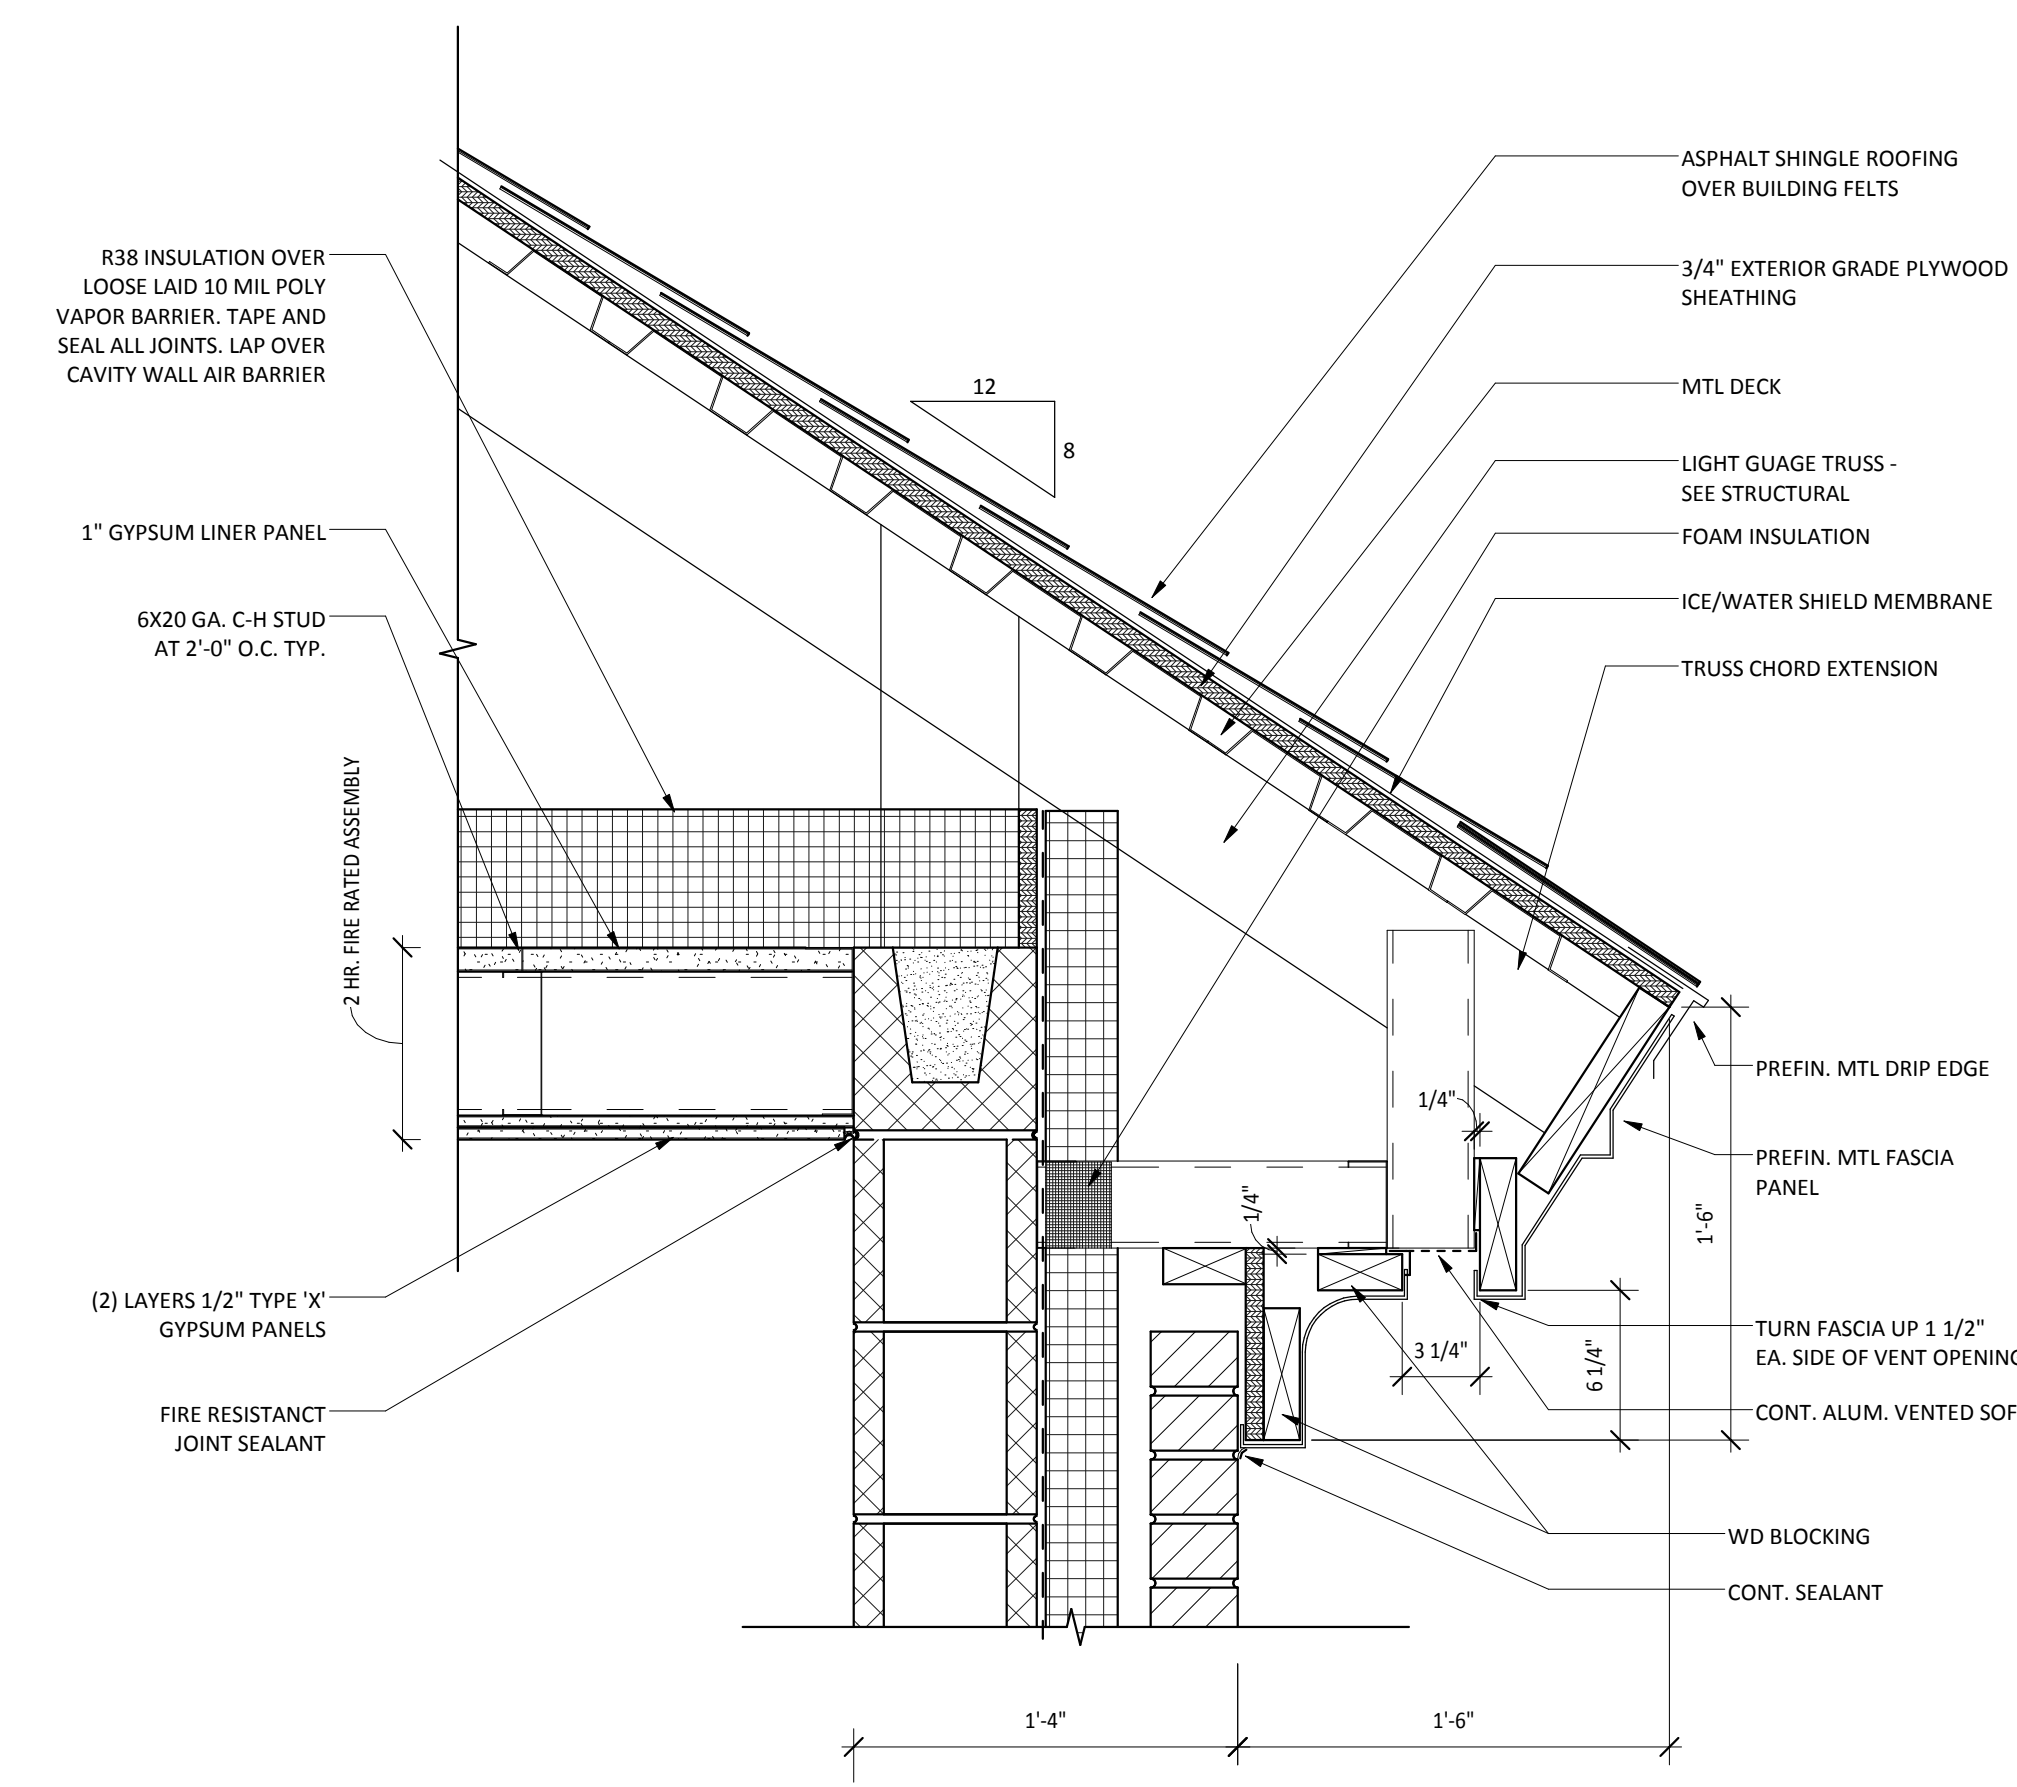


11 ROOF EDGE AT CONNECTION LINK
1 1/2\"/>

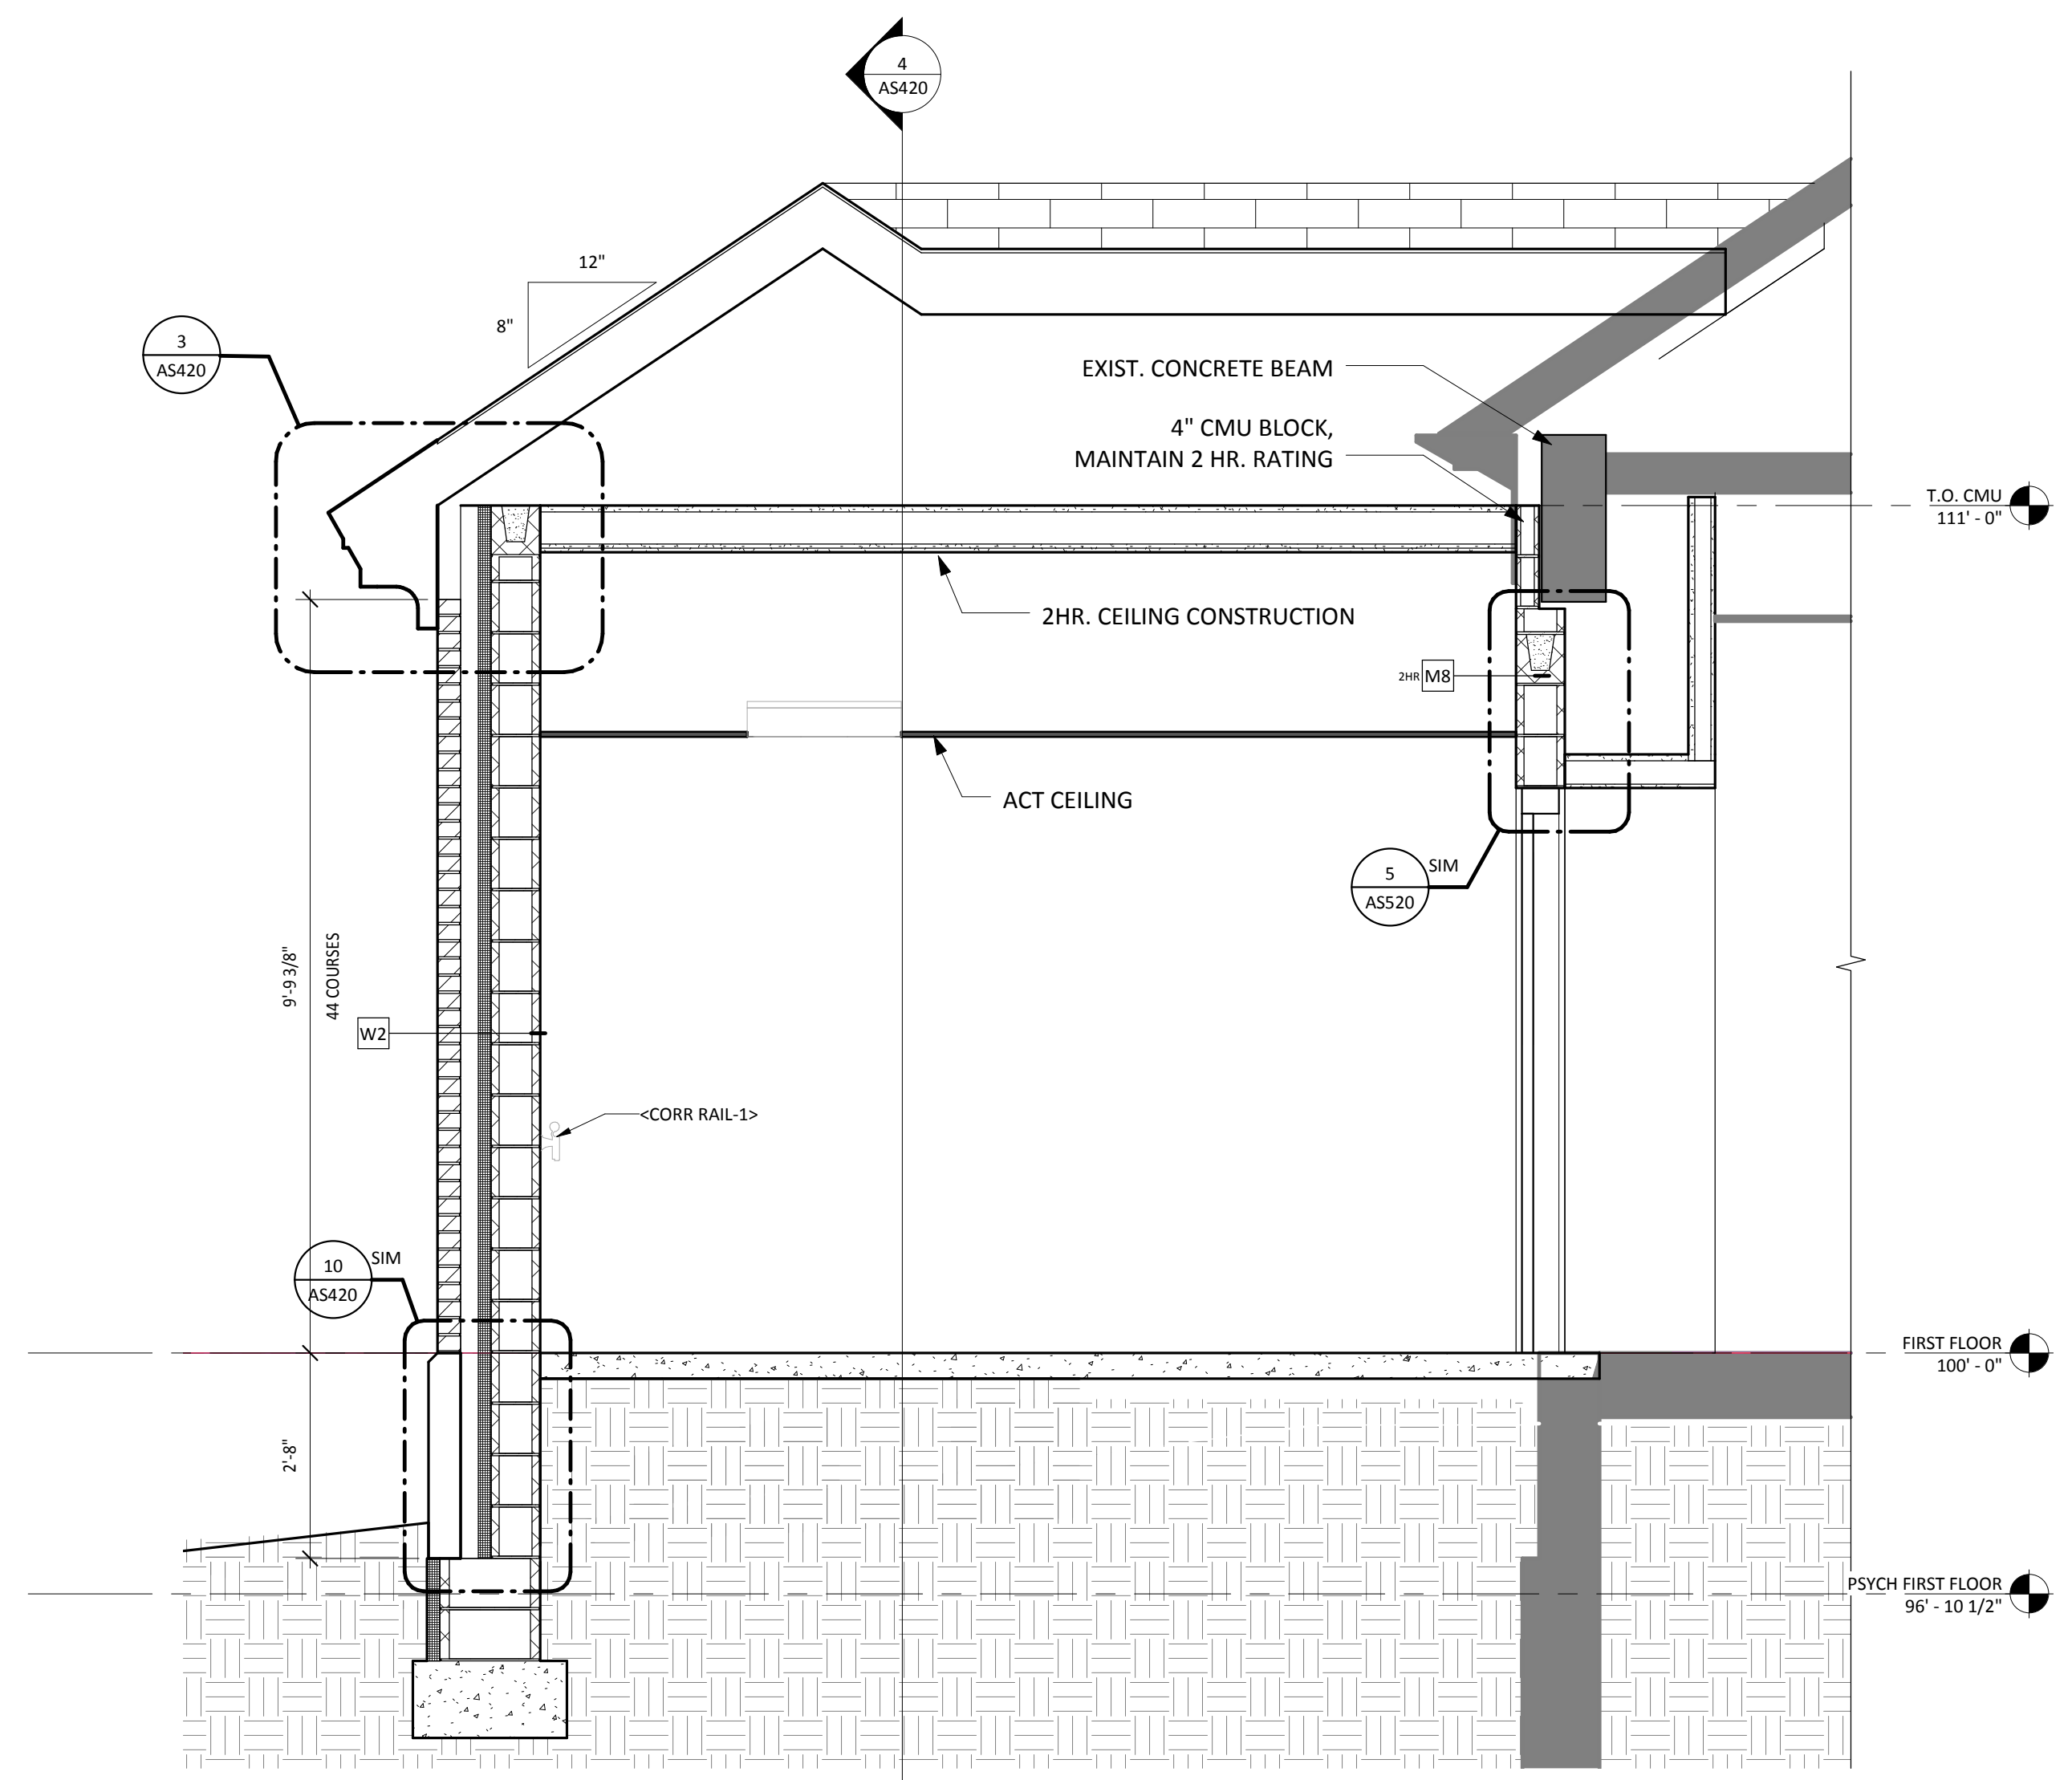


6 WALL SECTION AT EXIST.
1/2\"/>

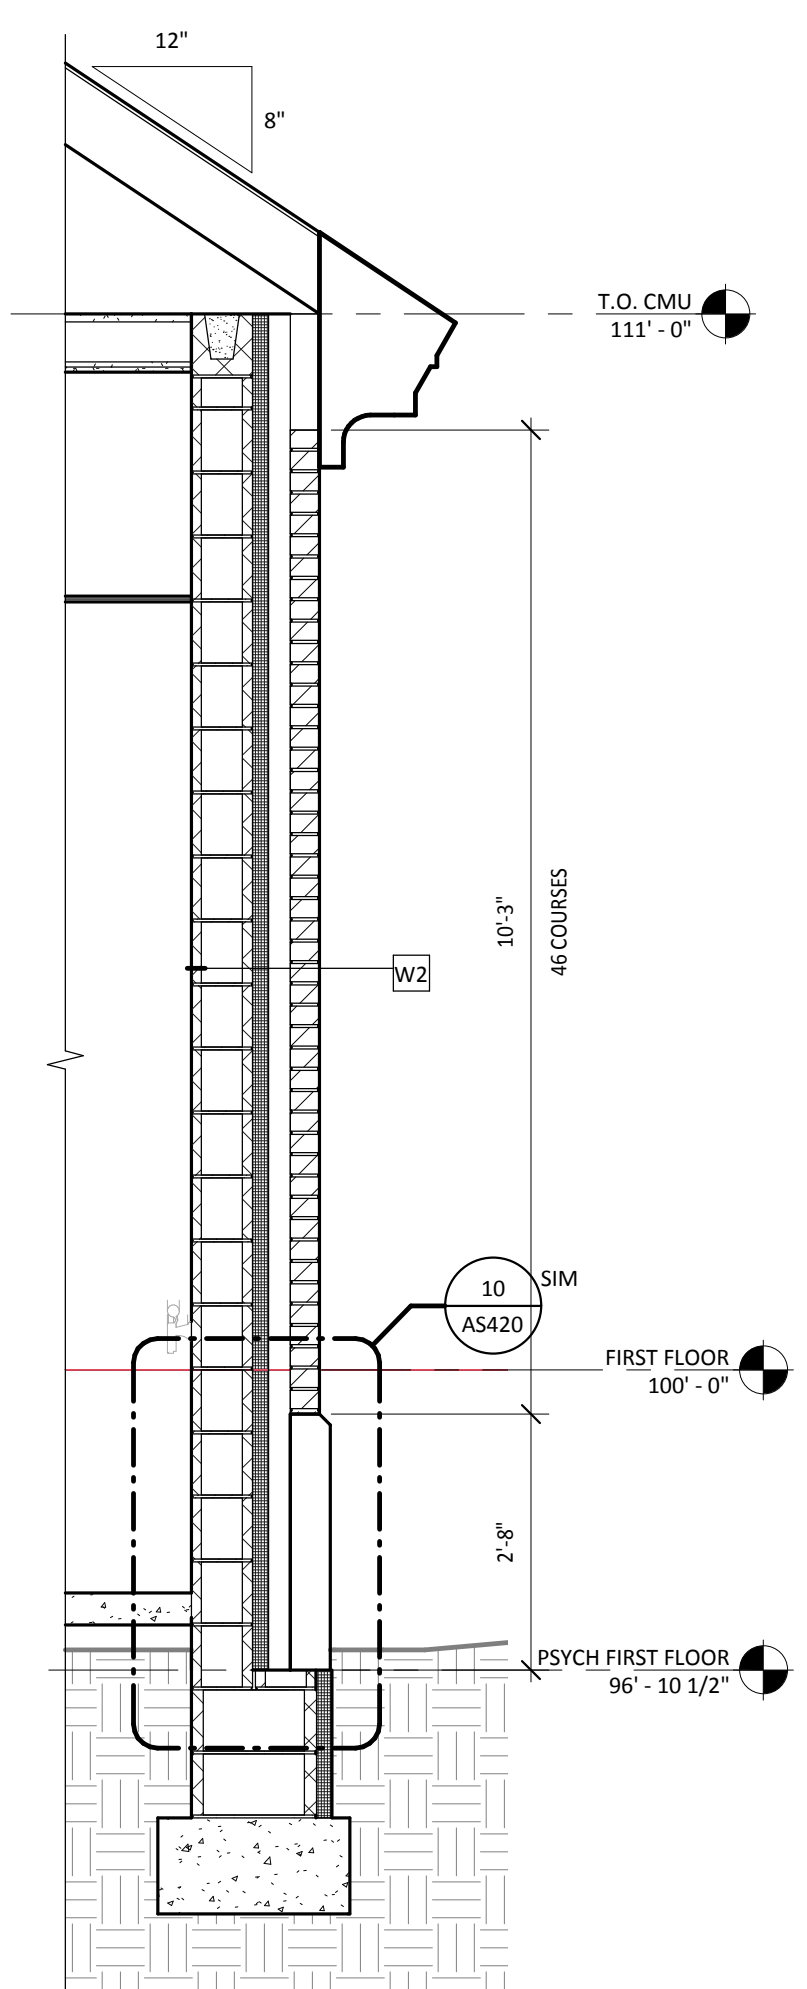


3 WALL SECTION - TYPICAL
1/2\"/>

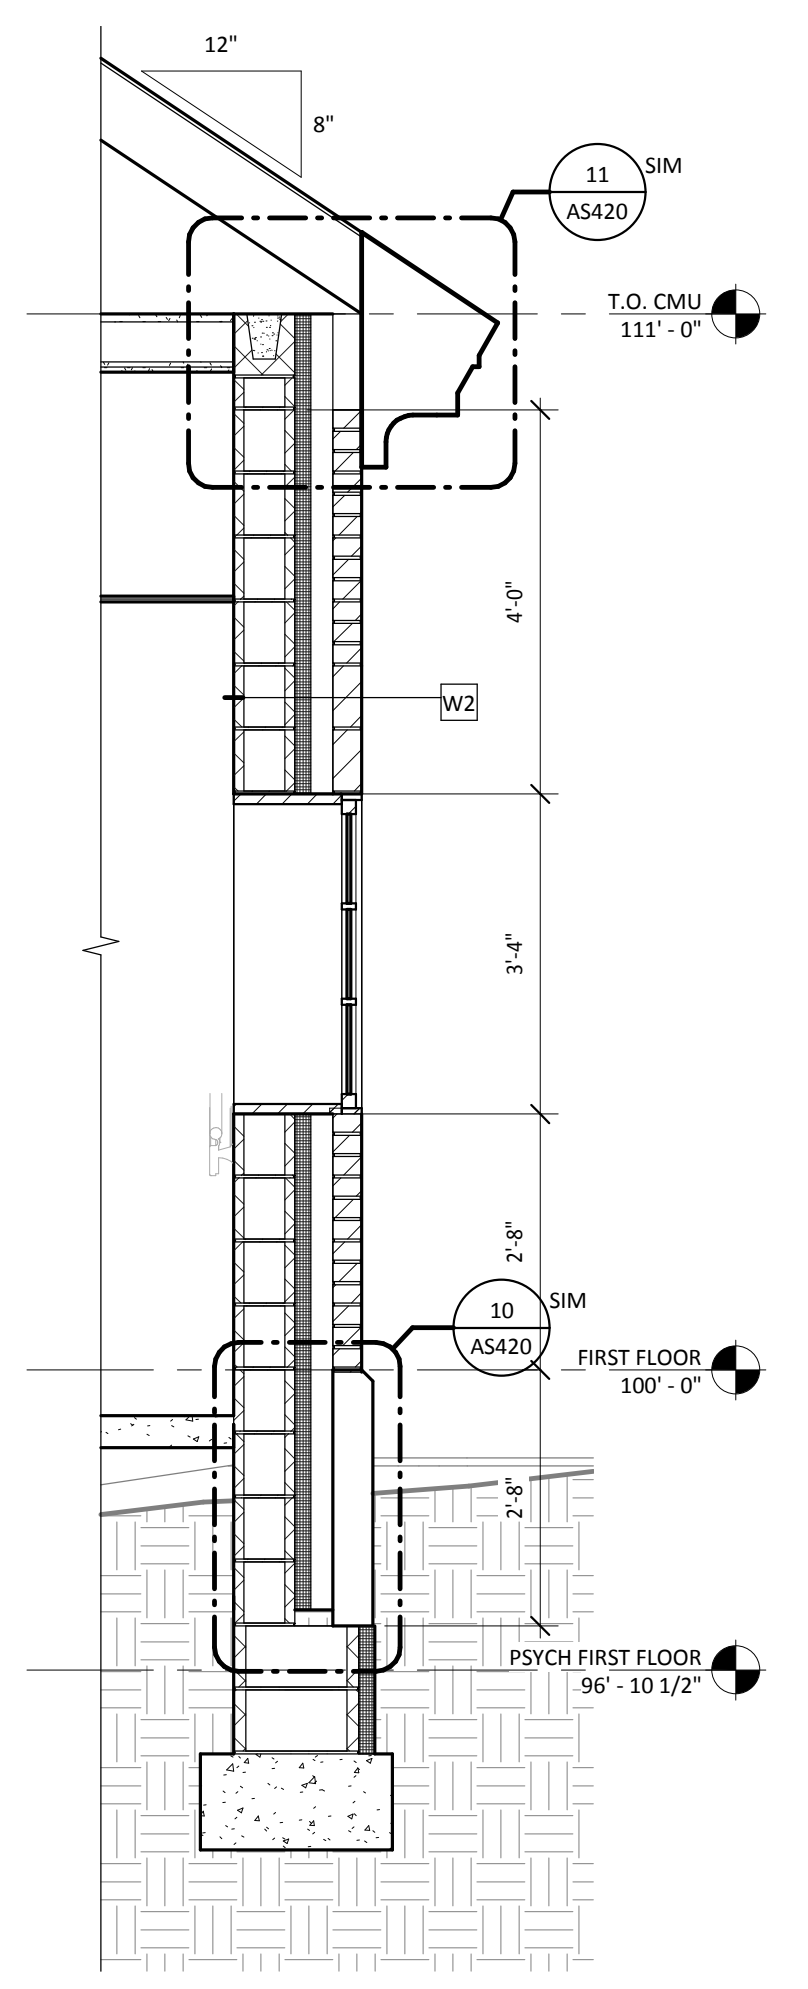


1 WALL SECTION AT WINDOW
1/2\"/>

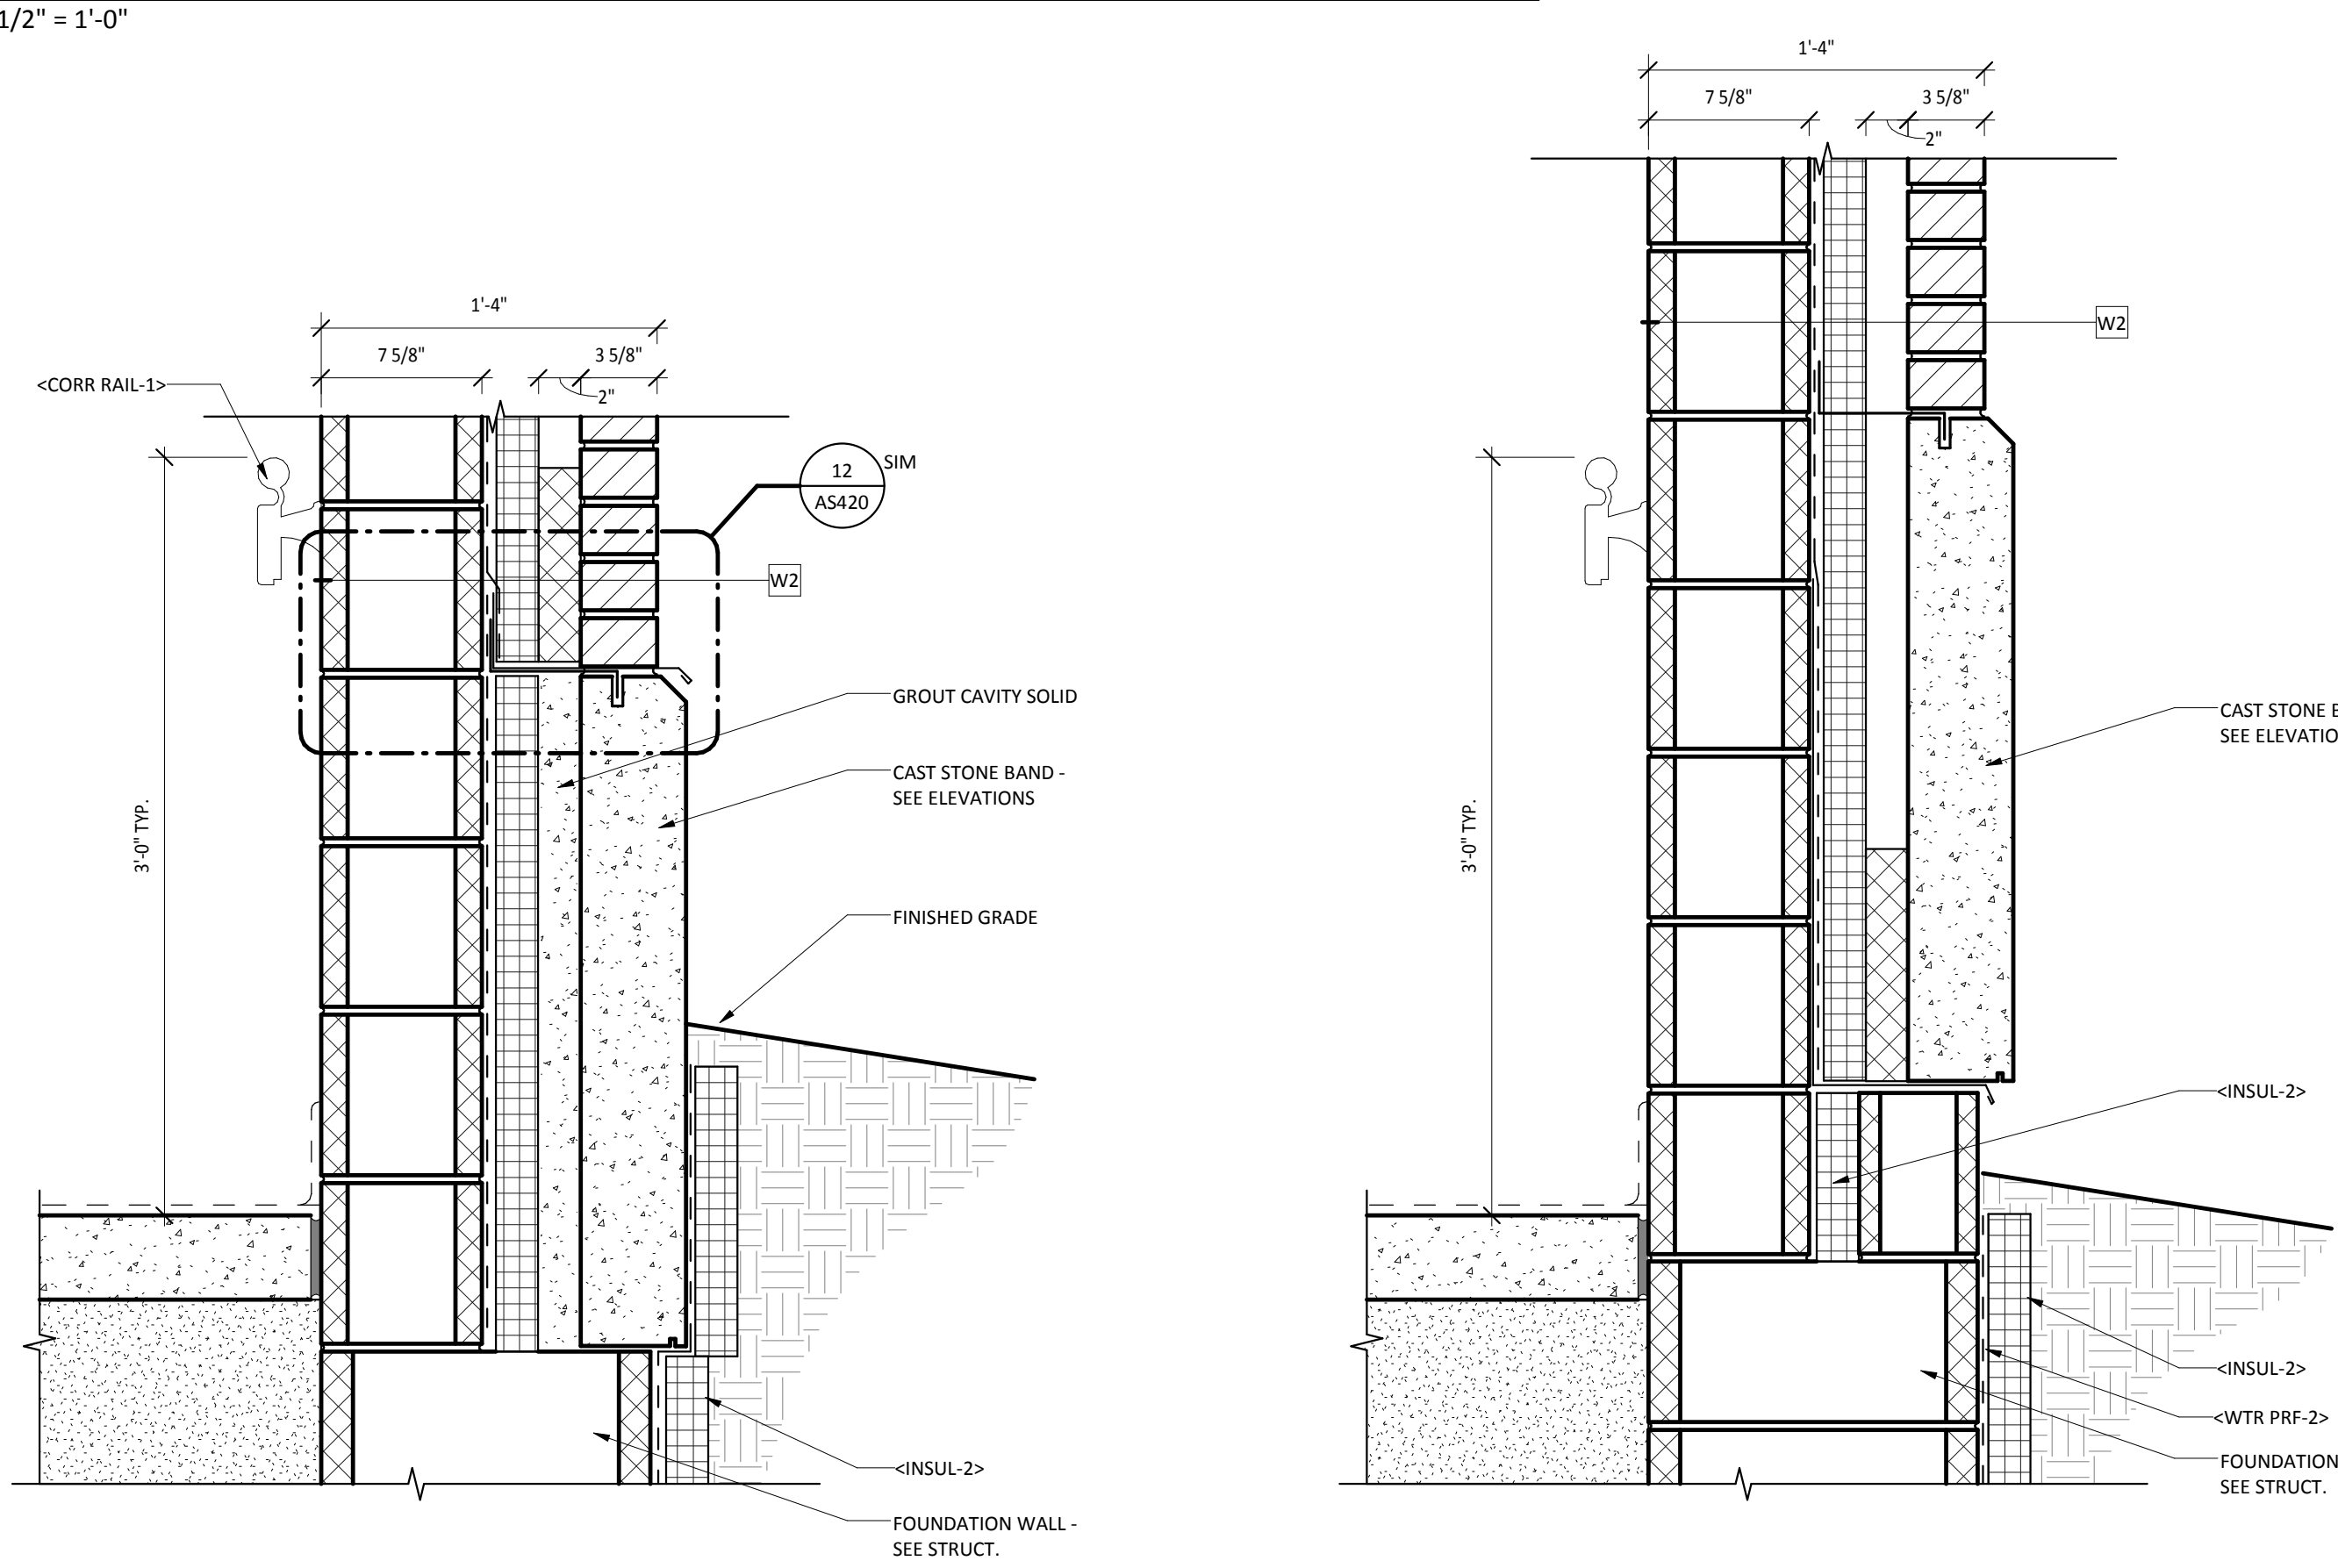

10 BASE AT HIGH GRADE
1 1/2\"/>

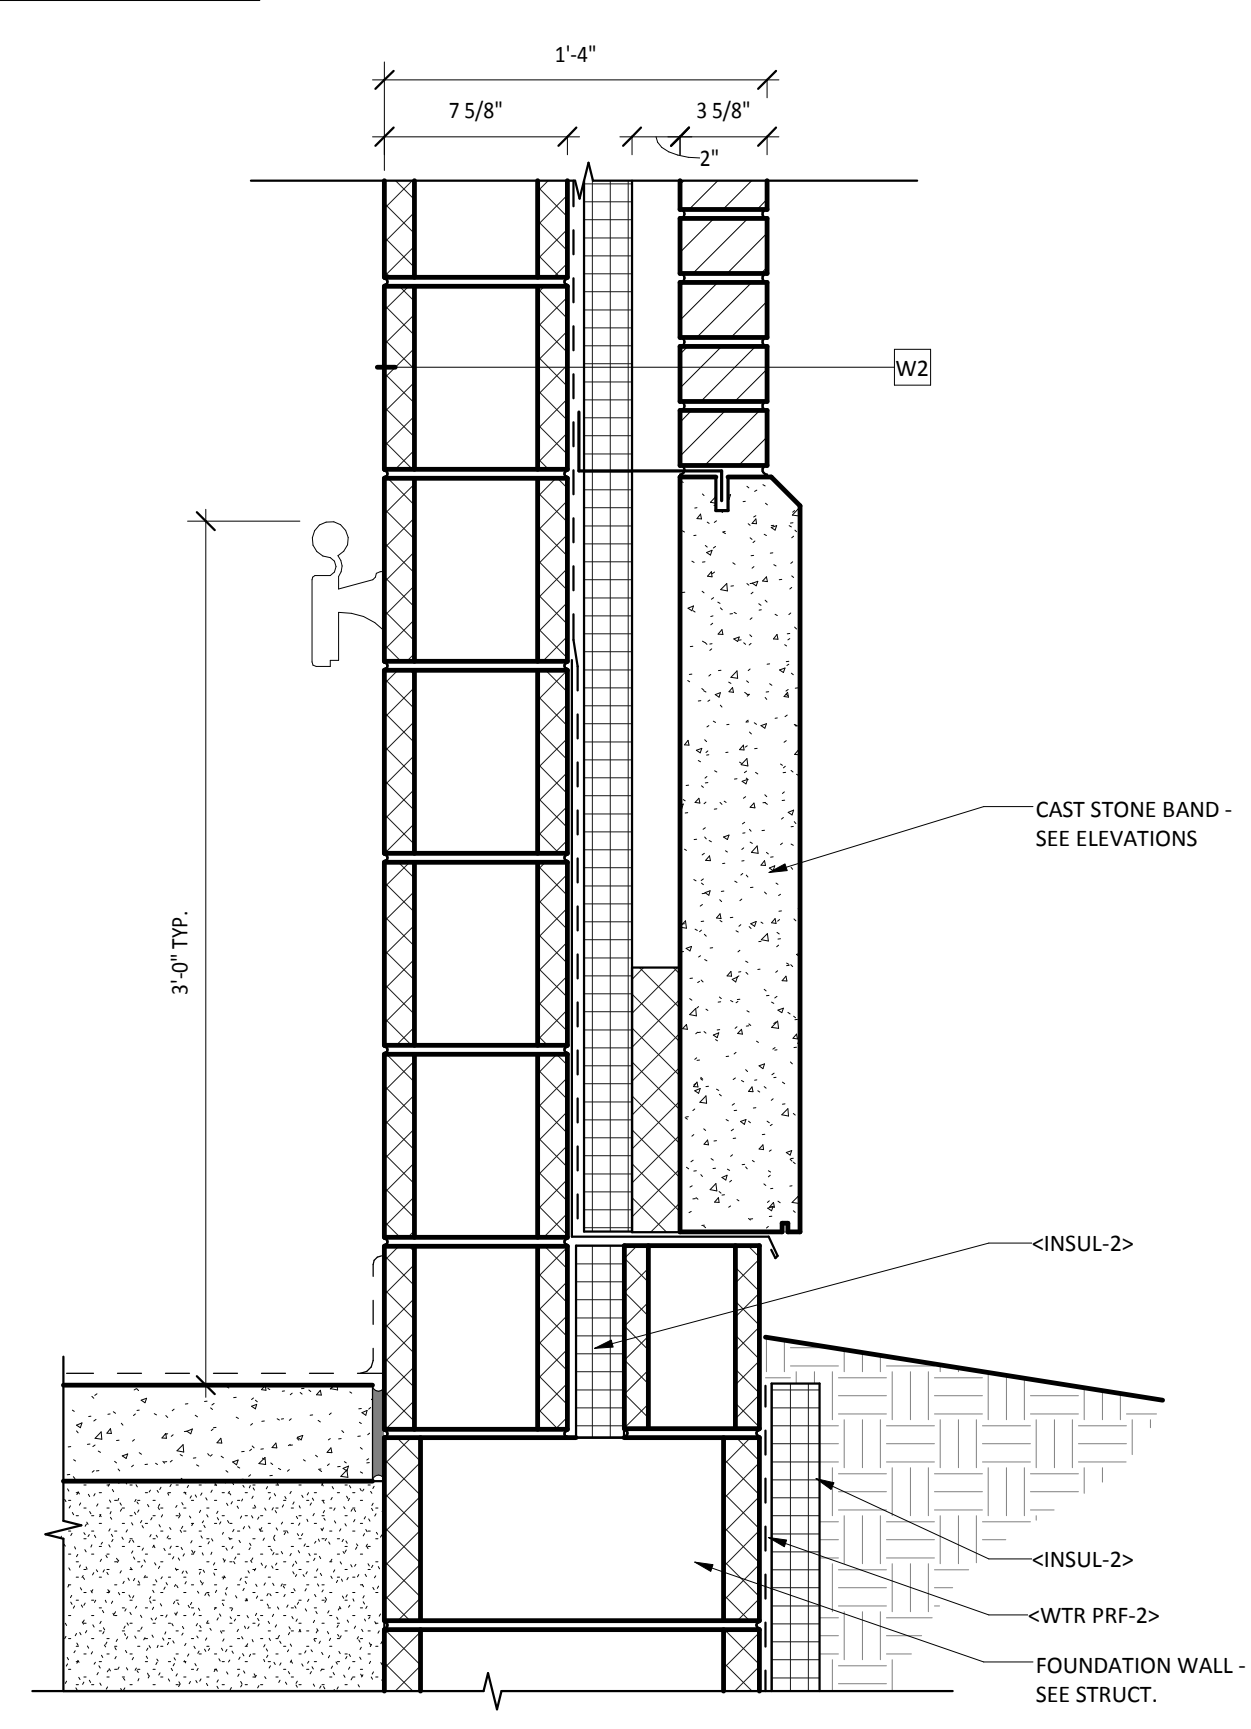

8 BASE AT CONNECTION - SLAB ON GRADE
1 1/2\"/>

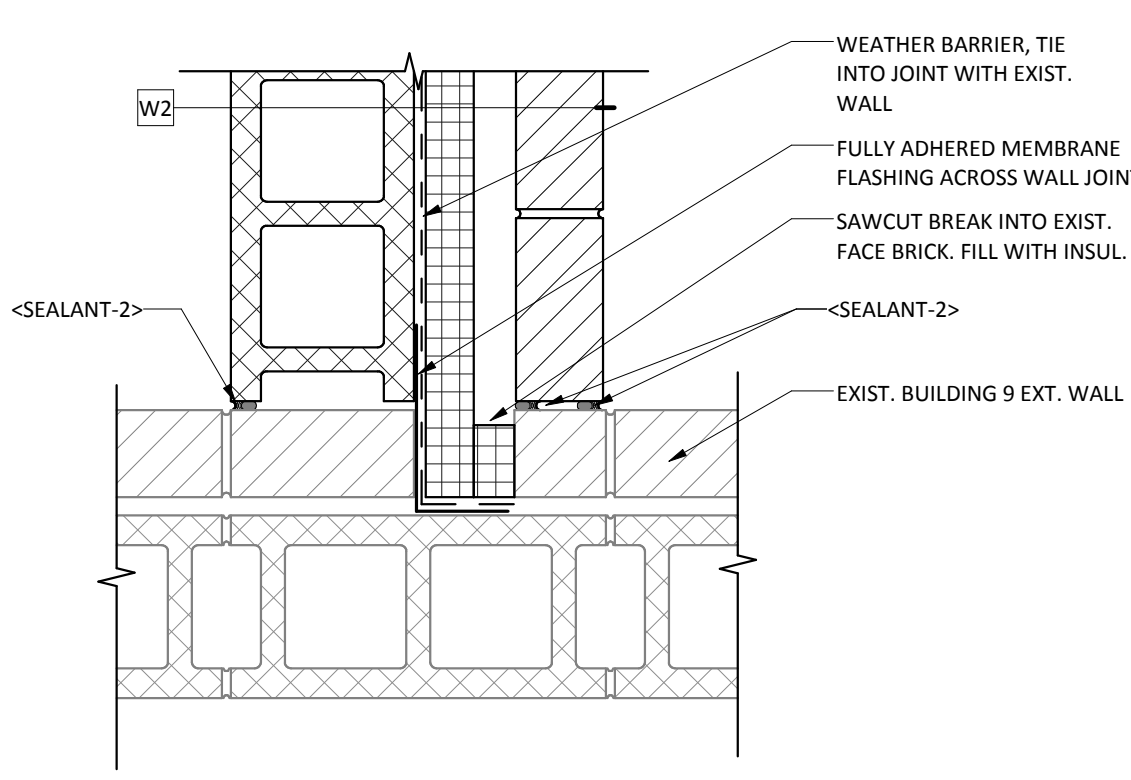

5 LINK/EXISTING BUILDING WALL JOINT
1 1/2\"/>

No	REVISION	DATE

VA FORM 08-6231



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THE LAWS OF THE STATE OF MINNESOTA.

DANIEL J. MILLER, AIA
DATE: 12-20-2013
MIN. CSR-18
REG. NO.

DRAWING TITLE
LINK SECTIONS & DETAILS

PROJECT TITLE
RECONFIGURE/EXPAND
BUILDINGS 28 & 9 FOR
RESIDENTIAL REHABILITATION
TREATMENT PROGRAM

BUILDING No.
9
DESIGNED BY
DJM
DRAWN
ADB

LOCATION
ST. CLOUD VA MEDICAL CENTER
ST. CLOUD, MN 56303

DATE
12.20.13

PROJECT NO.
656-12-339

DWG FILE
AS420



100% CD SET

FOR CONSTRUCTION

three inches = one foot
one and one half inches = one foot
one inch = one foot
three quarters inch = one foot
one half inch = one foot
three eighths inch = one foot
one quarter inch = one foot
one eighth inch = one foot

A

B

C

D

E

F

A


B

C


D

E


F

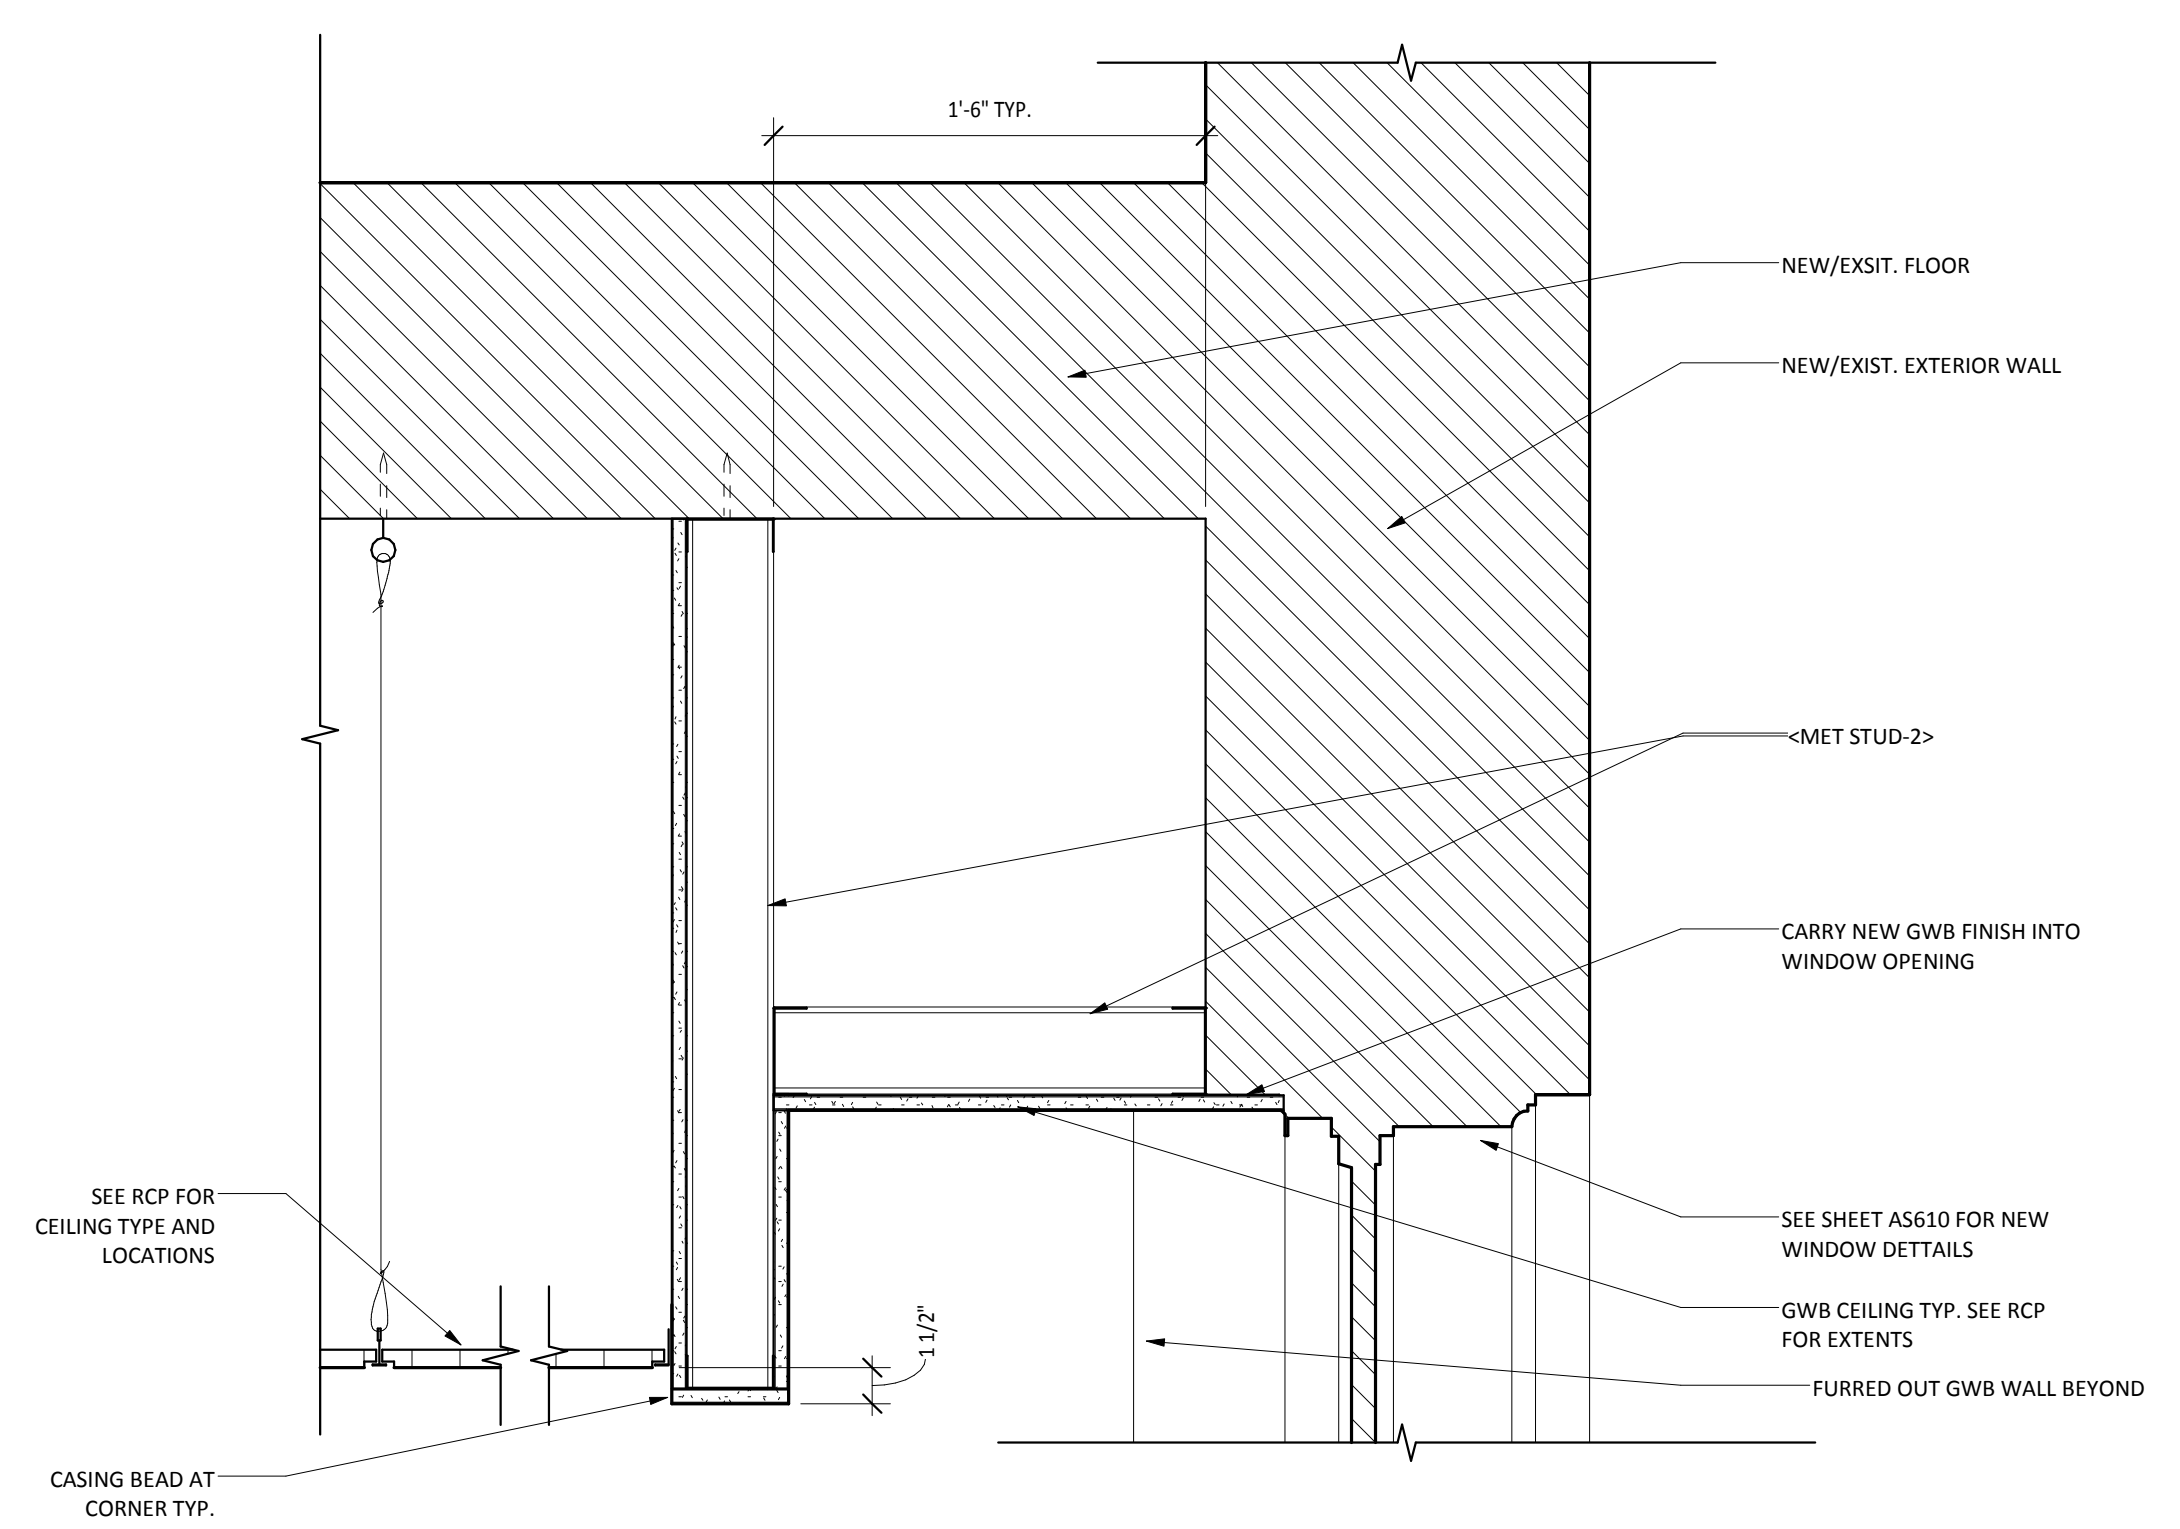


14 BOXED OUT CEILING AT WINDOW TYP.
1 1/2" = 1'-0"

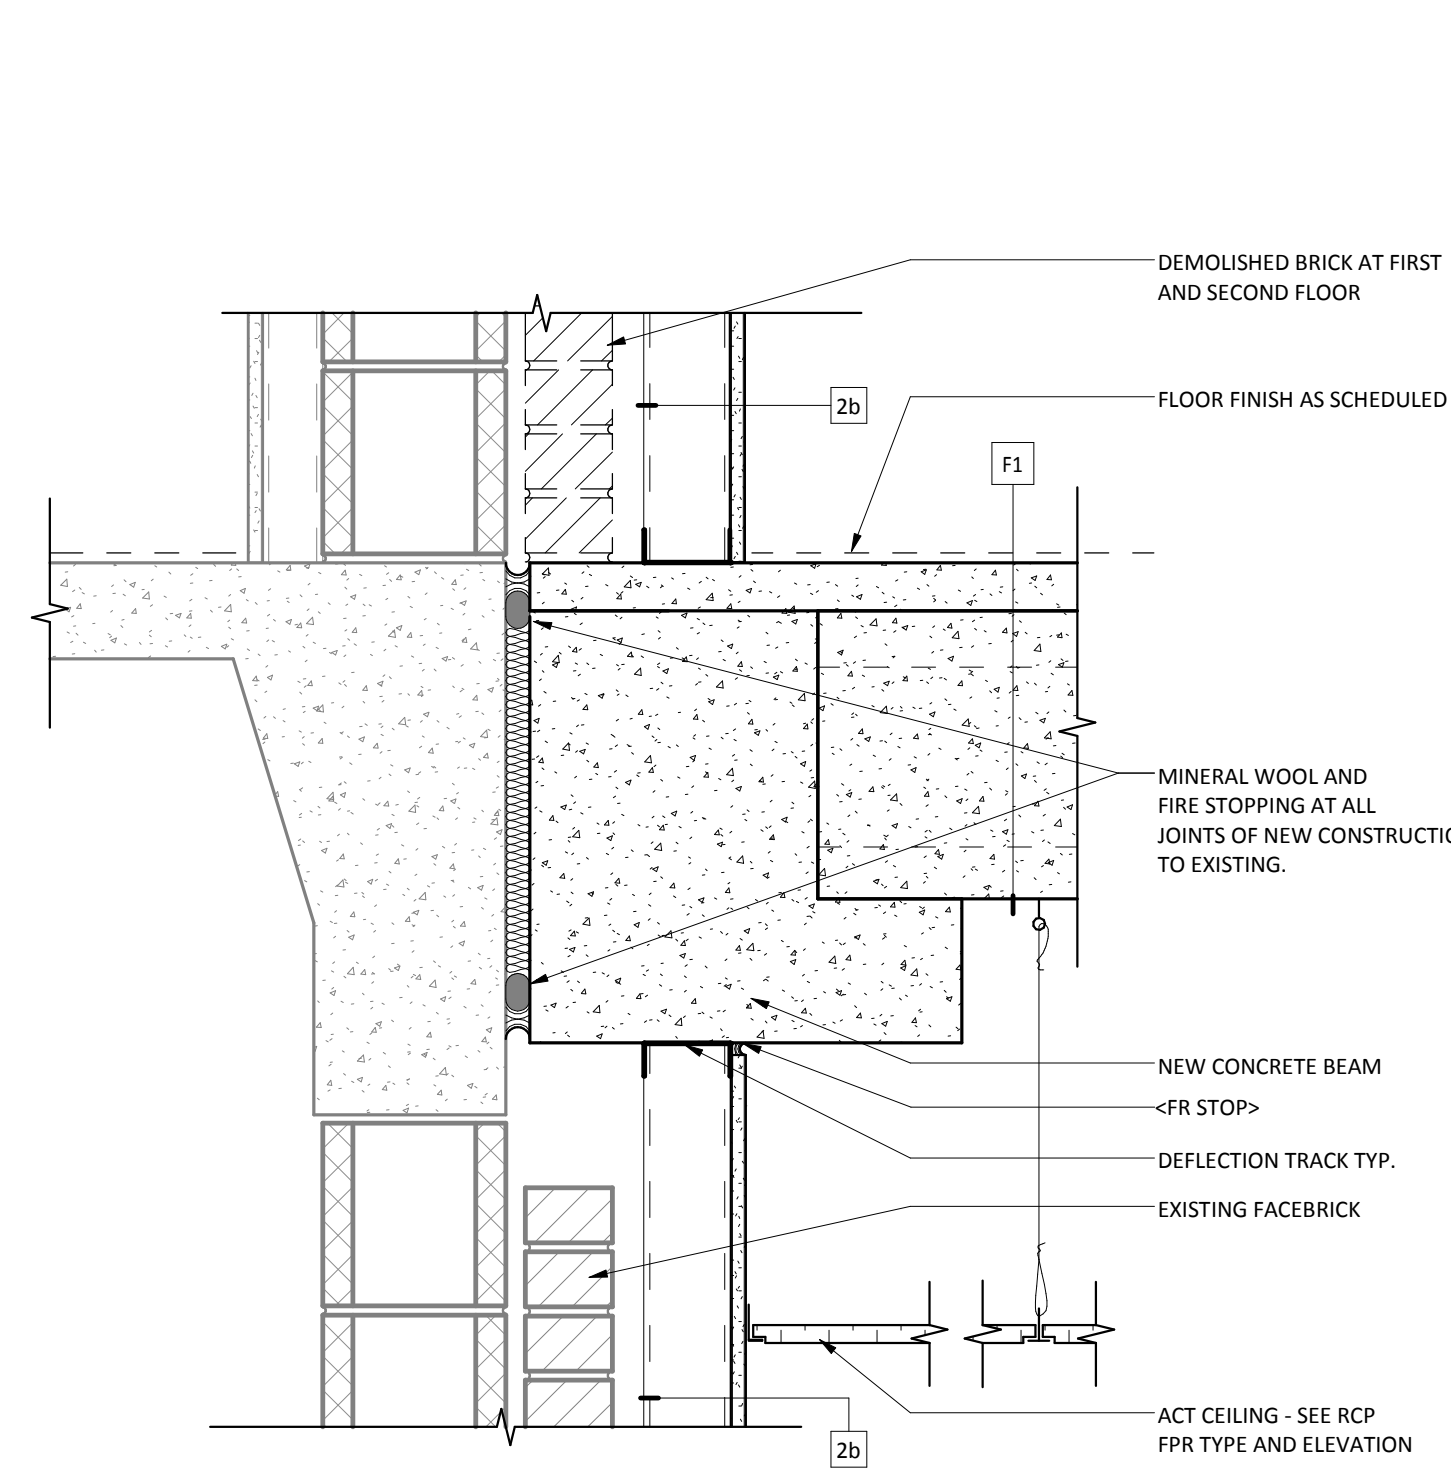


9 EXISTING/NEW FLOOR JOINT AT INFILL
1 1/2" = 1'-0"

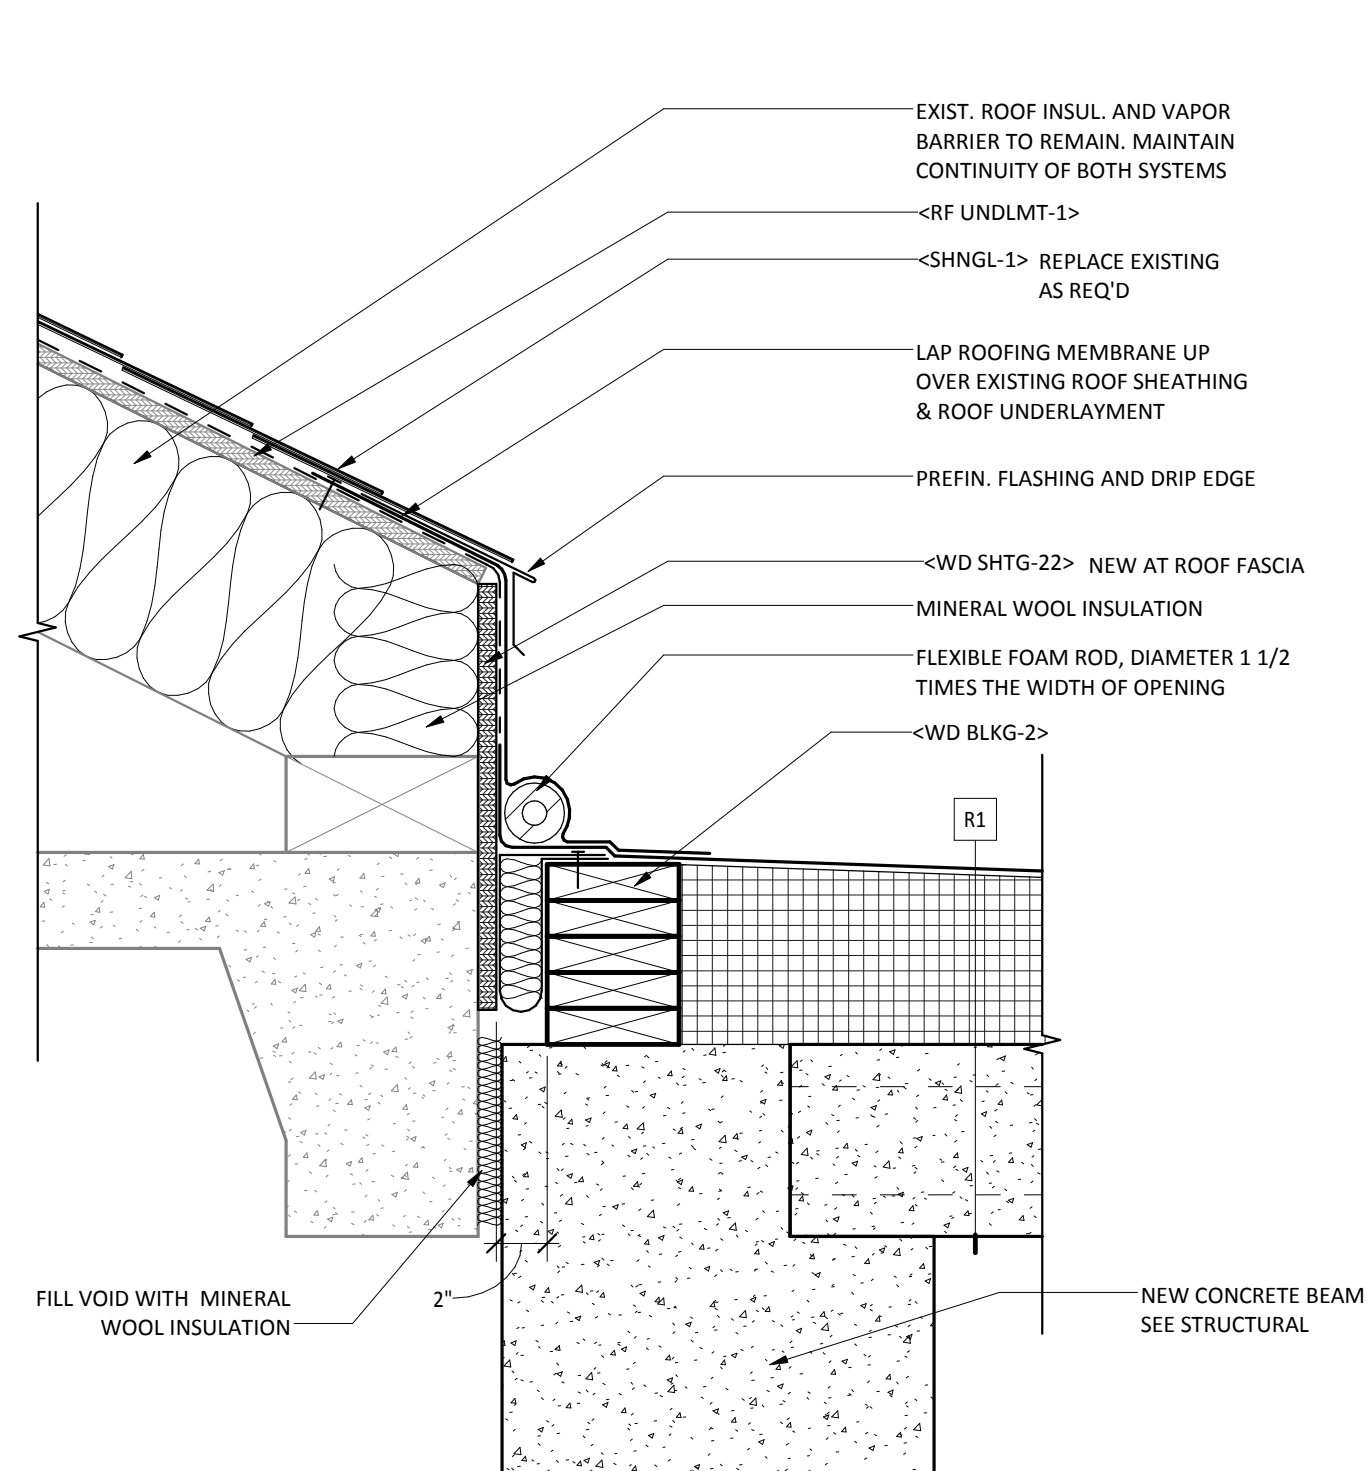


6 EXISTING ROOF/FLAT ROOF JOINT
1 1/2" = 1'-0"

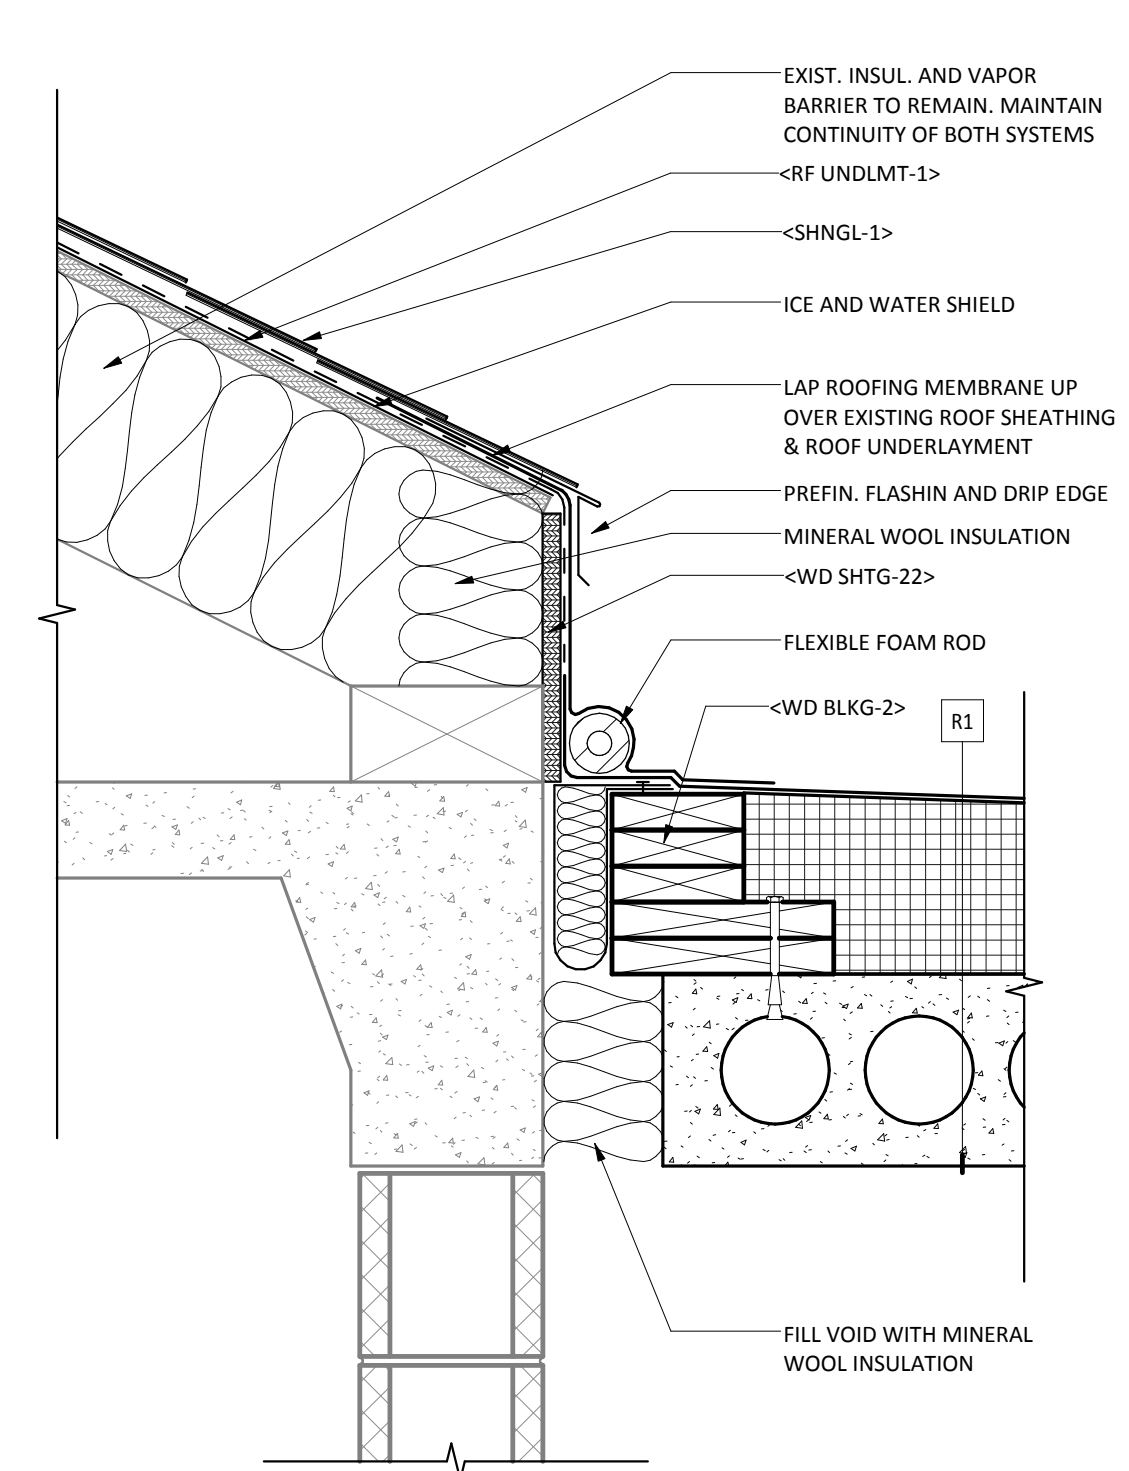


3 EXISTING ROOF/NEW ROOF E&W WALLS
1 1/2" = 1'-0"

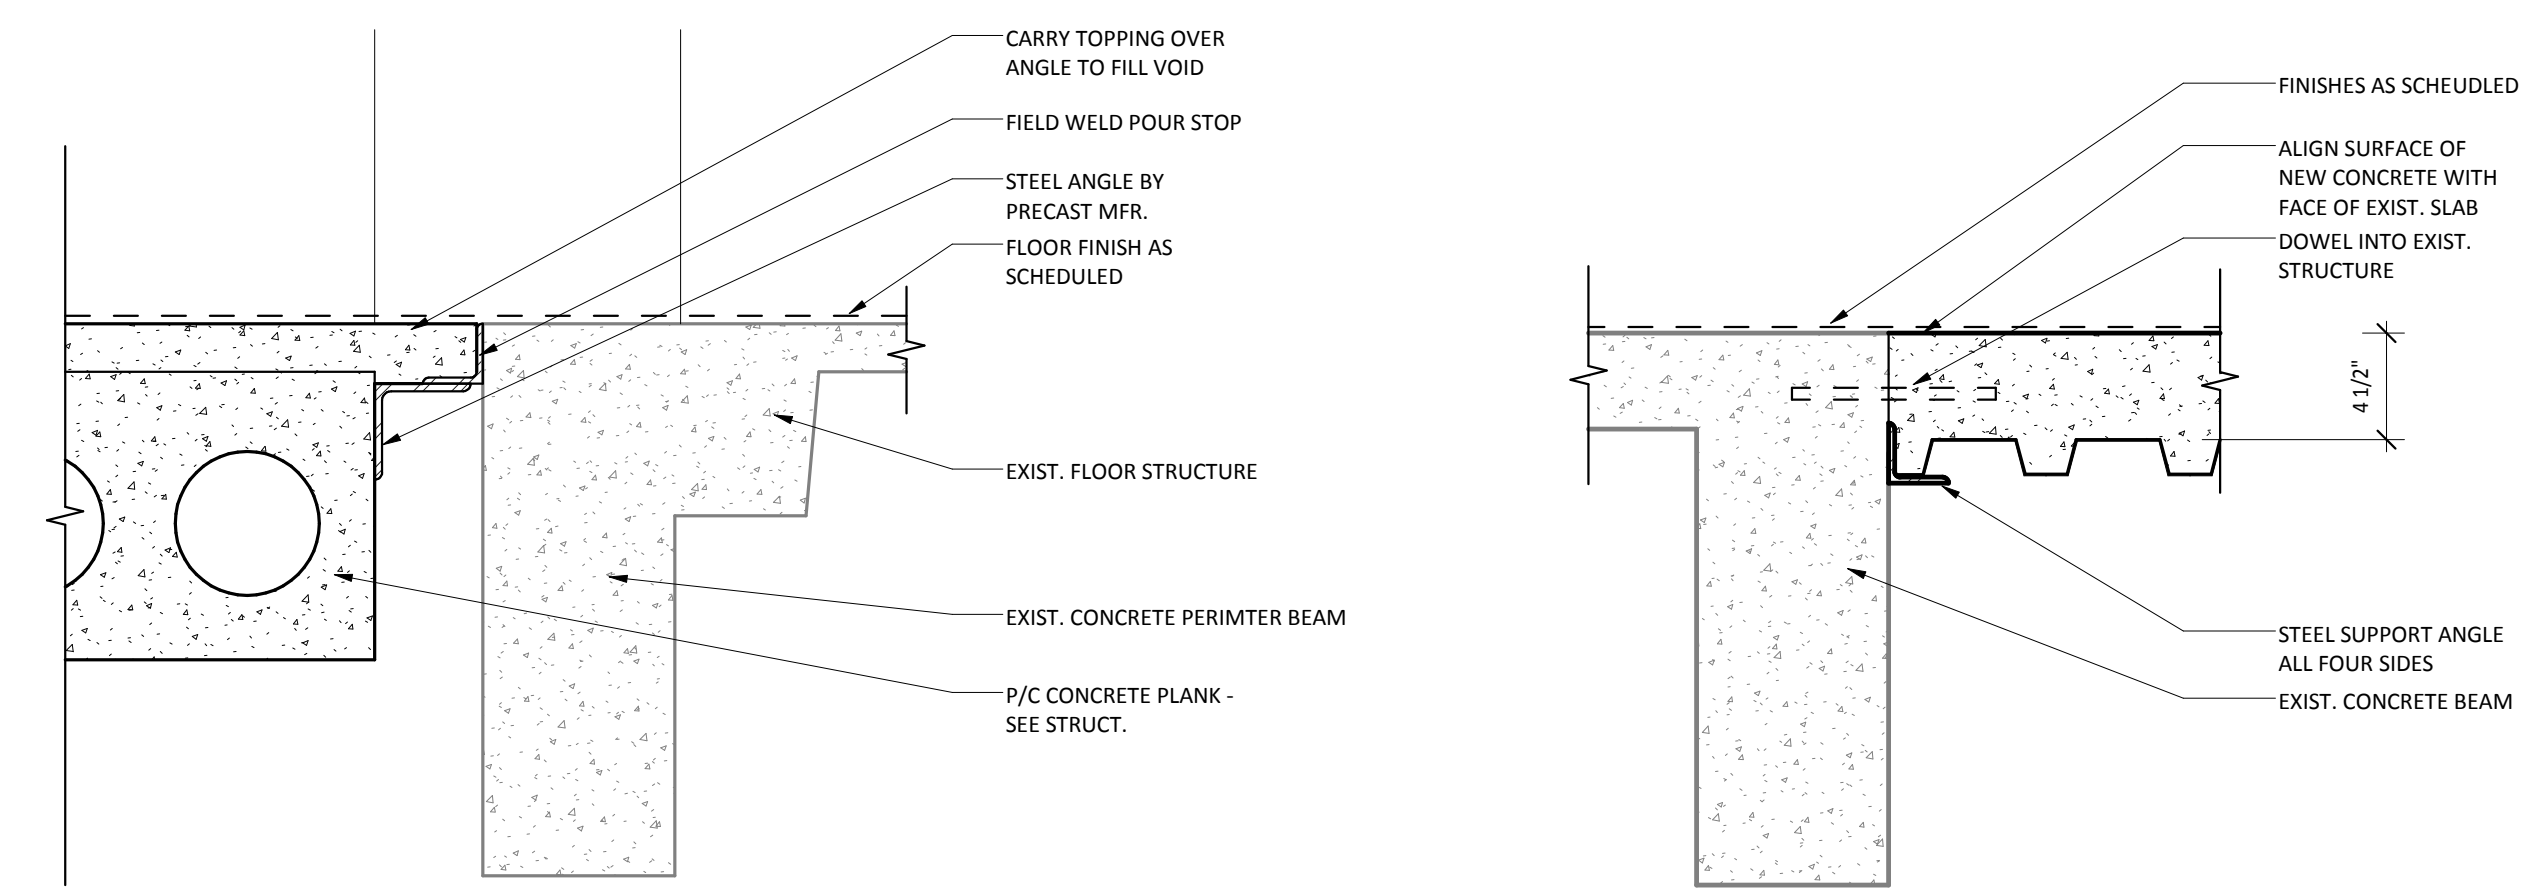


13 INFILL FLOOR GAP AT P/C EDGE
1 1/2" = 1'-0"

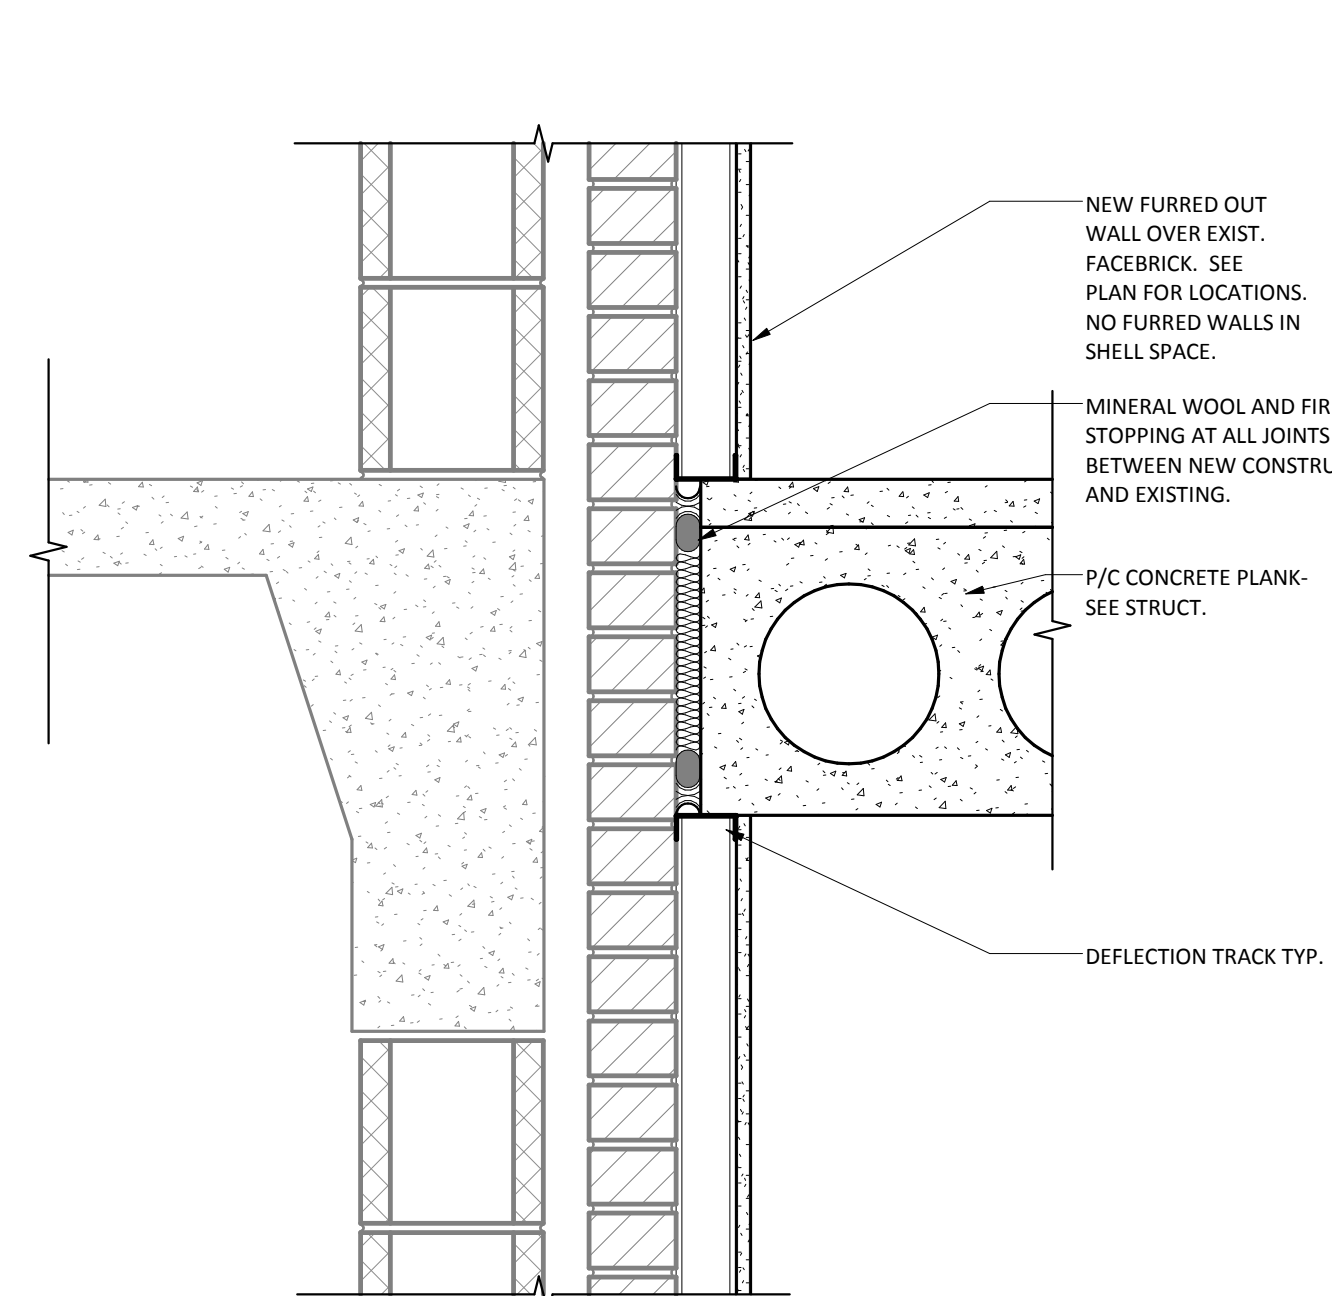


8 Callout of WALL SECTION AT EAST/WEST INFILL
1 1/2" = 1'-0"

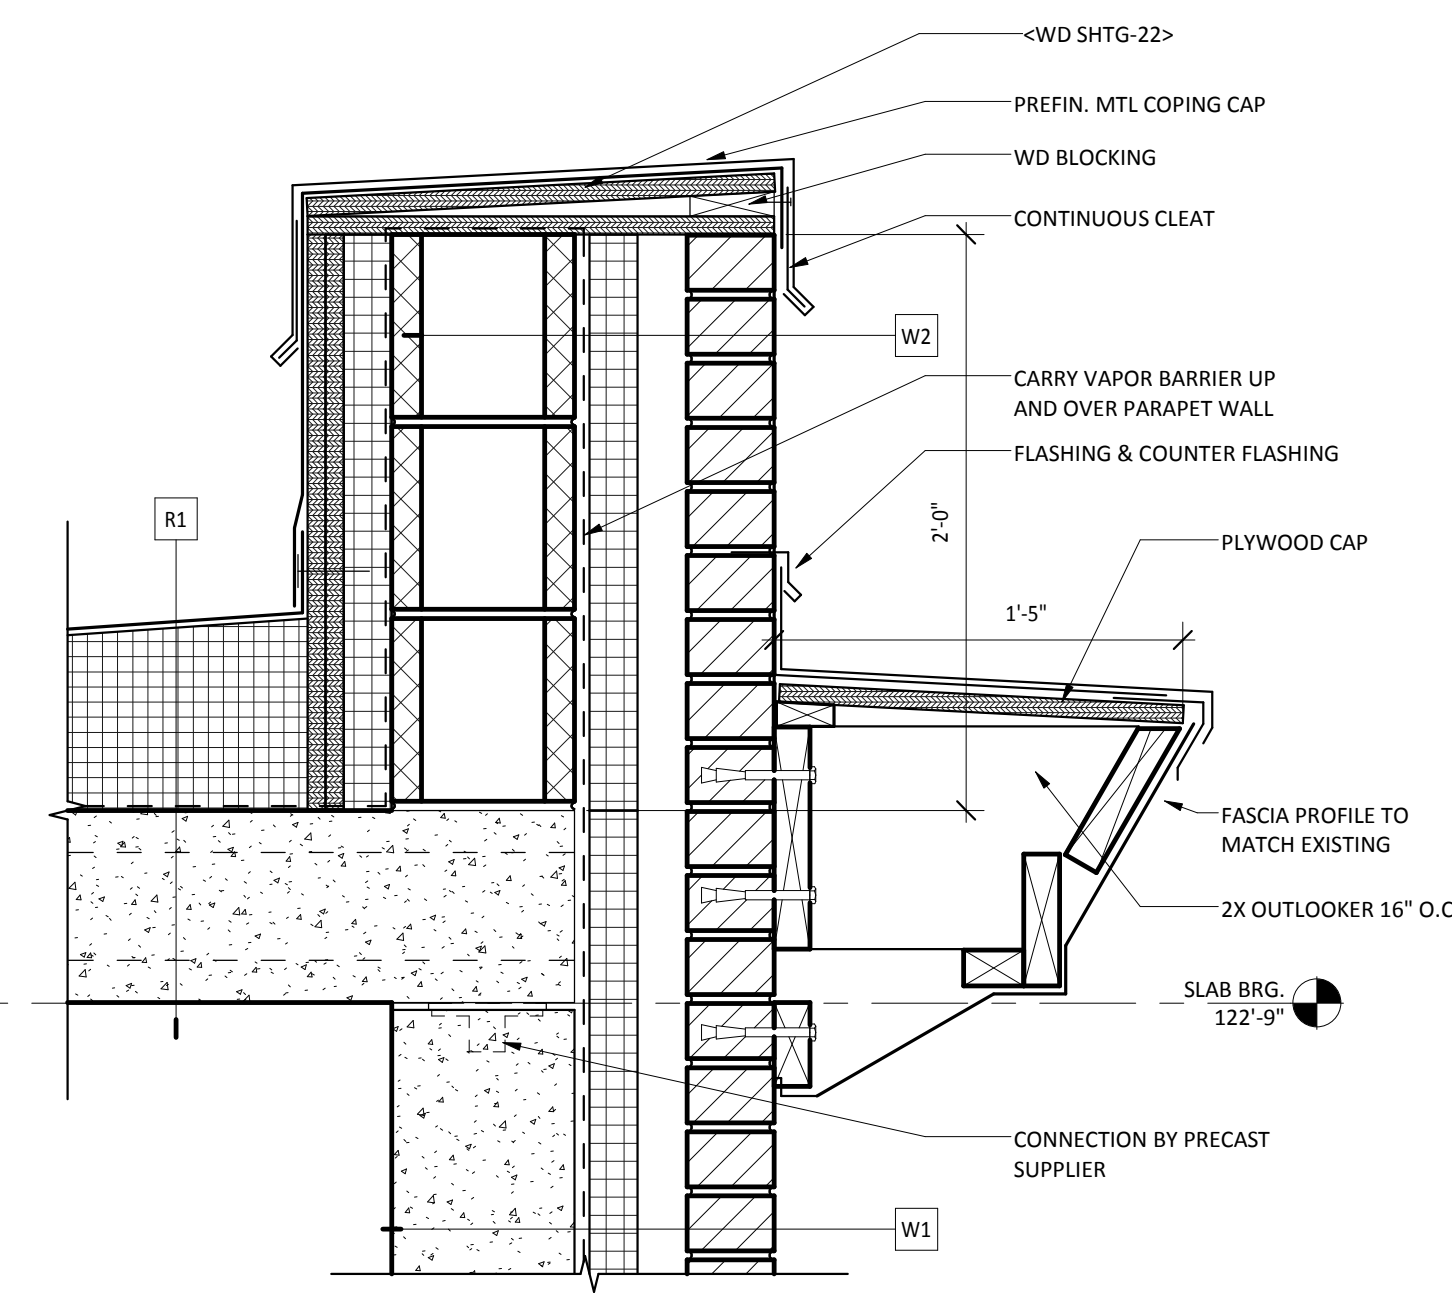


5 Callout of WALL SECTION AT EXT. WALL
1 1/2" = 1'-0"

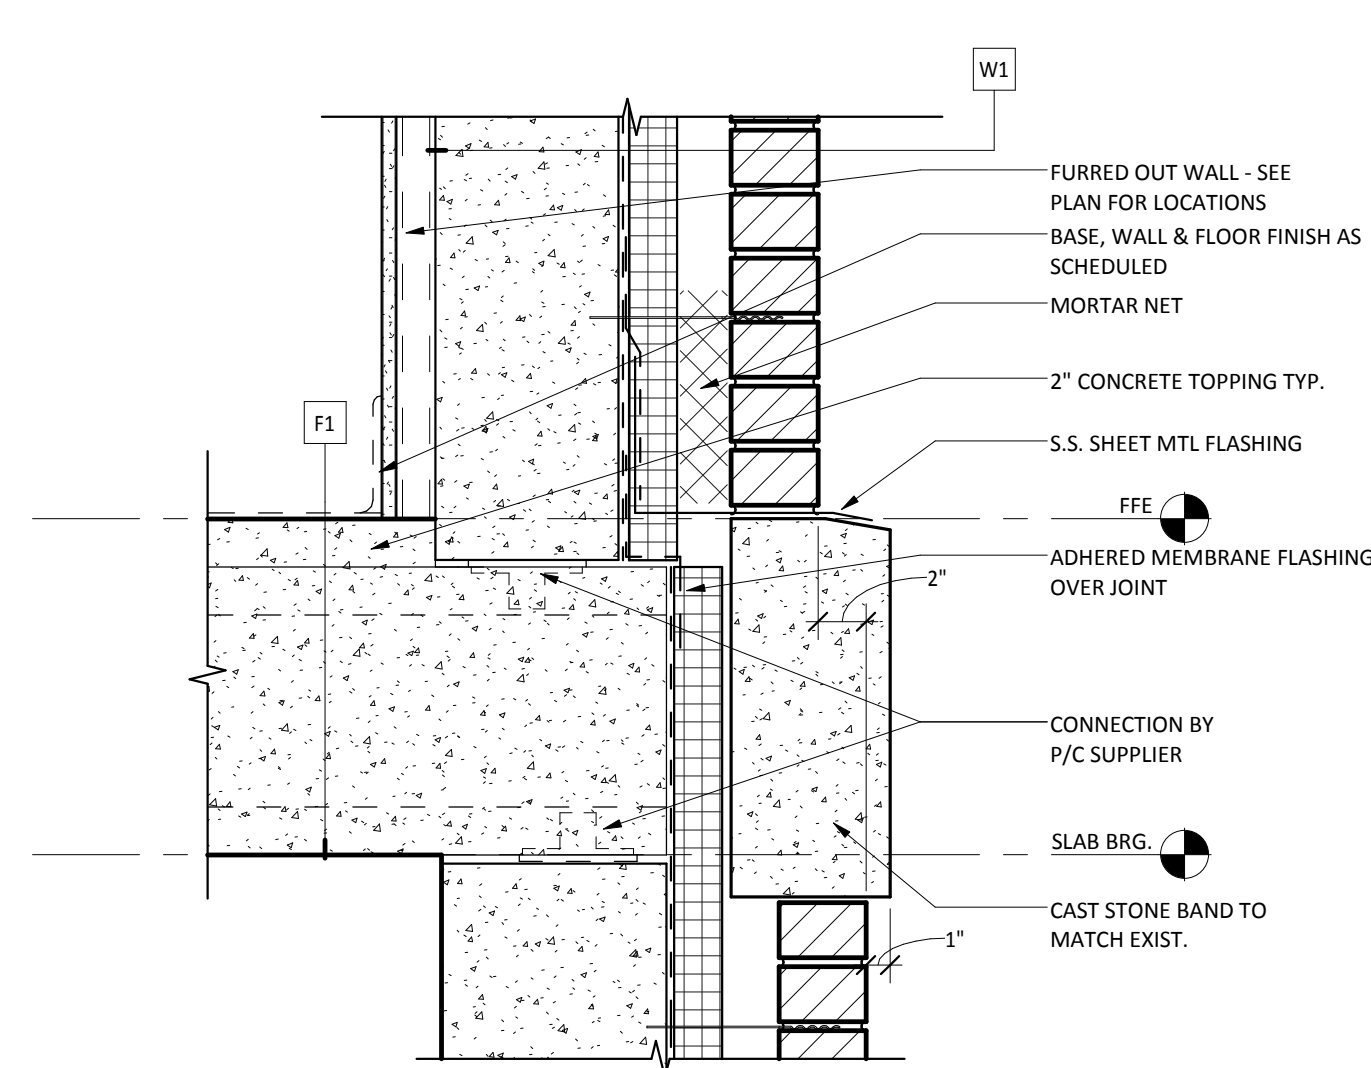


2 FLOOR SLAB AT ARCH PRECAST BAND
1 1/2" = 1'-0"

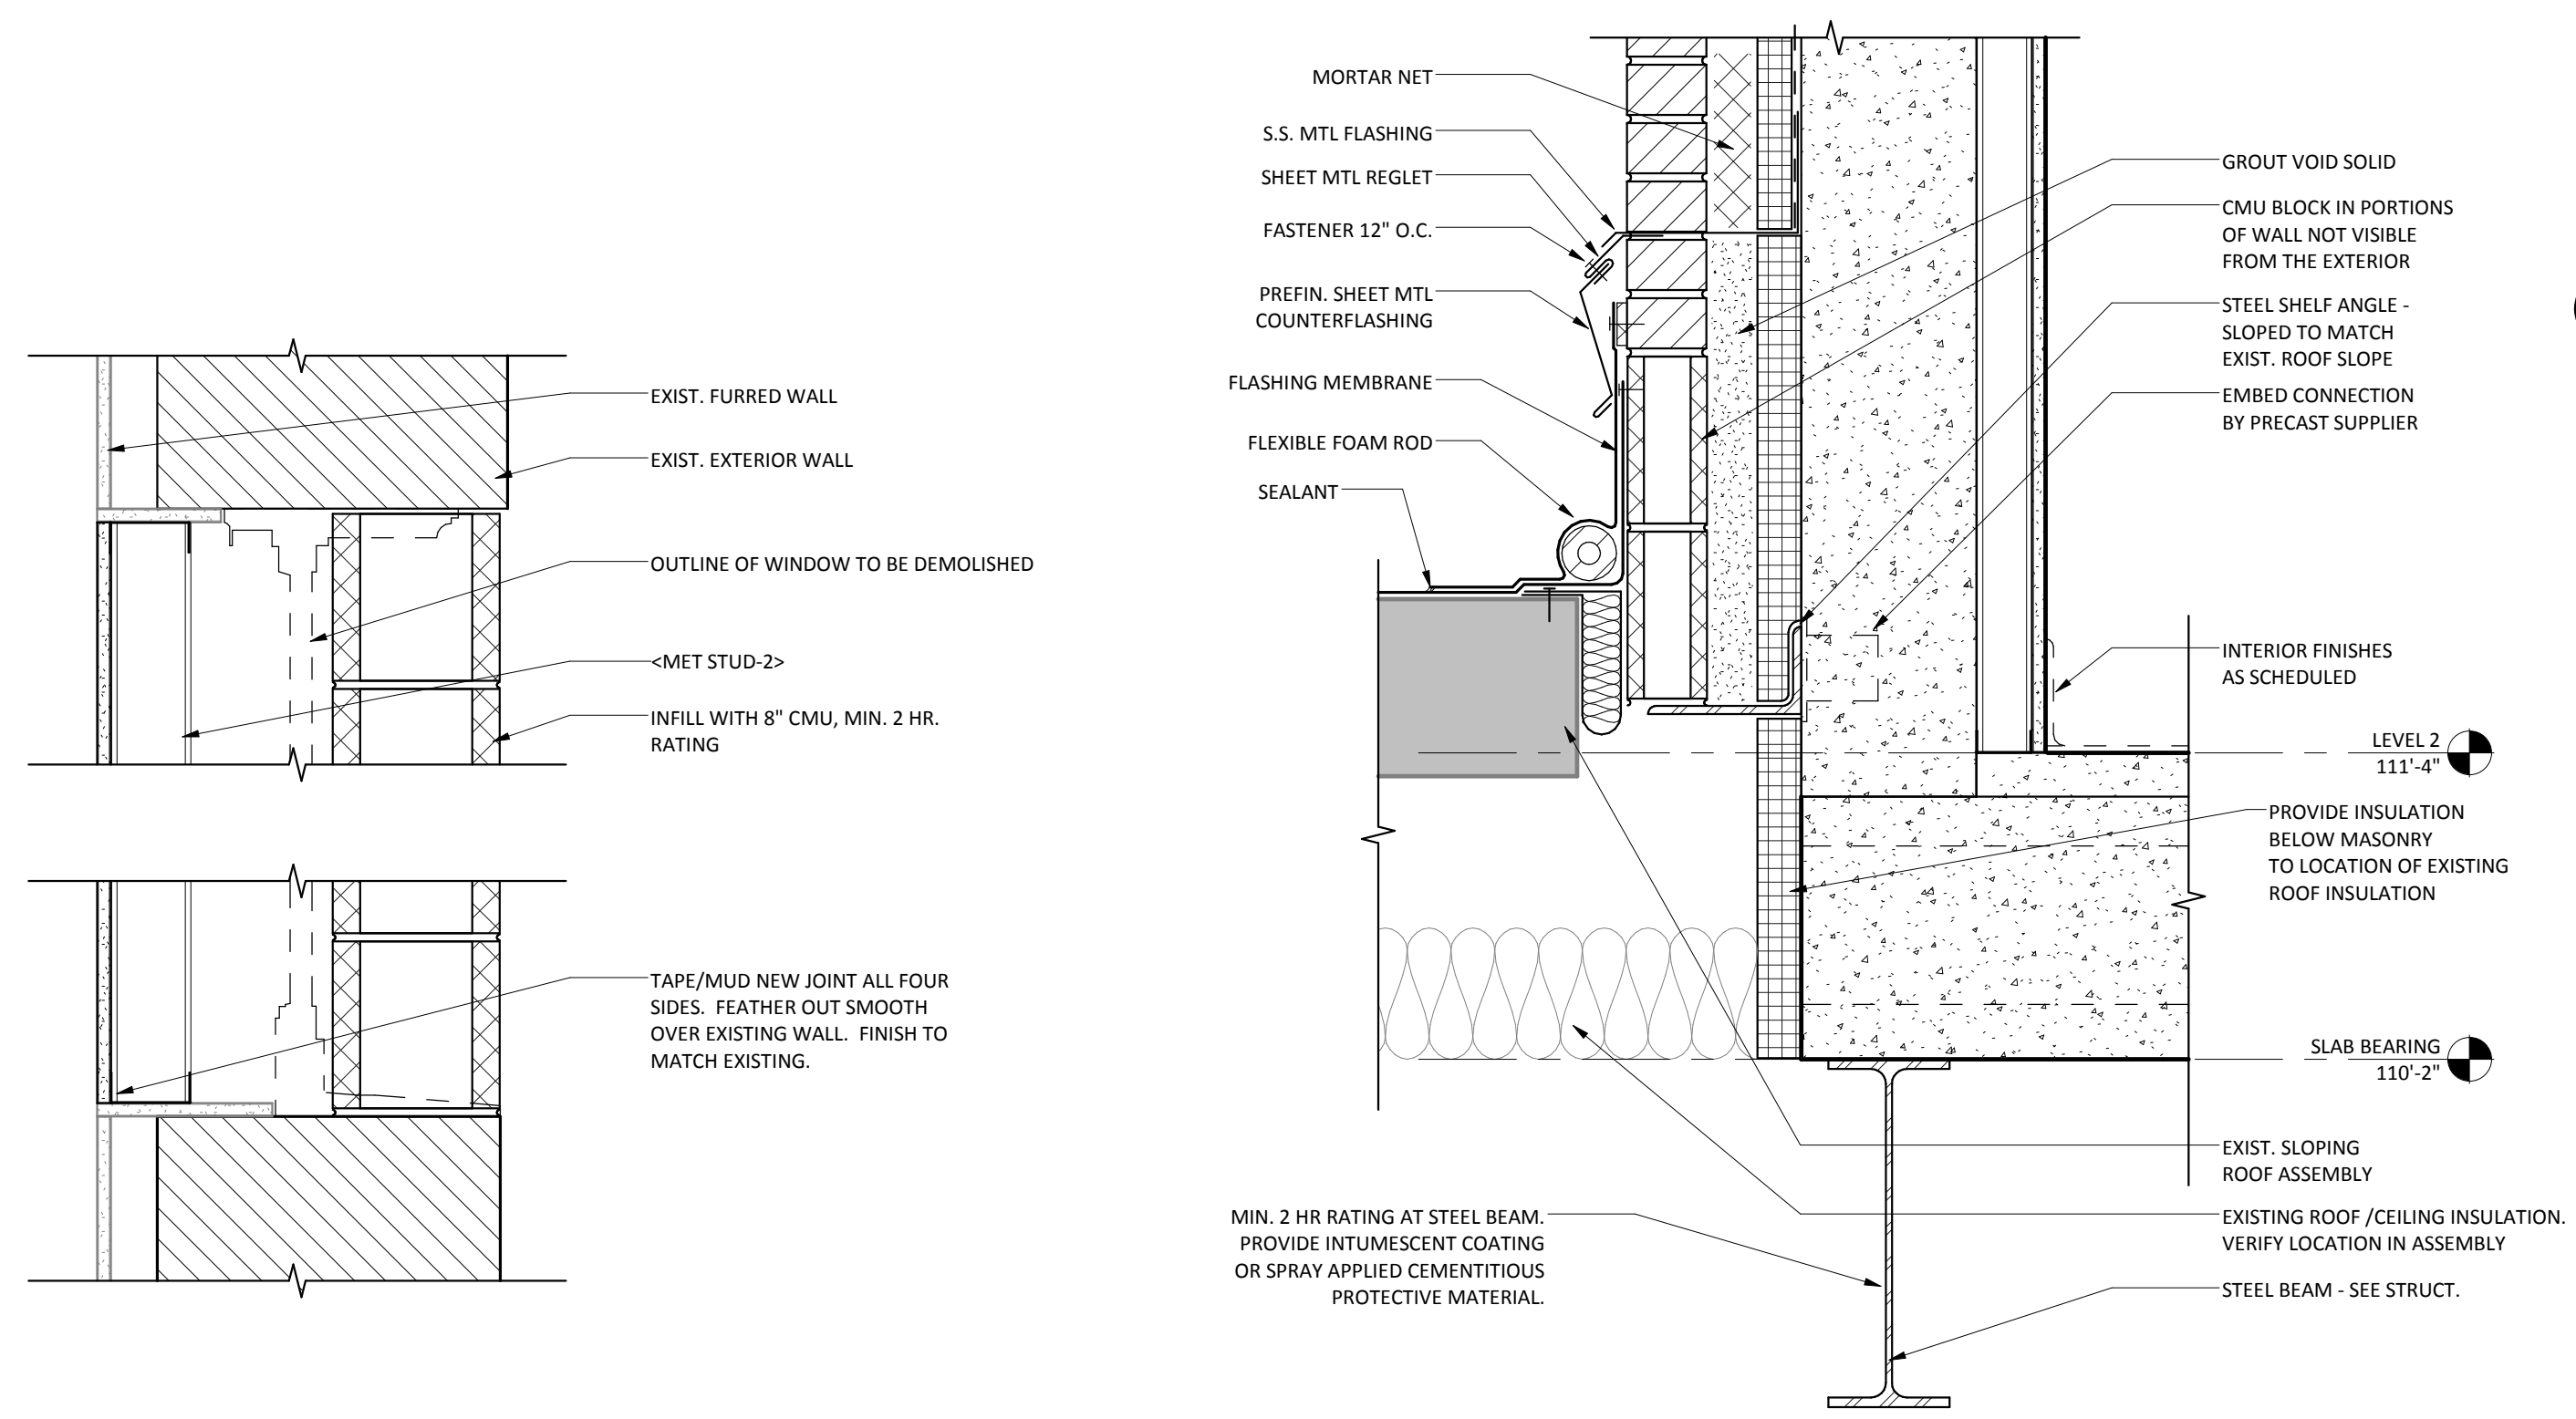


10 Callout (2) of SECTION AT WALKWAY
1 1/2" = 1'-0"

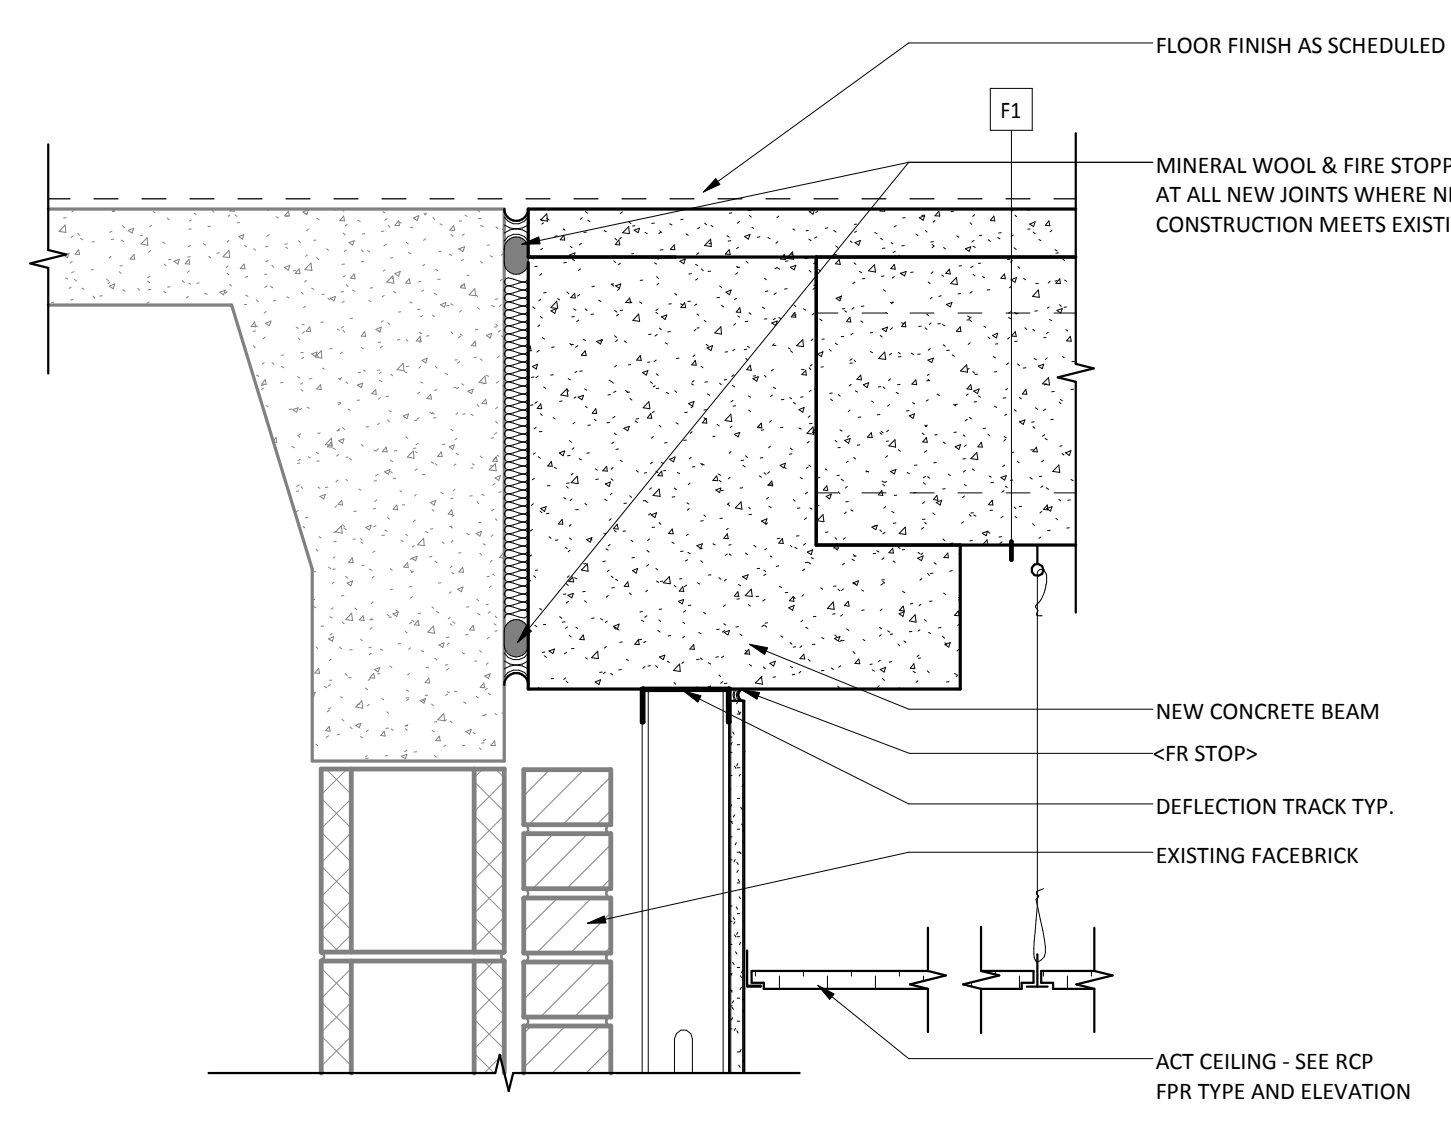

7 EXISTING FLOOR/NEW FLOOR JOINT
1 1/2" = 1'-0"

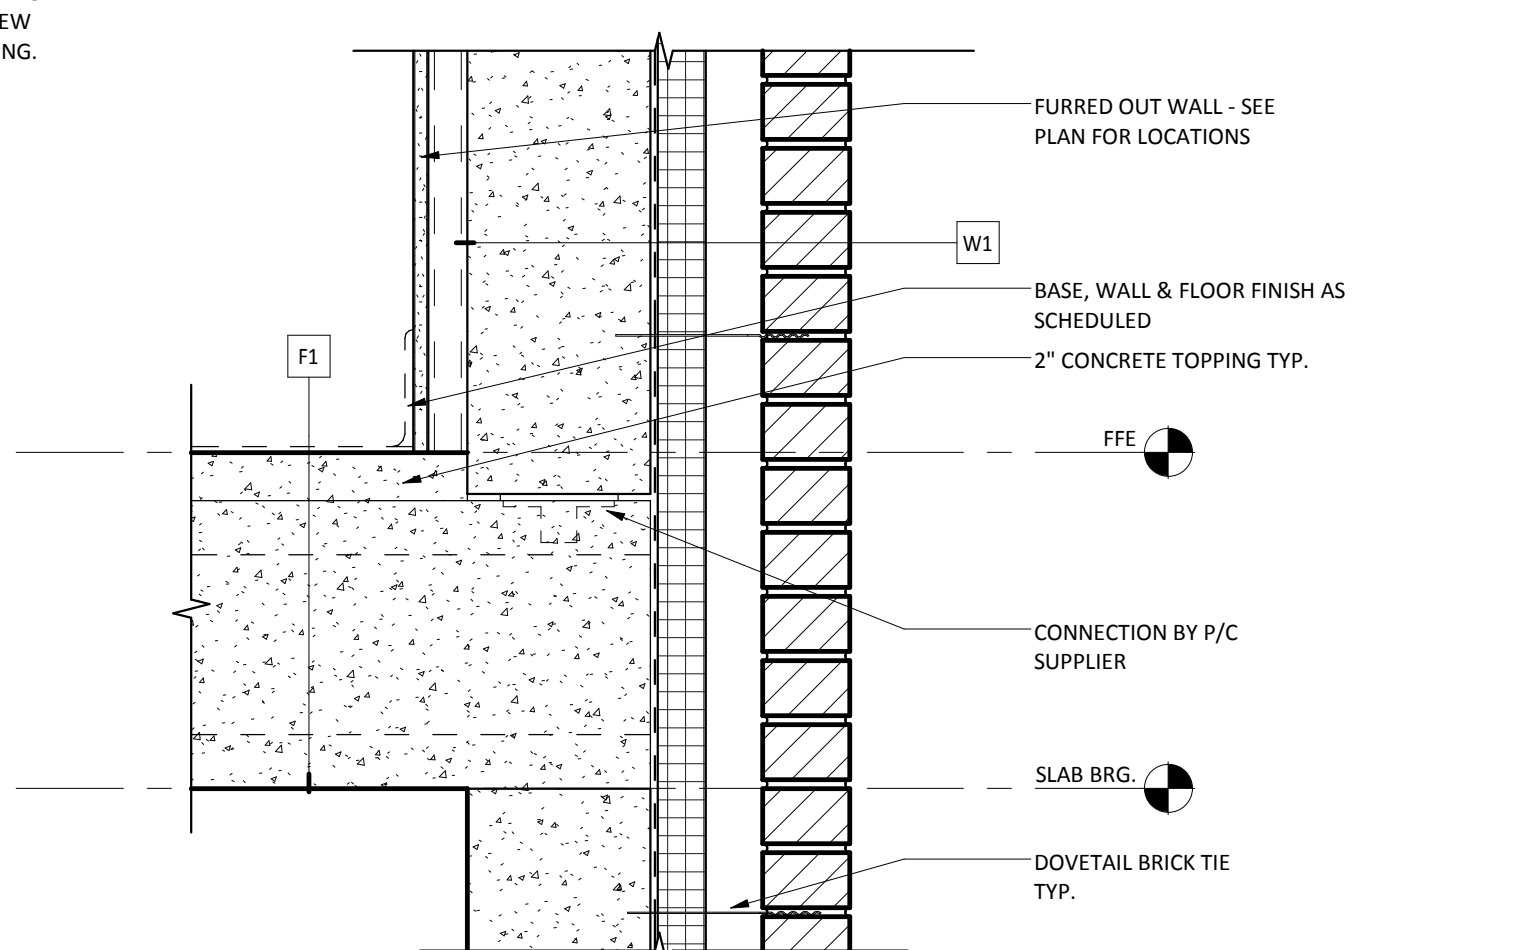

4 FLOOR AT EXTERIOR WALL
1 1/2" = 1'-0"

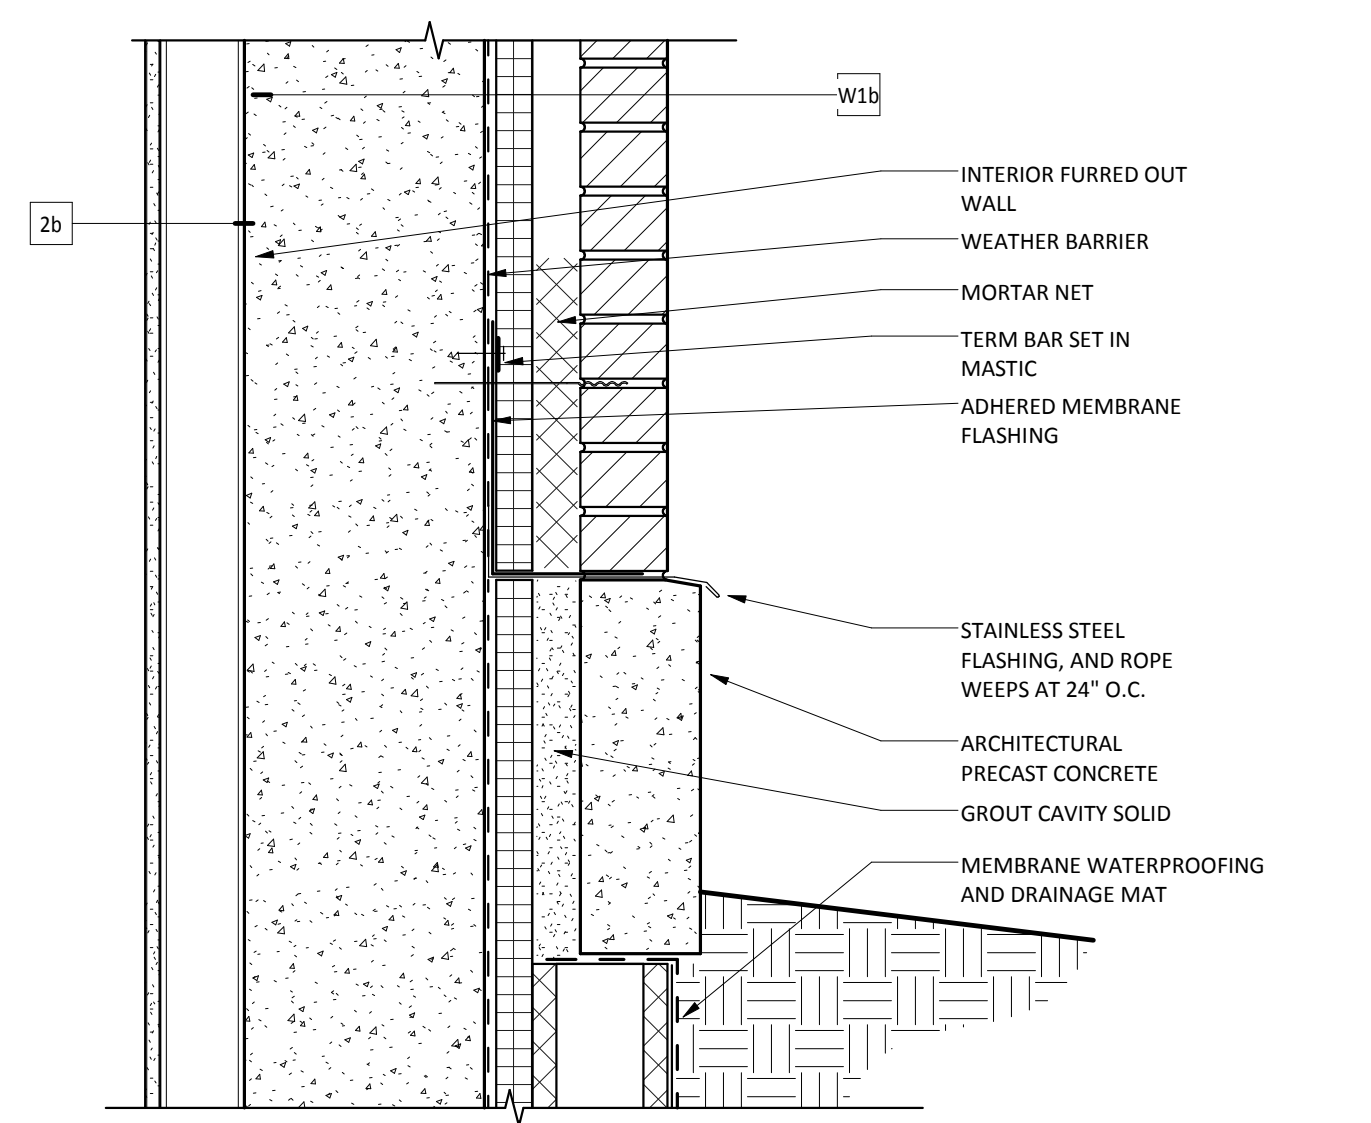

1 CAVITY WALL AT FOUNDATION
1 1/2" = 1'-0"

NO	REVISION	DATE



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DESIGNED BY: [Signature]
DATE: 12-20-2013
DRAWN BY: [Signature]
DATE: 12-20-2013


DRAWING TITLE
EXTERIOR DETAILS

PROJECT TITLE
RECONFIGURE/EXPAND
BUILDINGS 28 & 9 FOR
RESIDENTIAL REHABILITATION
TREATMENT PROGRAM
BUILDING NO: 28
CHECKED BY: DJM
DRAWN BY: ADB
DATE: 12-20-2013


DATE
12.20.13
PROJECT NO.
656-12-339
DRAWING NO.
AS501




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FOR CONSTRUCTION

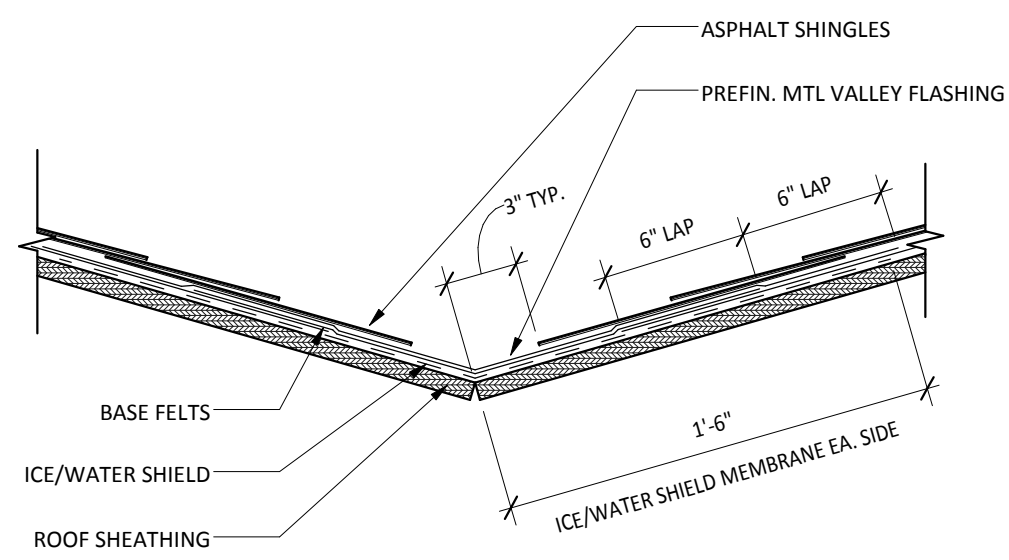


8 ASPHALT SHINGLE ROOF VALLEY TYP.
1 1/2" = 1'-0"

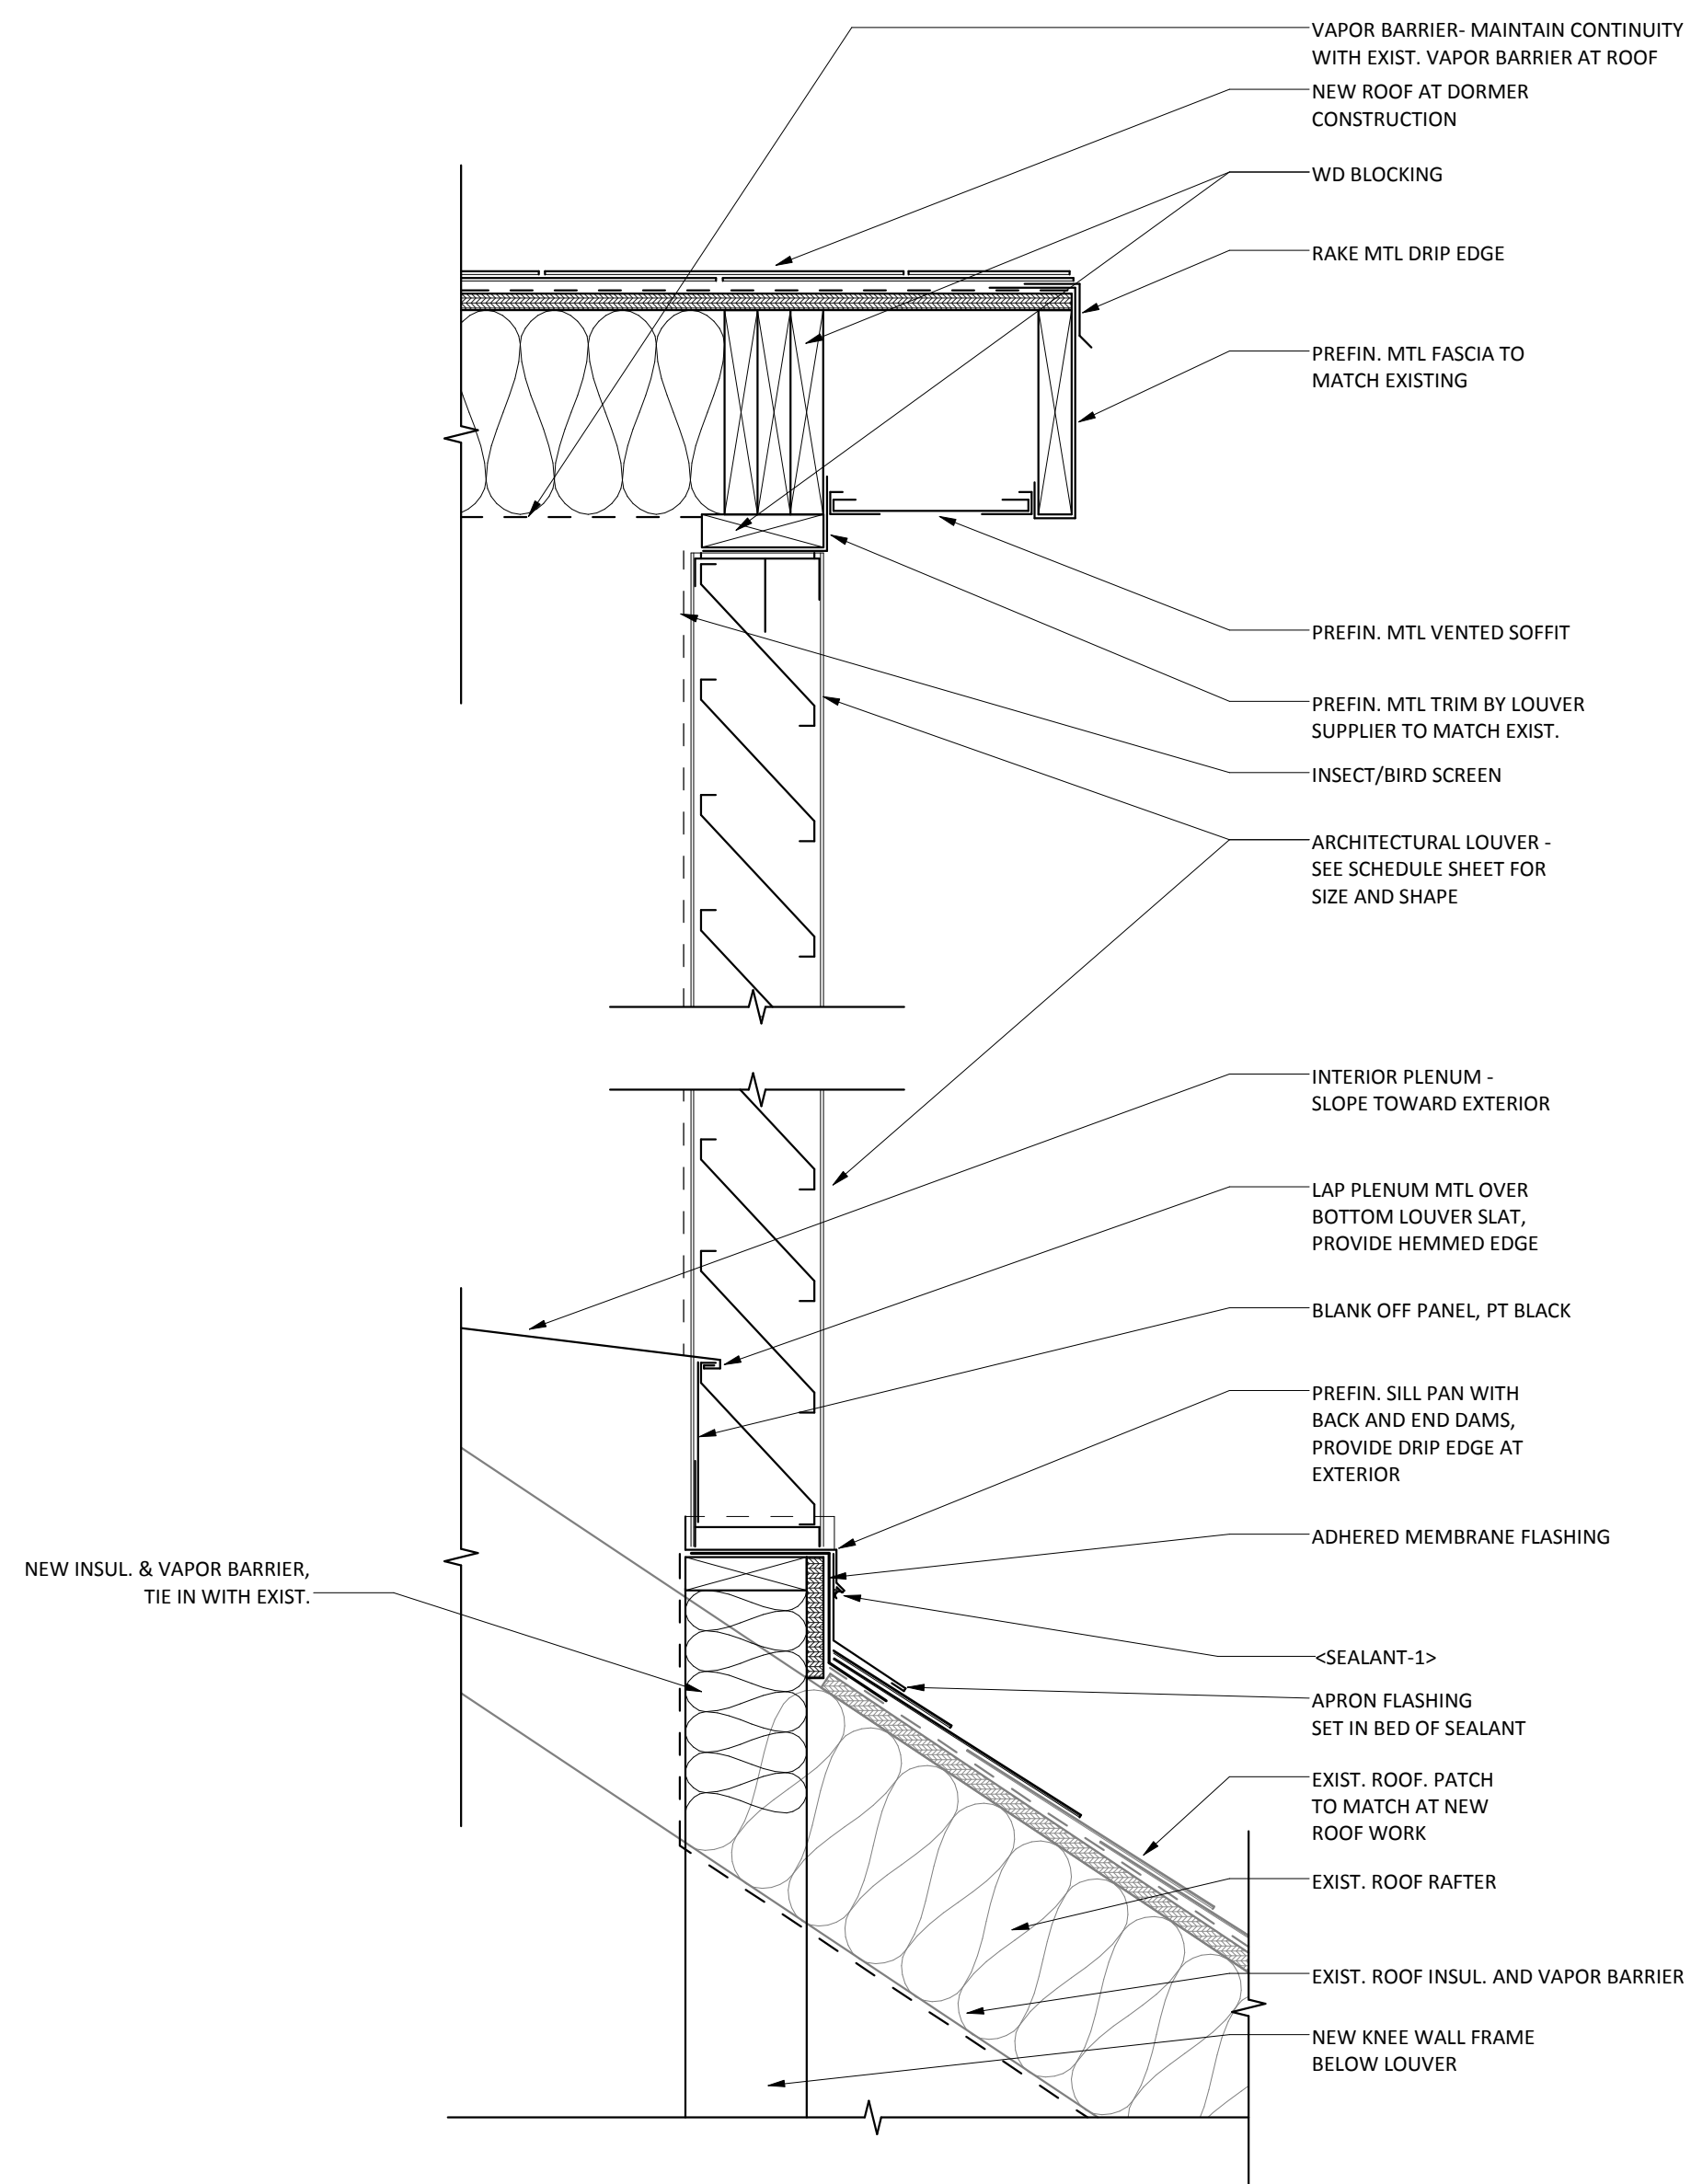


7 NEW LOUVER HEAD/SILL
1 1/2" = 1'-0"

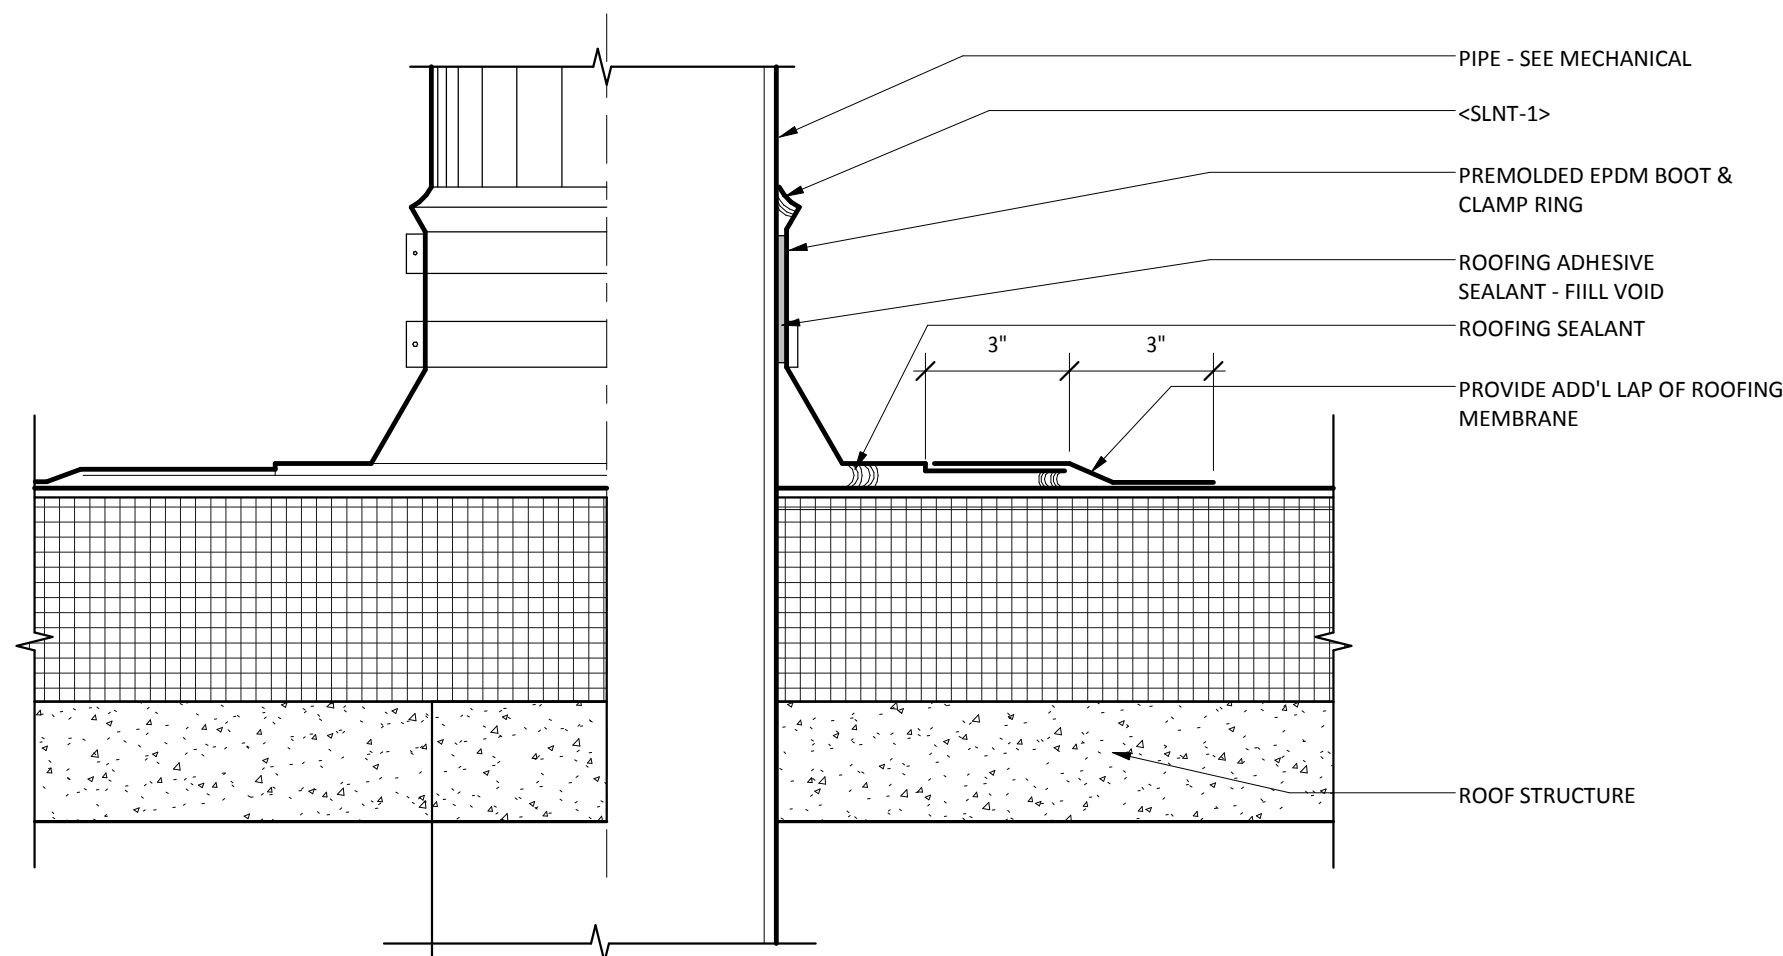


6 ROOF VENT PIPE
3" = 1'-0"

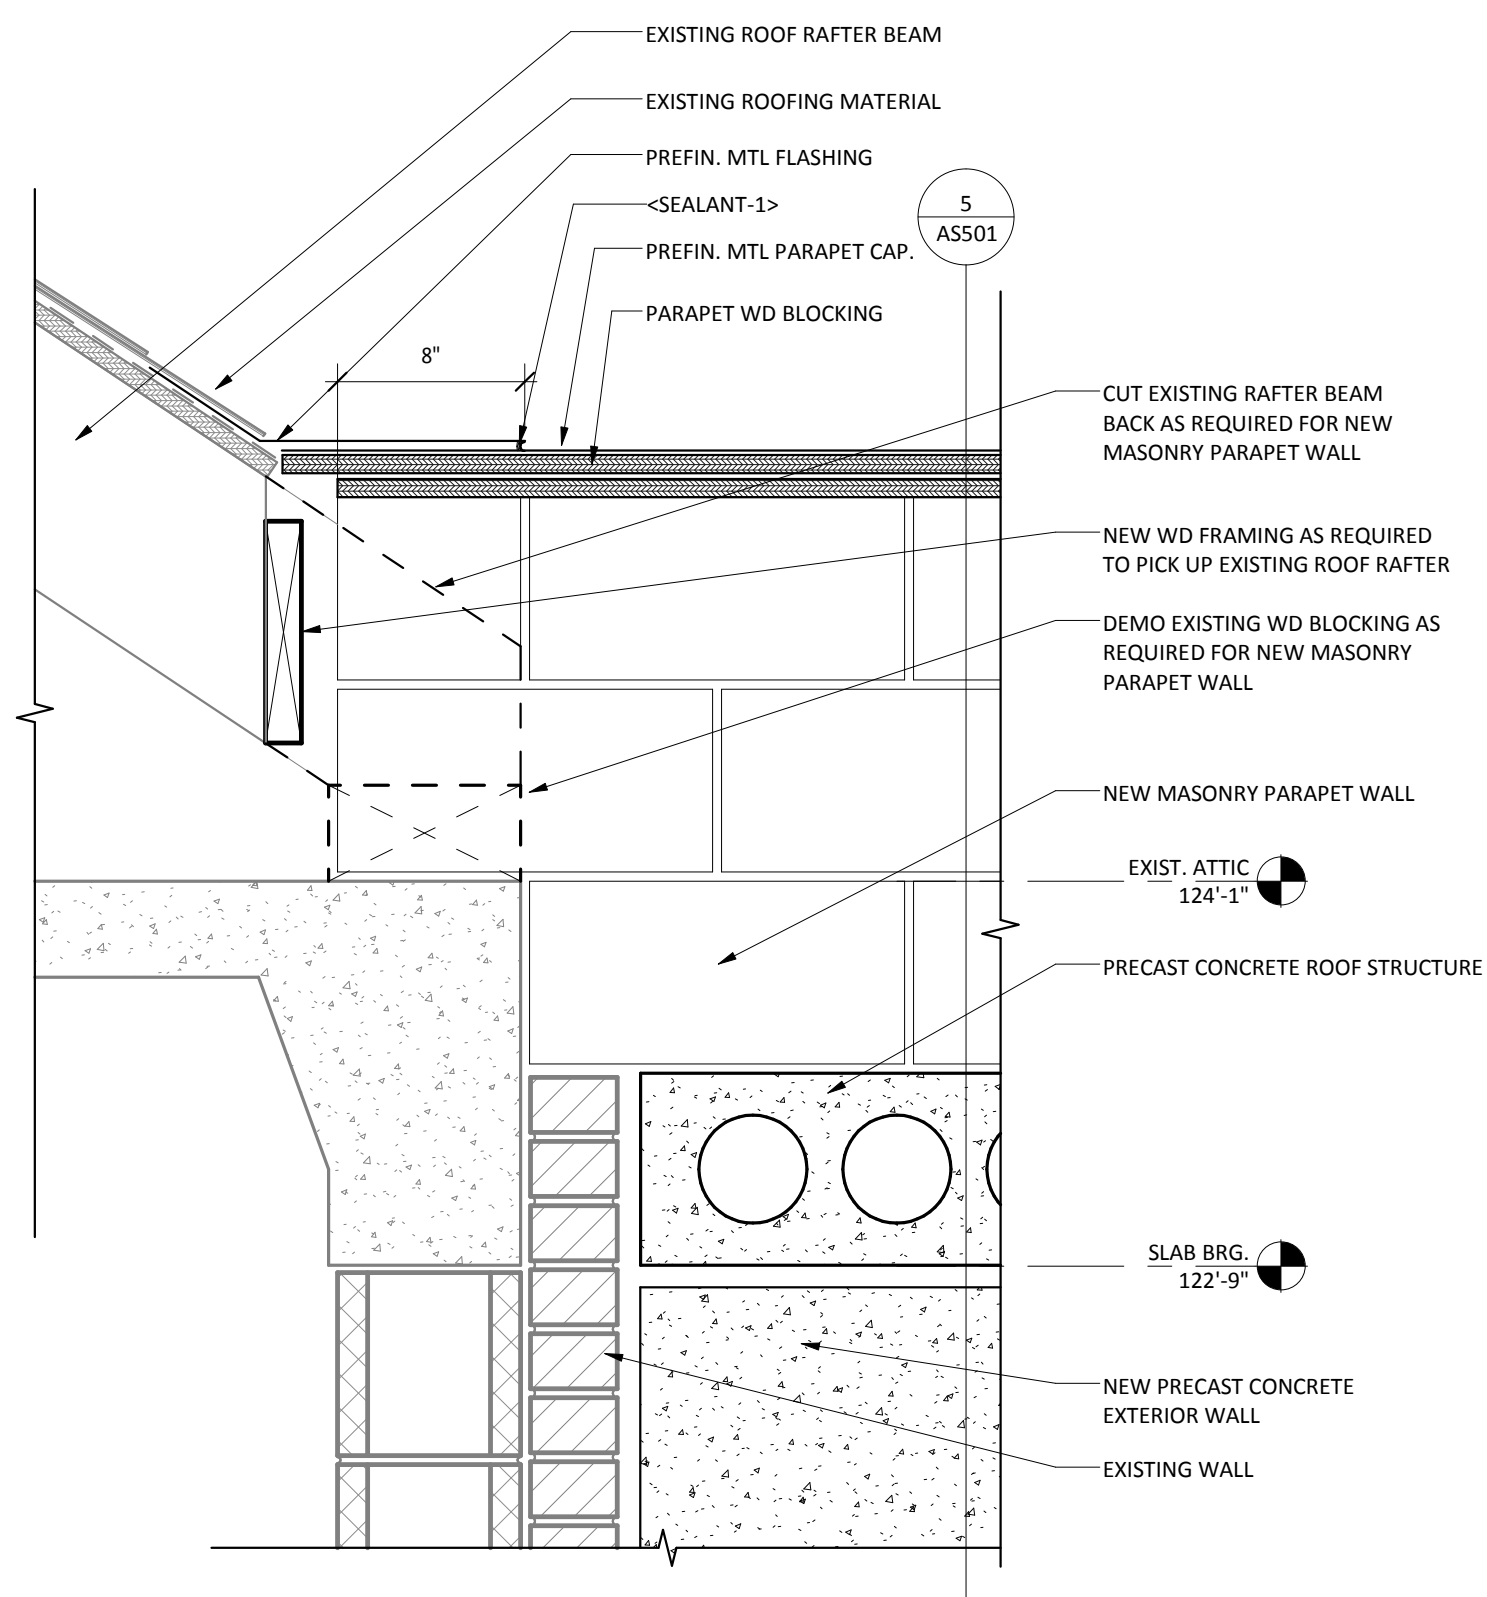


5 PARAPET WALL/EXIST. ROOF JOINT
1 1/2" = 1'-0"

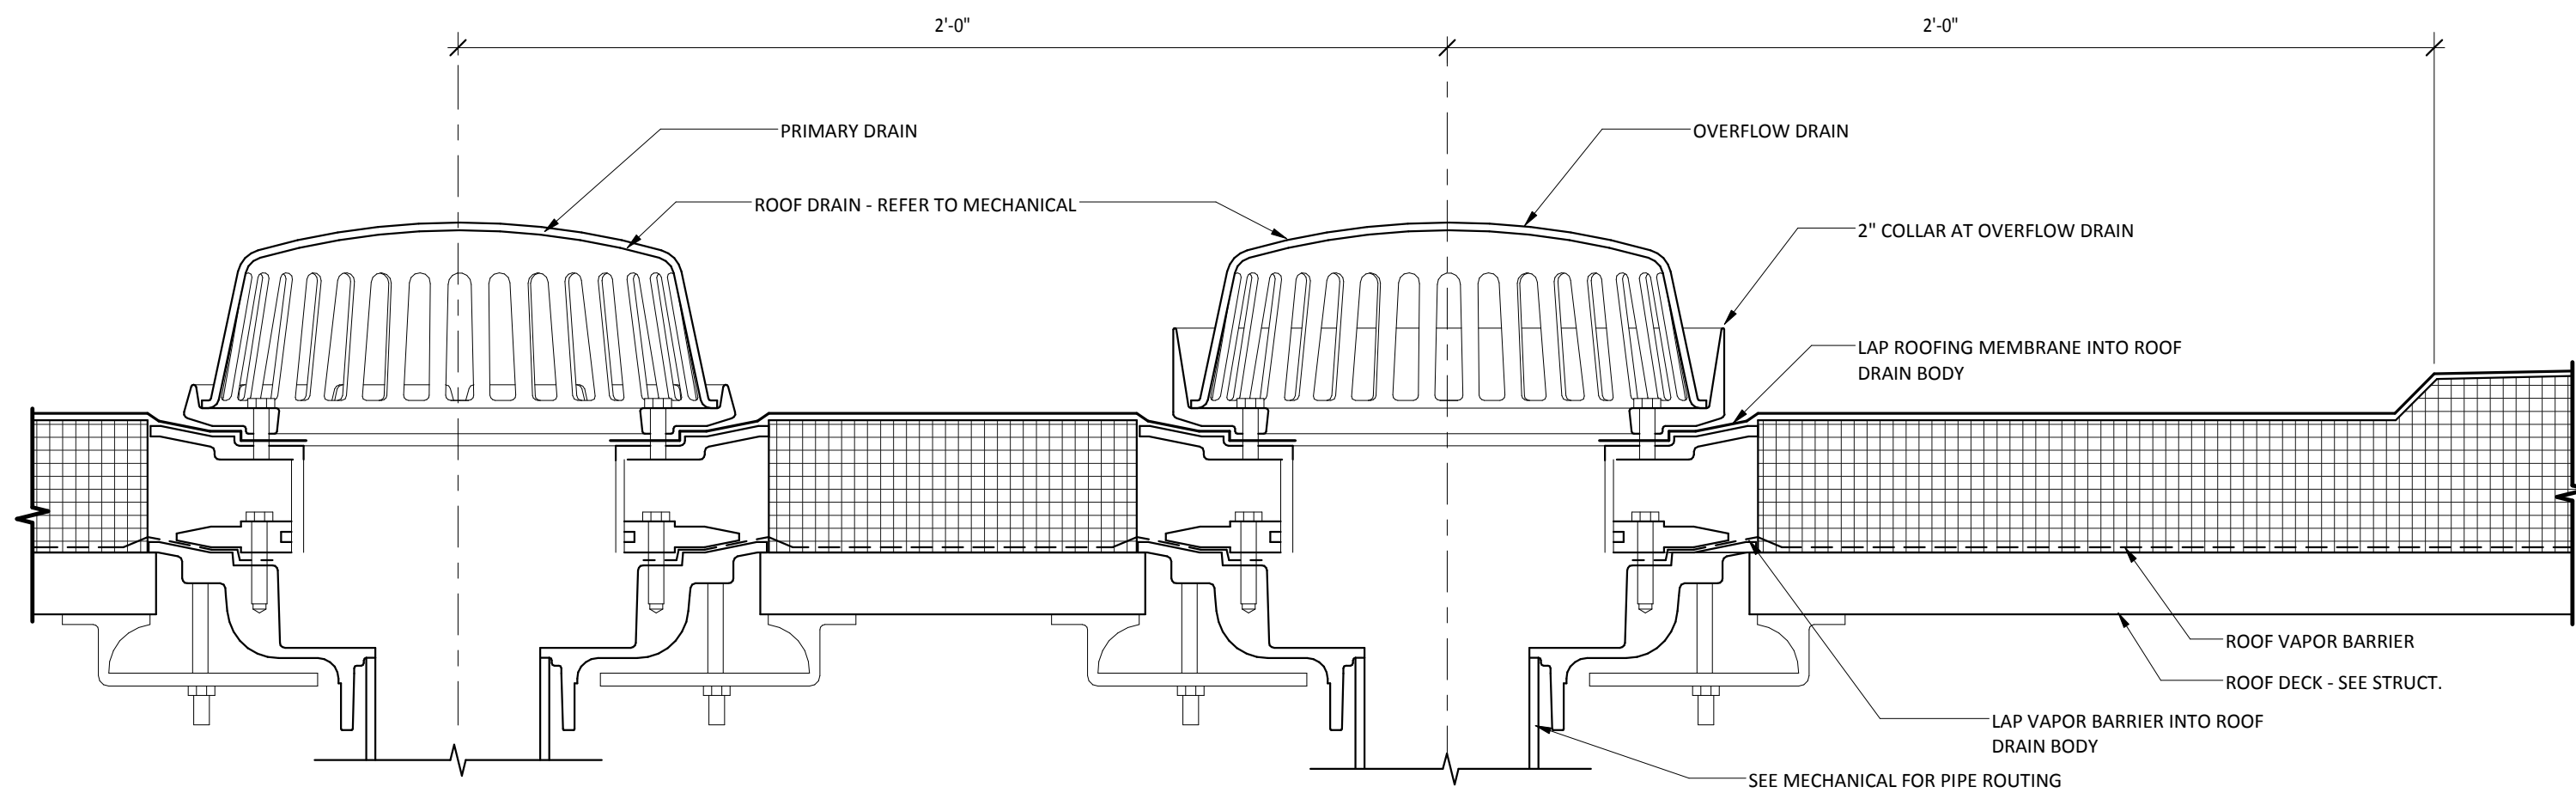


4 SECTION THROUGH ROOF SUMP
3" = 1'-0"

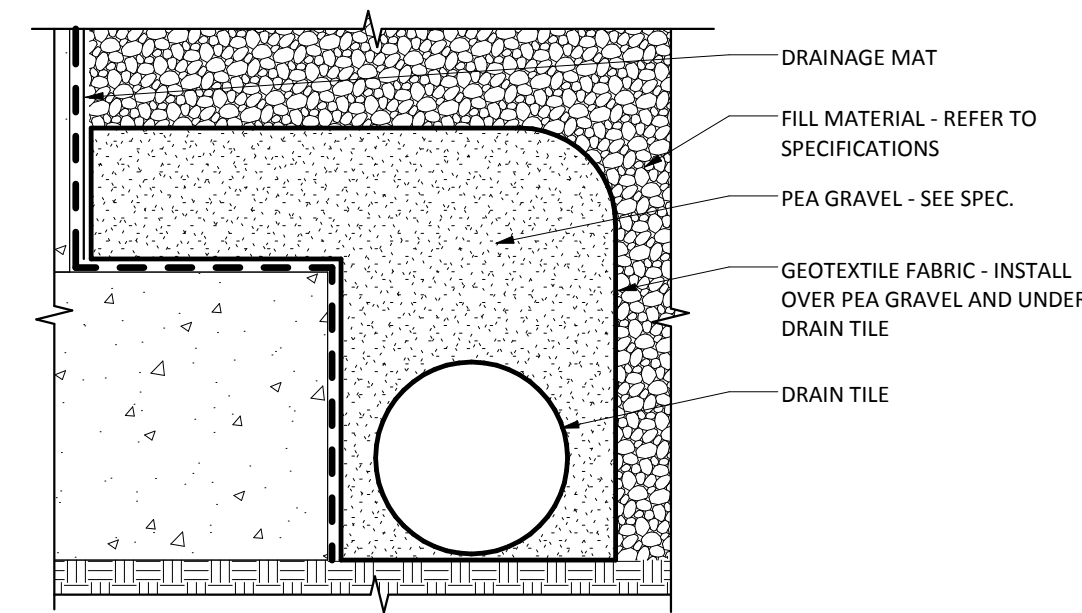

3 DRAINTILE - AT FOOTING
1 1/2" = 1'-0"

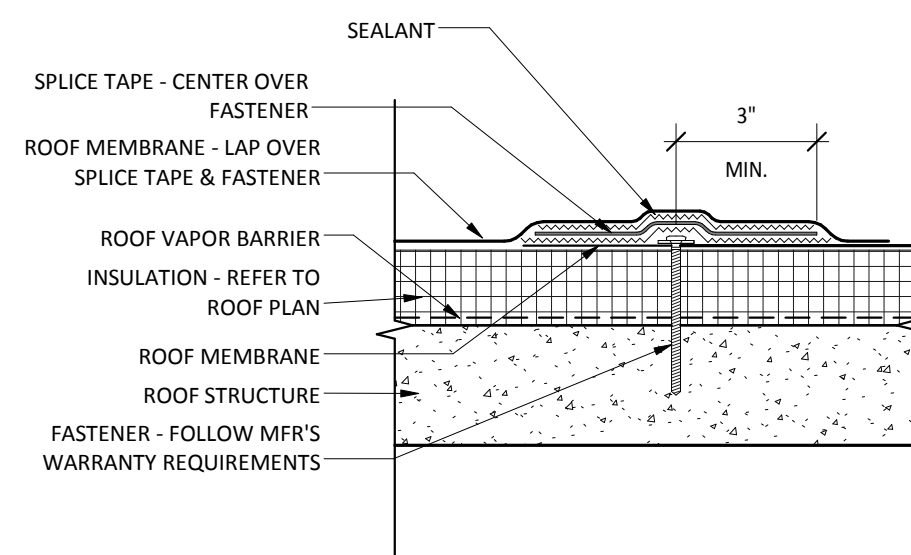


2 ROOF LAP SLICE
3" = 1'-0"

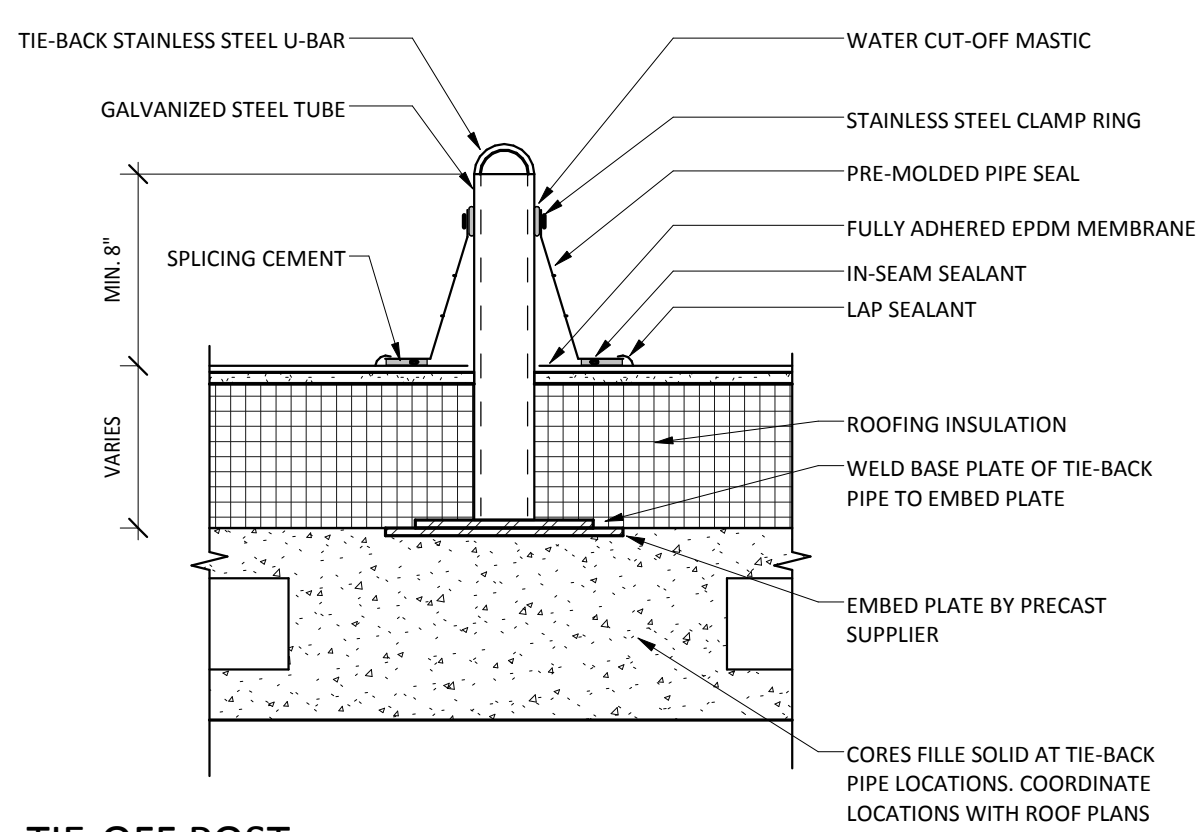


1 TIE-OFF POST
1 1/2" = 1'-0"

				ROOM FINISH SCHEDULE						
ROOM NUMBER	ROOM NAME	BASE	FLOOR	WALLS				CEILING	REMARKS	
				NORTH	EAST	SOUTH	WEST			
130	CORRIDOR	RB-1	VCT-1	PT-1	PT-1	PT-1	PT-1	SEE RCP		
131	CORRIDOR LINK	RB-1	VCT-1	PT-1	PT-1	PT-1	PT-1	SEE RCP		


DOOR SCHEDULE																			NOTES
DOOR NUMBER	ROOM NAME	SIZE			MAT'L	TYPE	DOORS		FRAME				DETAILS			RATING	HW SET		
		WIDTH	HEIGHT	THK			FINISH	GLZ	MAT'L	TYPE	FINISH	GLZ	JAMB	HEAD	SILL				
131A	CORRIDOR LINK	3'-4"	8'-7"	2"	AL	A	MATCH INT. PSYCH	SEE ELEV.	AL	SEE ELEV.	MATCH INT. PSYCH	--	--	--	--	HW E4	SALVAGED ALUM. DOOR REMOVED FROM INT. PSYCH BLDG		
131B	CORRIDOR LINK	3'-0"	7'-5 1/2"	2"	AL	A	MATCH INT. PSYCH	SEE ELEV.	AL	SEE ELEV.	MATCH INT. PSYCH	--	--	--	--	HW E4			
131C	CORRIDOR LINK	3'-4"	7'-0"	1 3/4"	WD	N	PT-4	SEE ELEV.	HM	1A	PT-4	--	--	--	90 MIN	HW 6F-2			
131D	CORRIDOR LINK	3'-4"	7'-0"	1 3/4"	WD	N	PT-4	SEE ELEV.	HM	1A	PT-4	--	--	--	90 MIN	HW 6F-1			

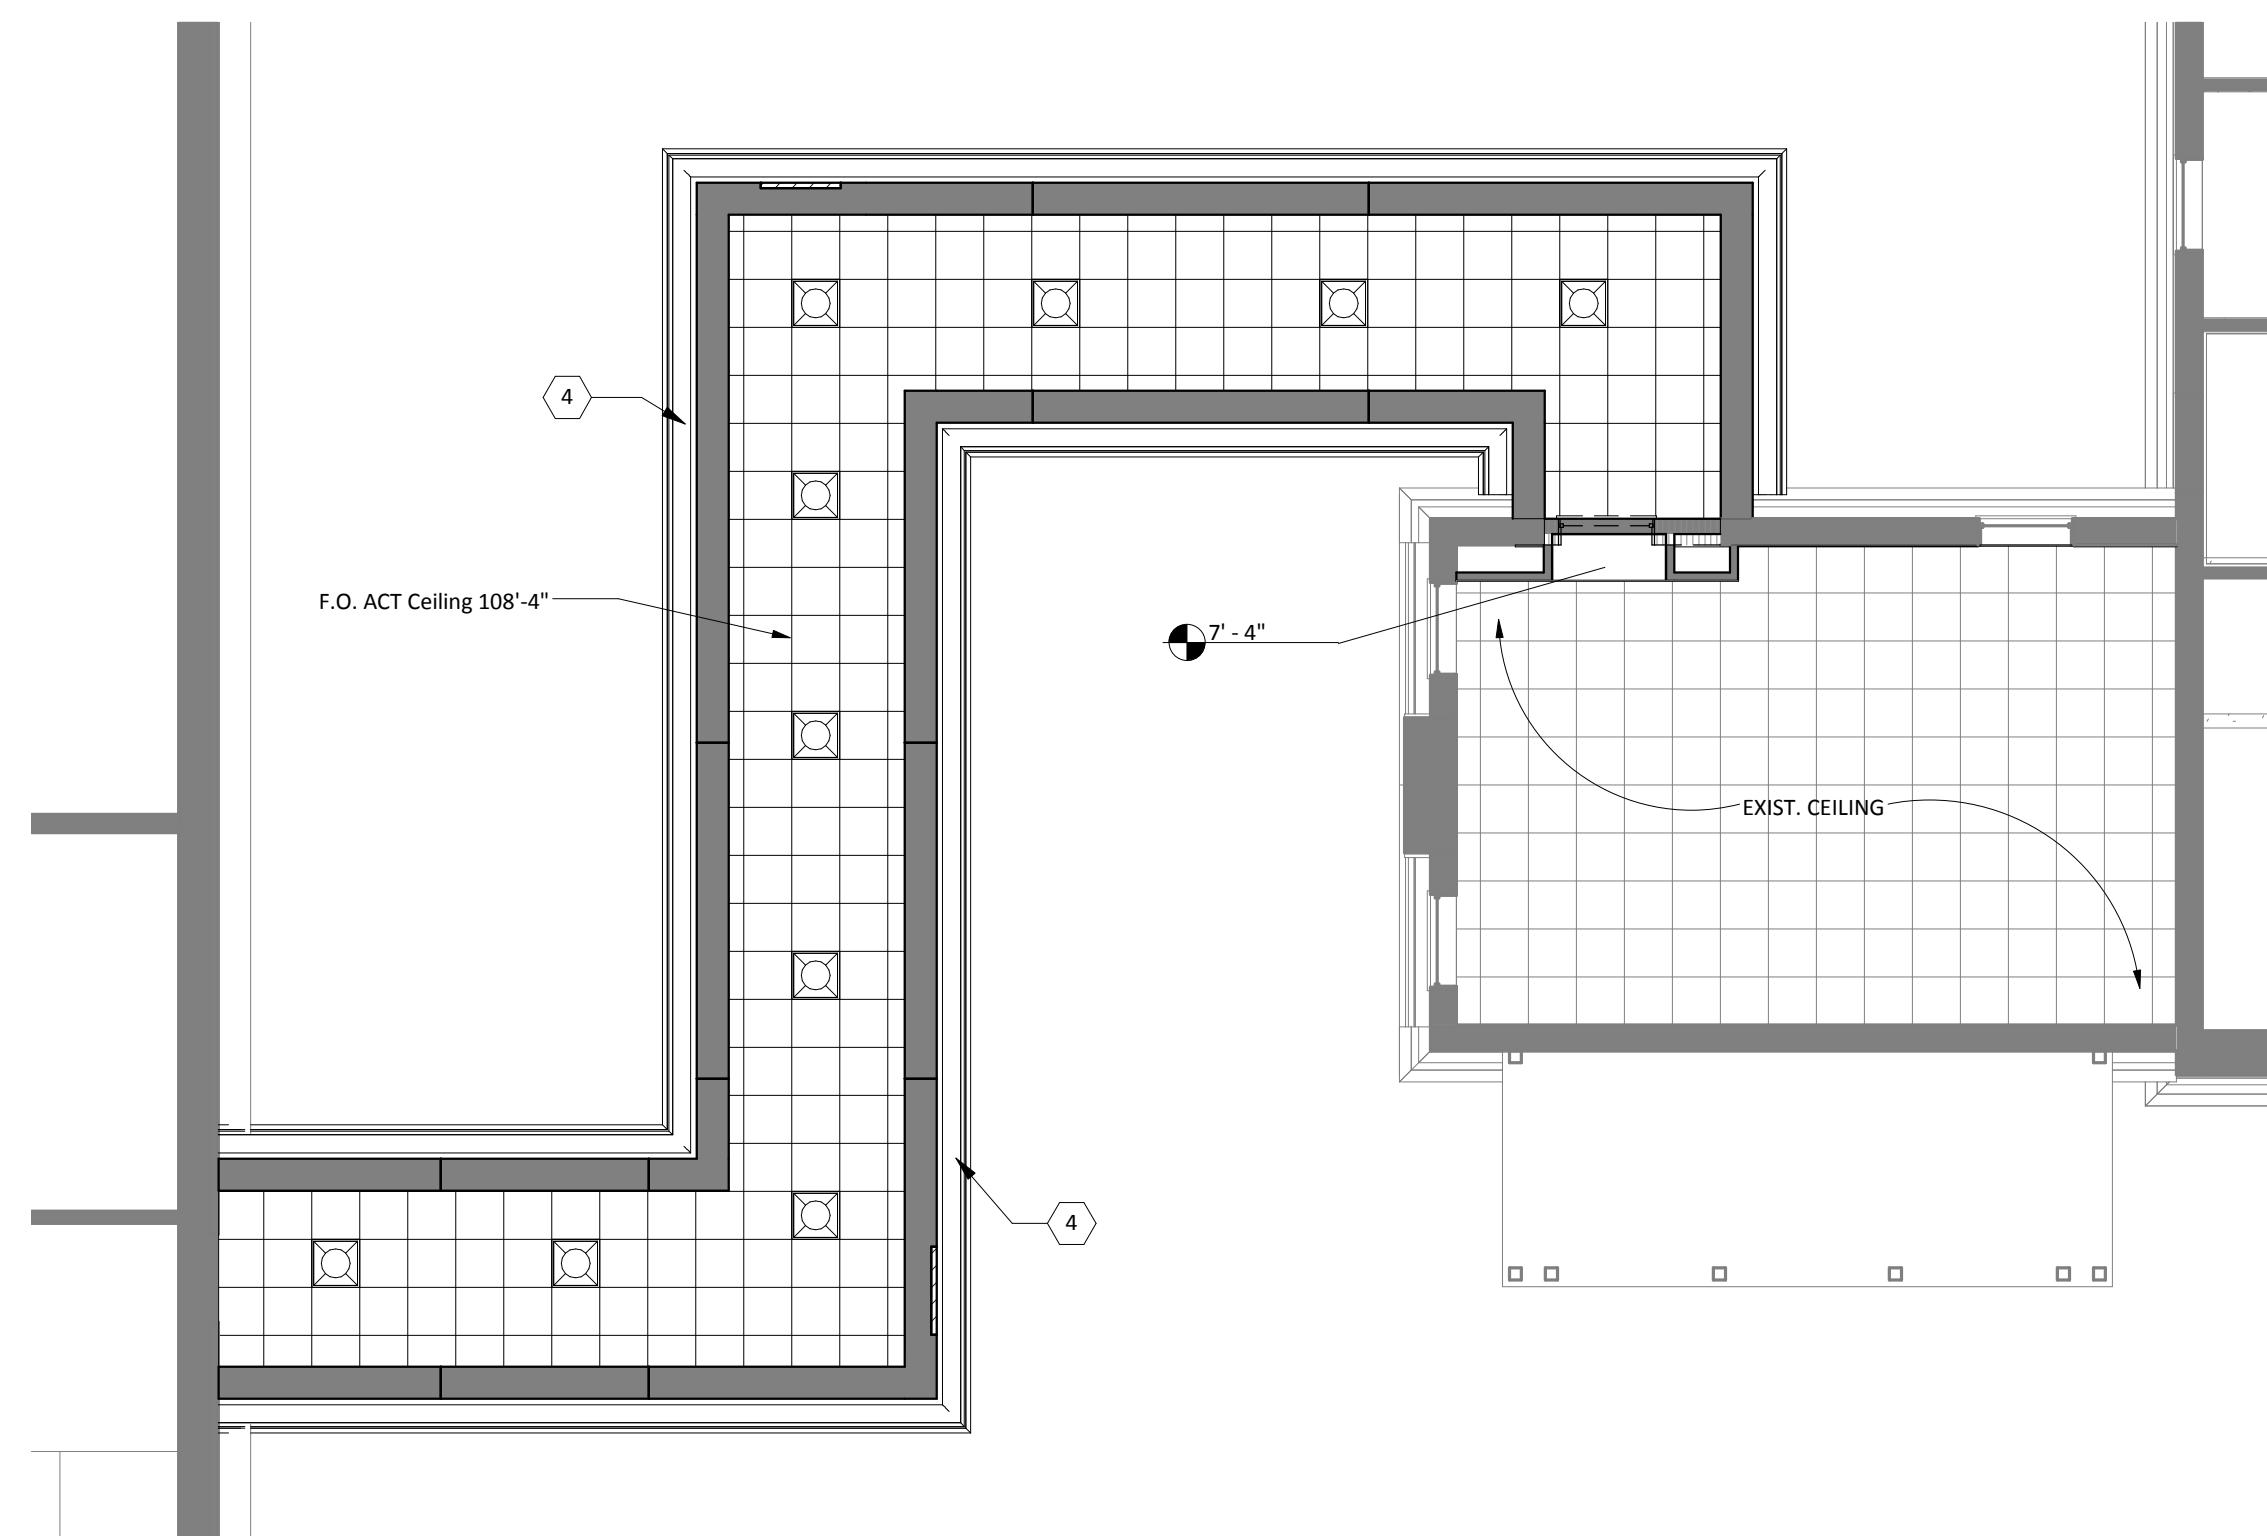

8 LINK - REFLECTED CEILING PLAN
1/8" = 1'-0"

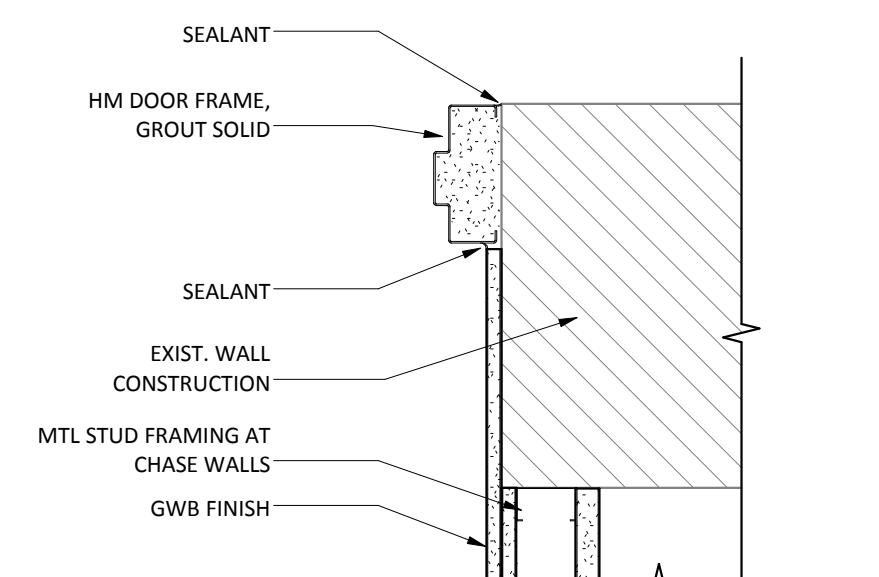


⑦ Callout of BUILDING 9/LINK TRANSITION
1 1/2" = 1'-0"

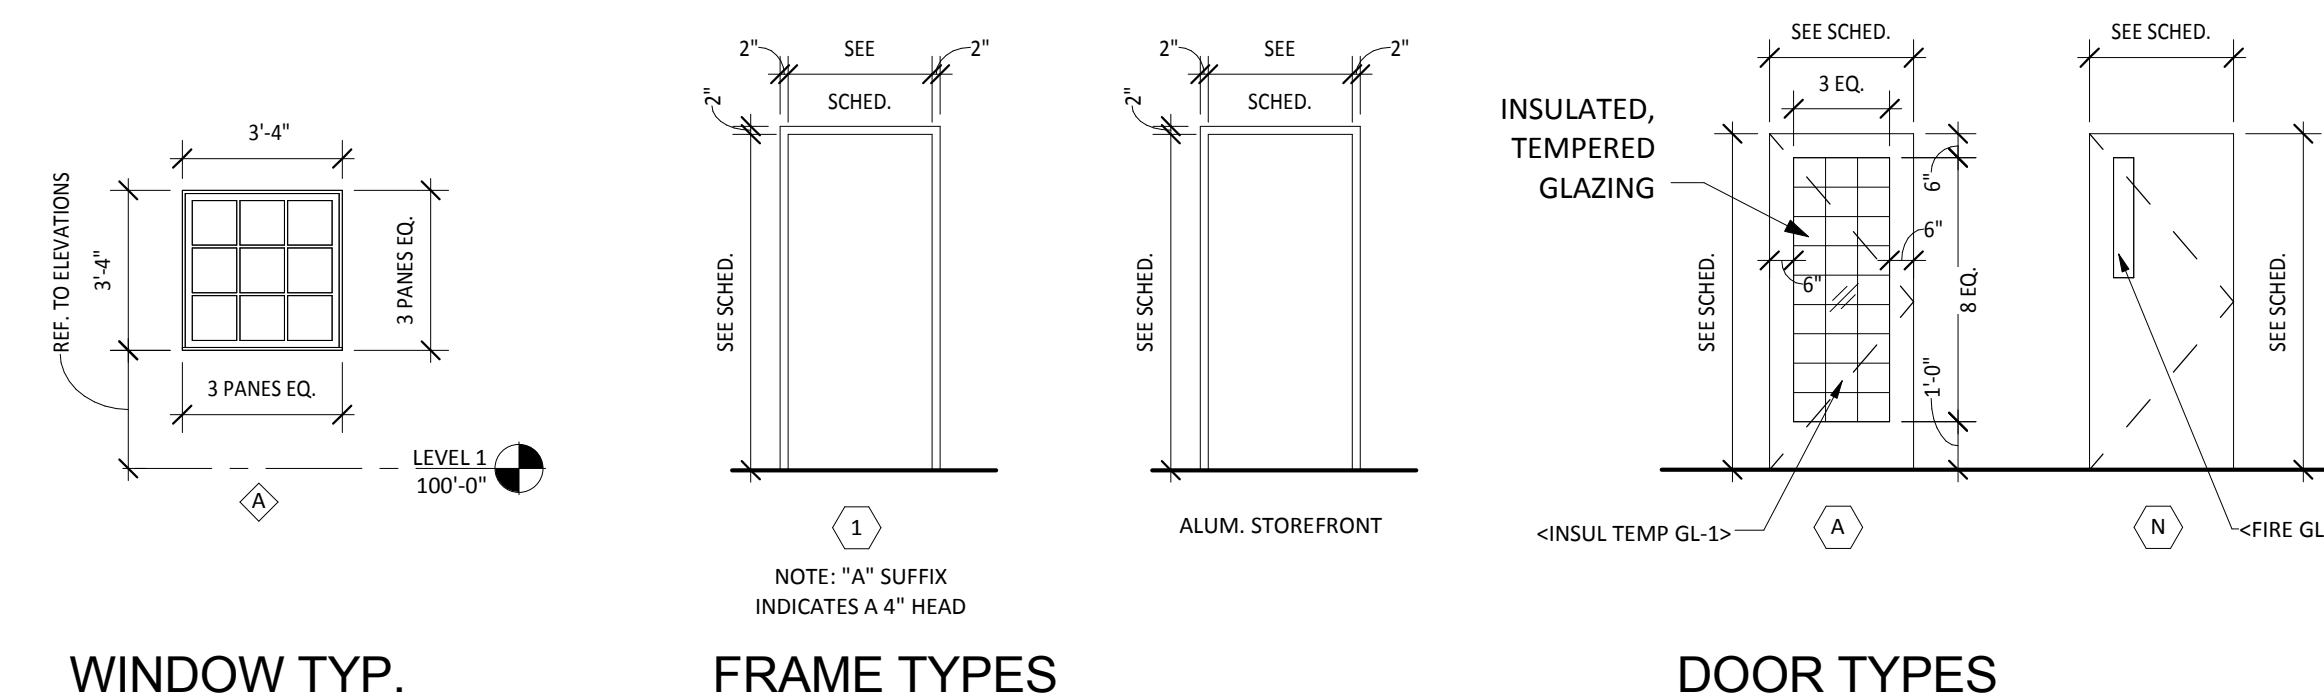


WINDOW TYP.

FRAME TYPES


DOOR TYPES

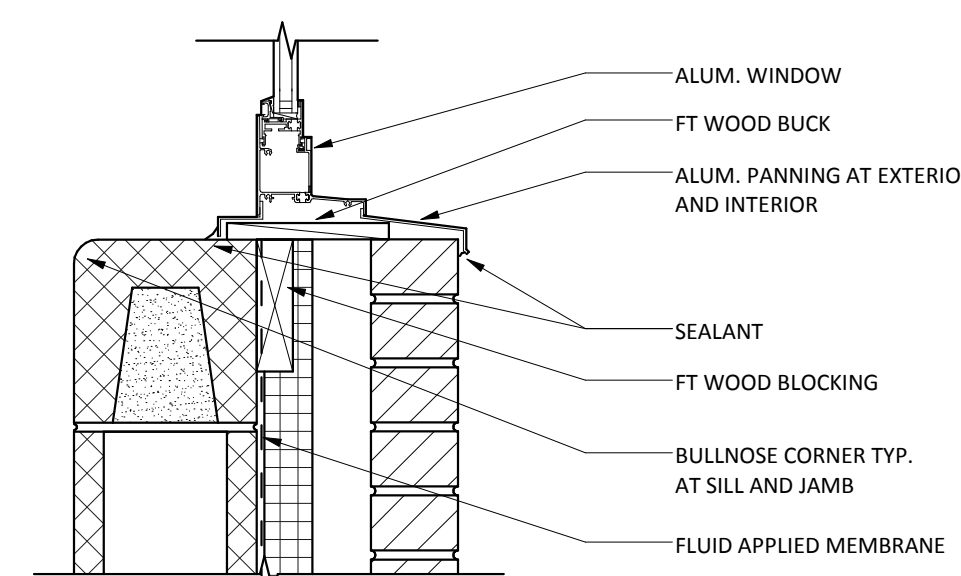


⑥ WINDOW SILL
1 1/2" = 1'-0"

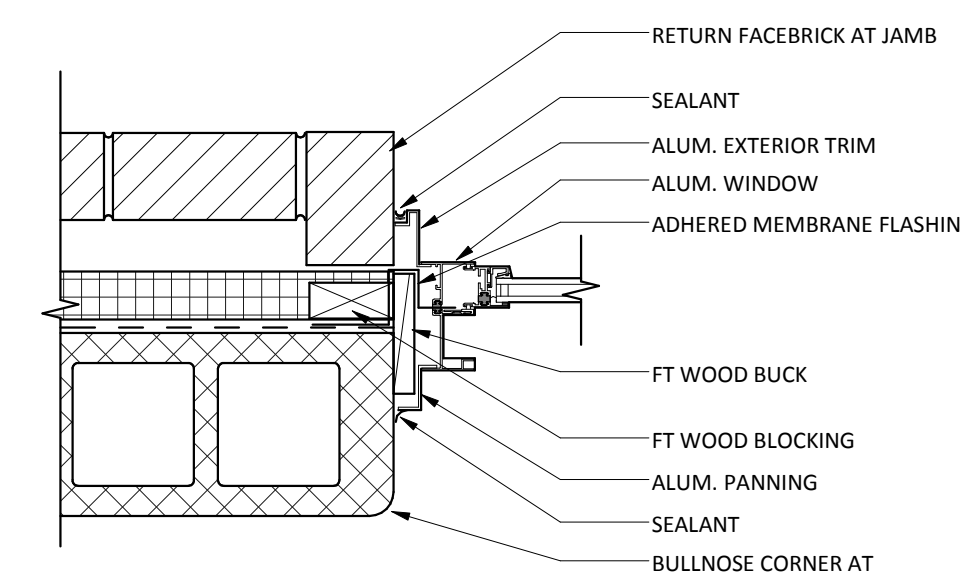


④ WINDOW JAMB
1 1/2" = 1'-0"

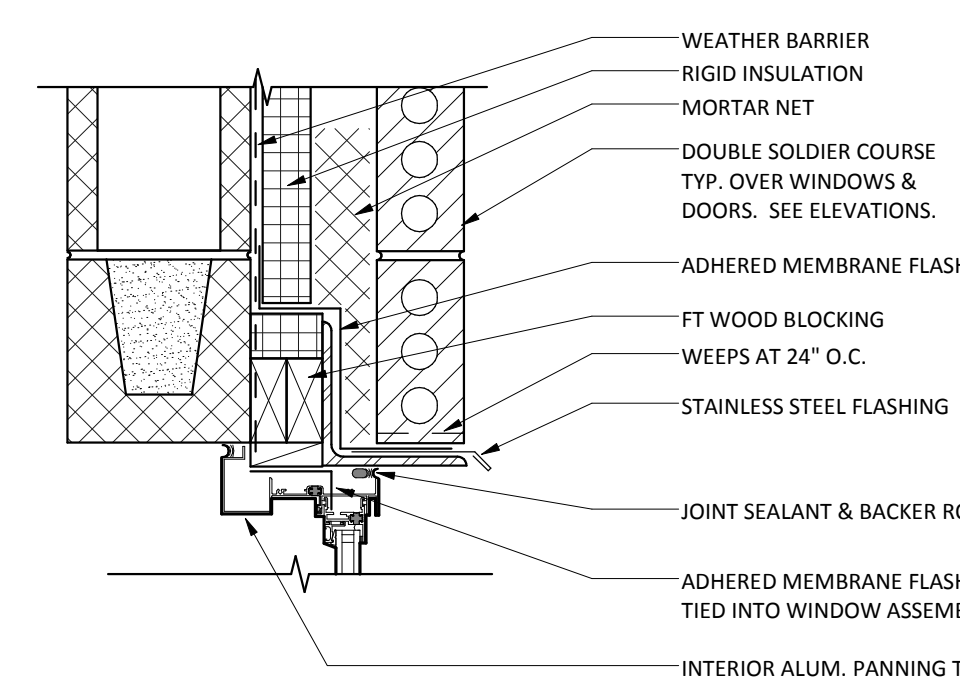


② WINDOW HEAD
1 1/2" = 1'-0"

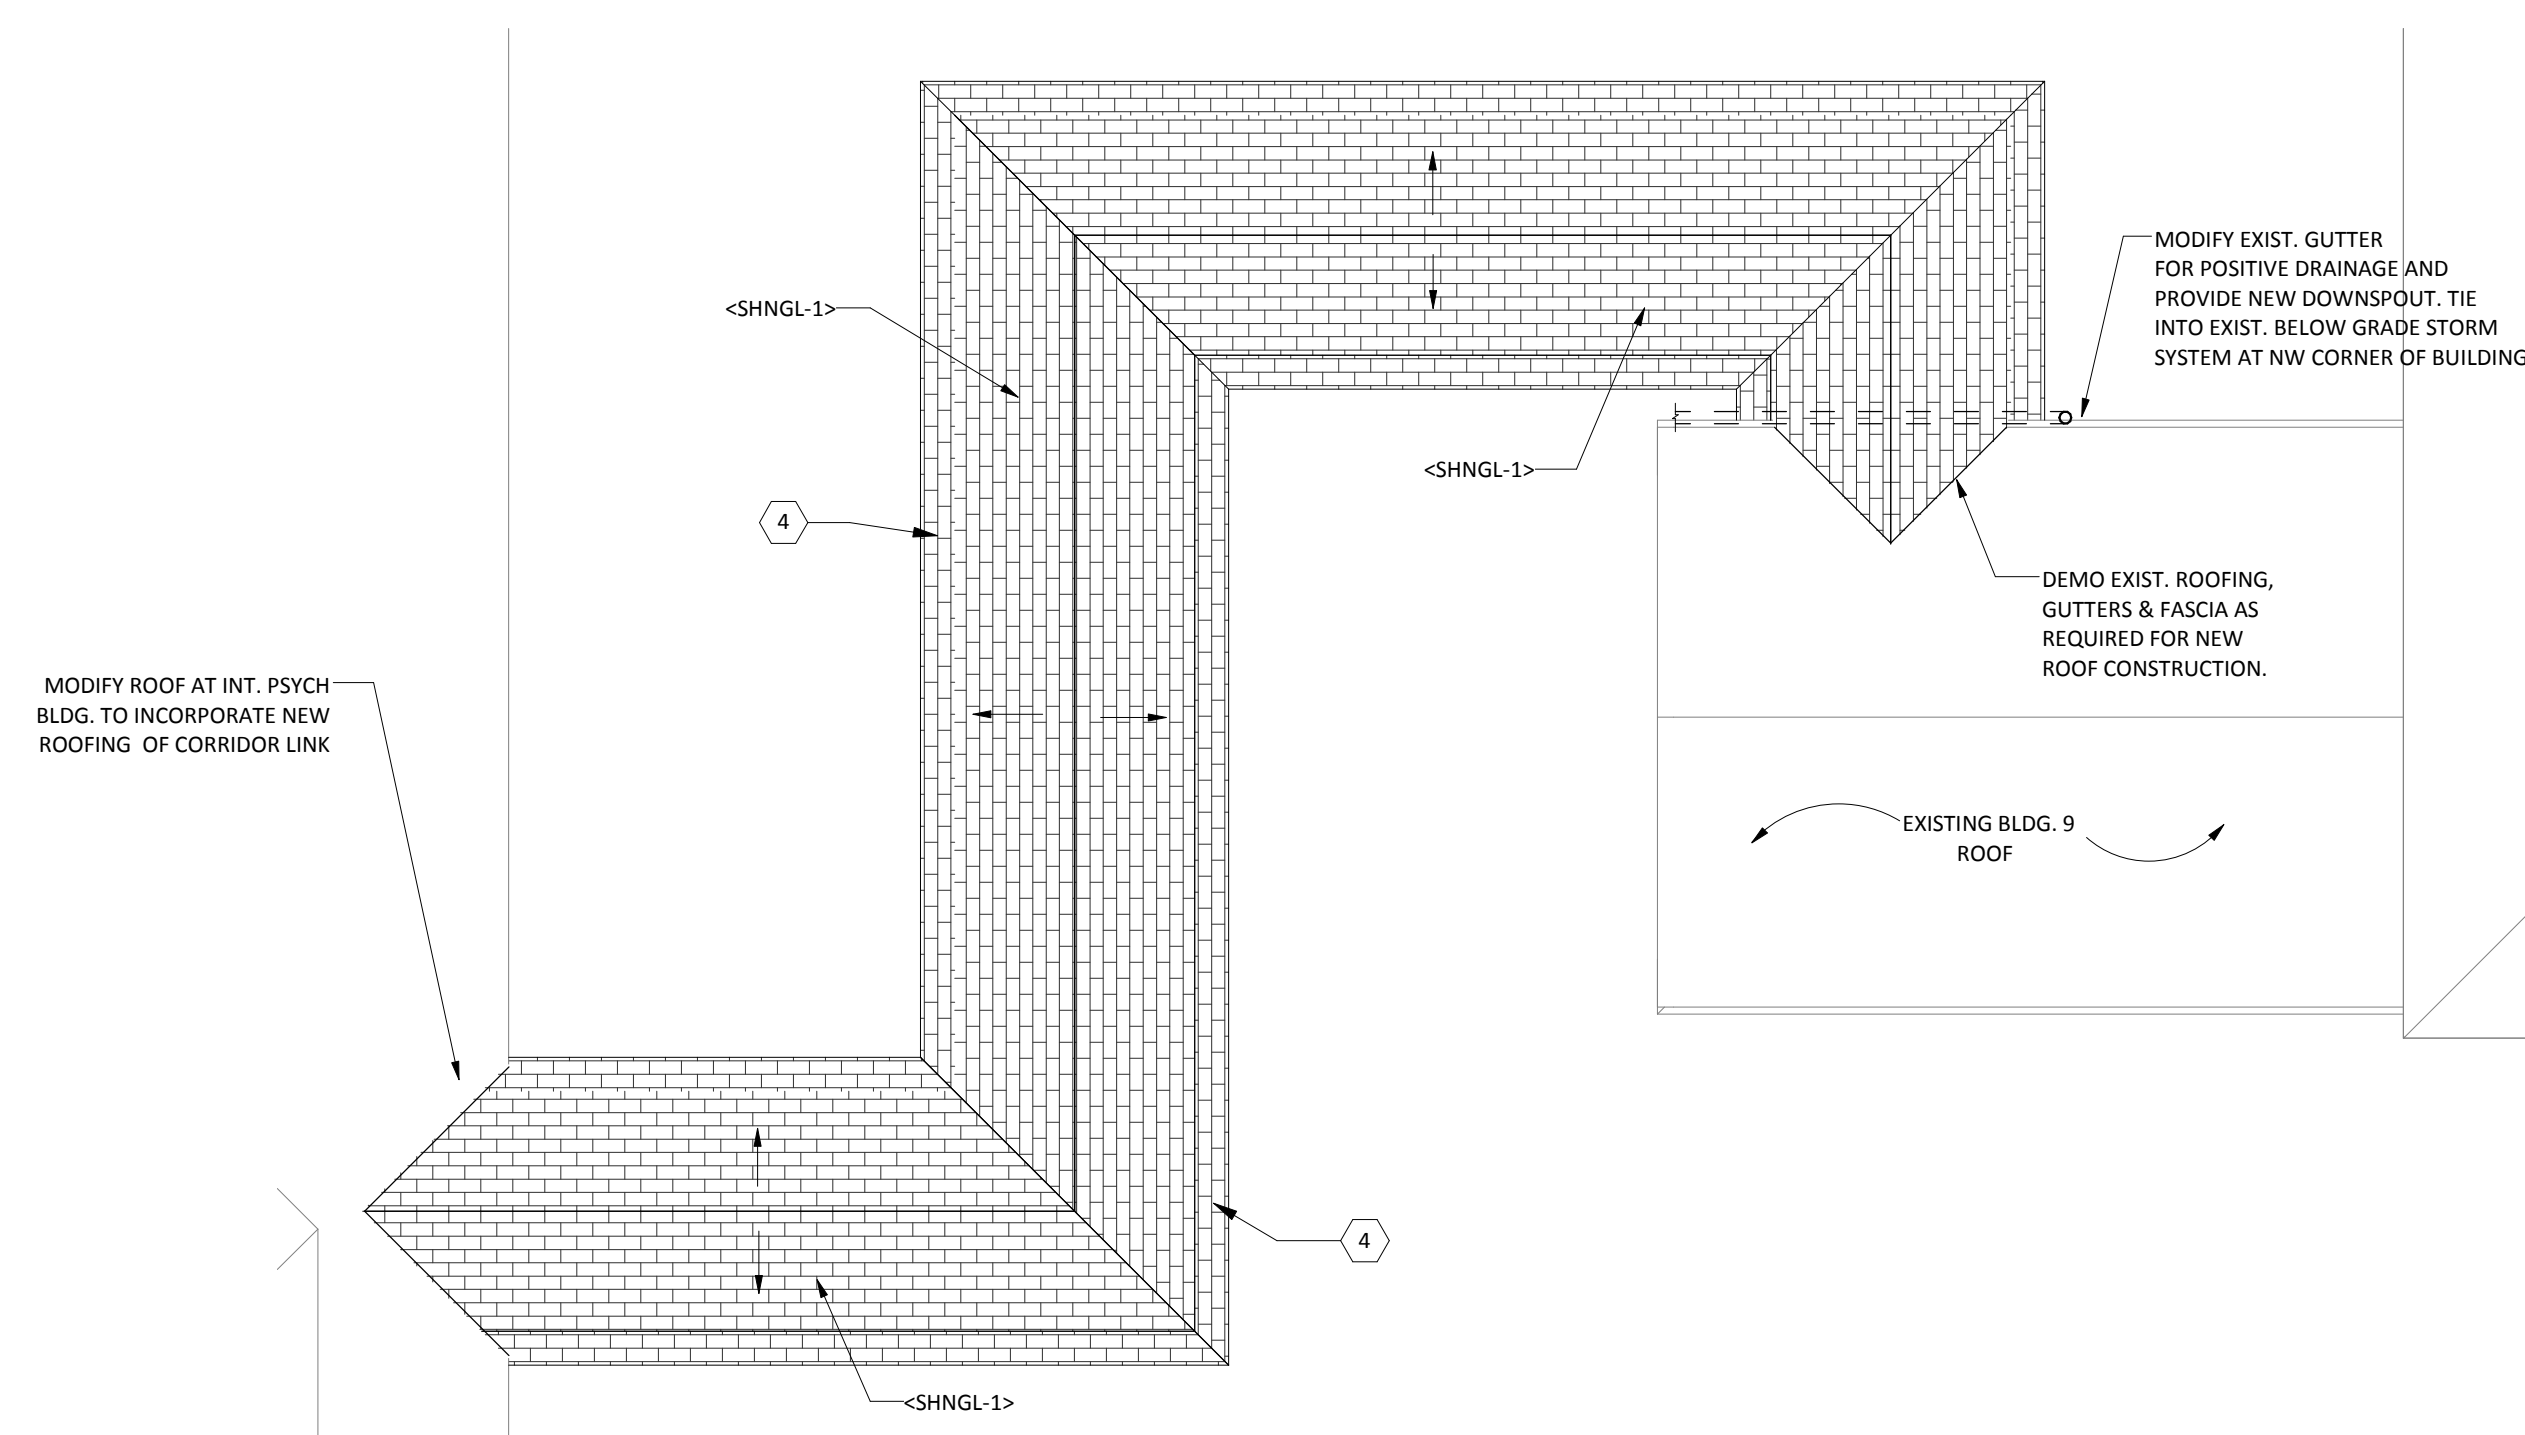


⑨ LINK ROOF PLAN
1/8" = 1'-0"

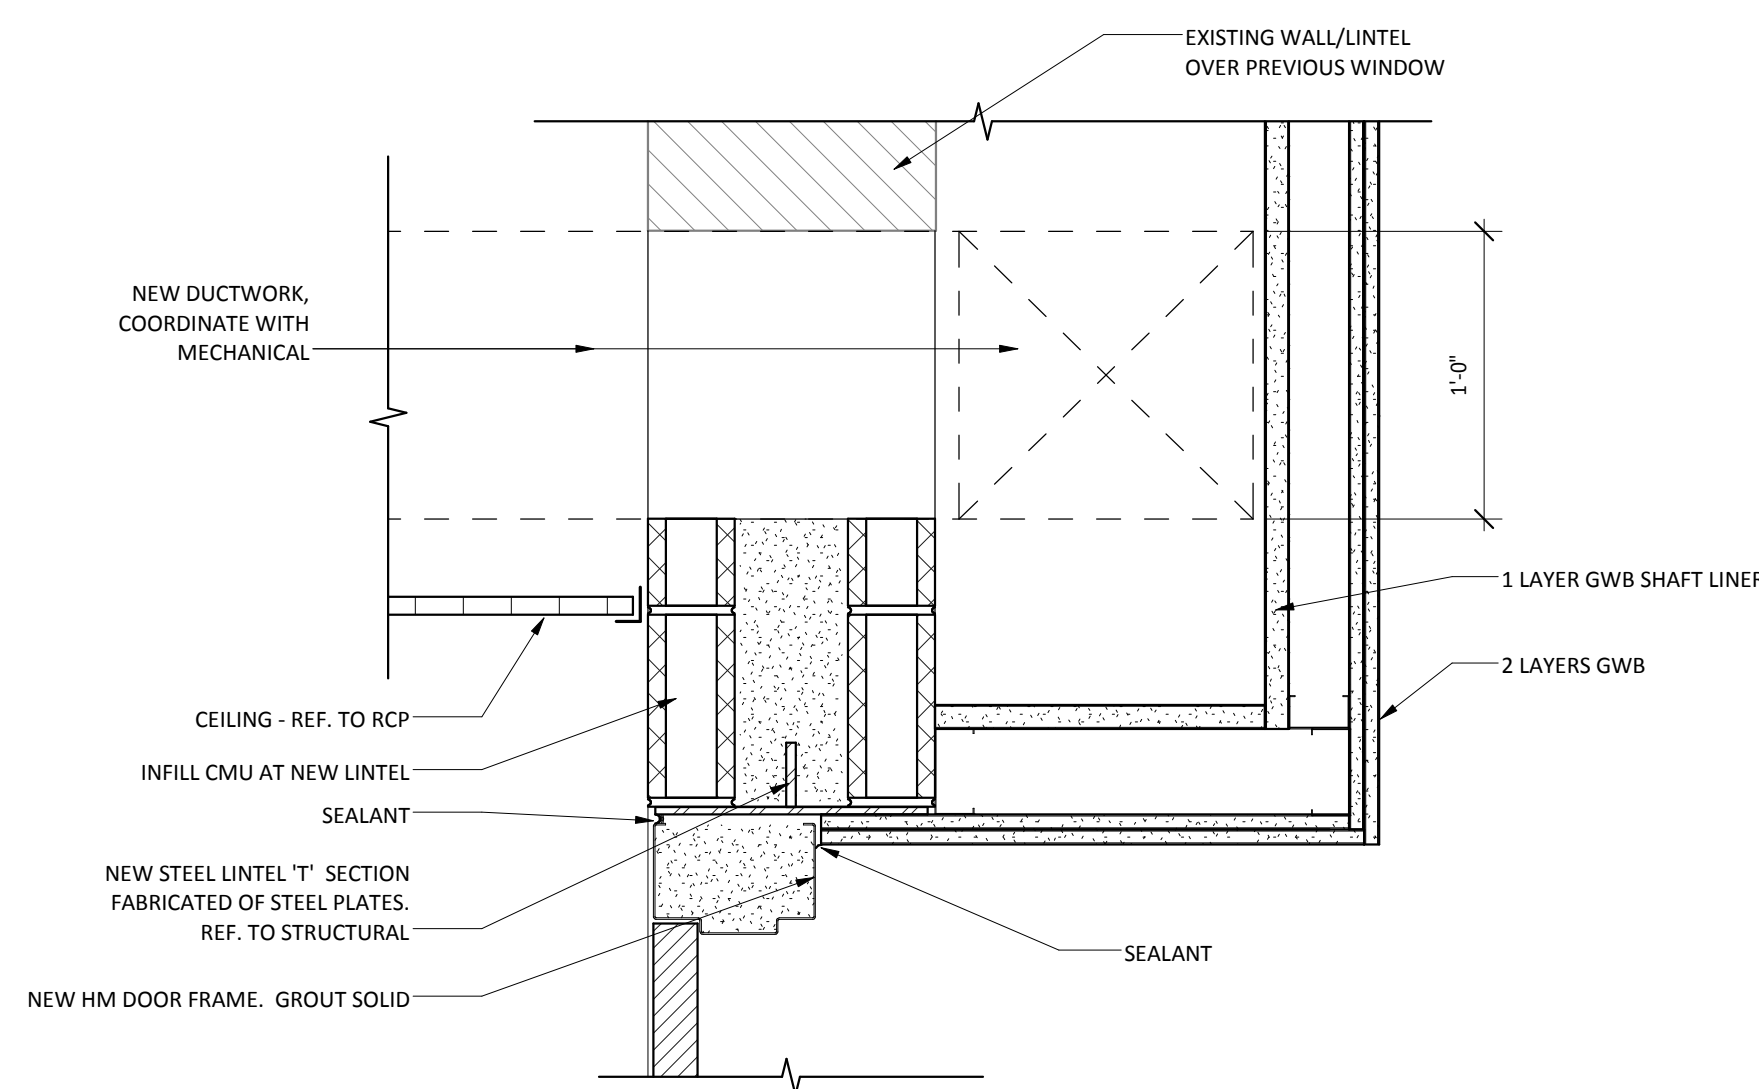

⑤ HEAD AT NEW HM DOOR
1 1/2" = 1'-0"

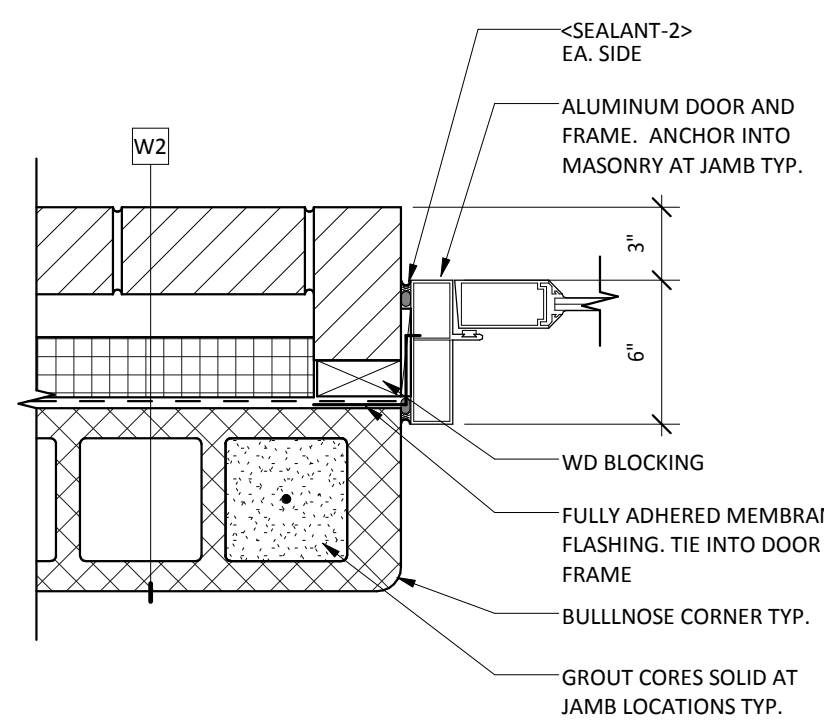


③ ALUMINUM DOOR JAMB
1 1/2" = 1'-0"

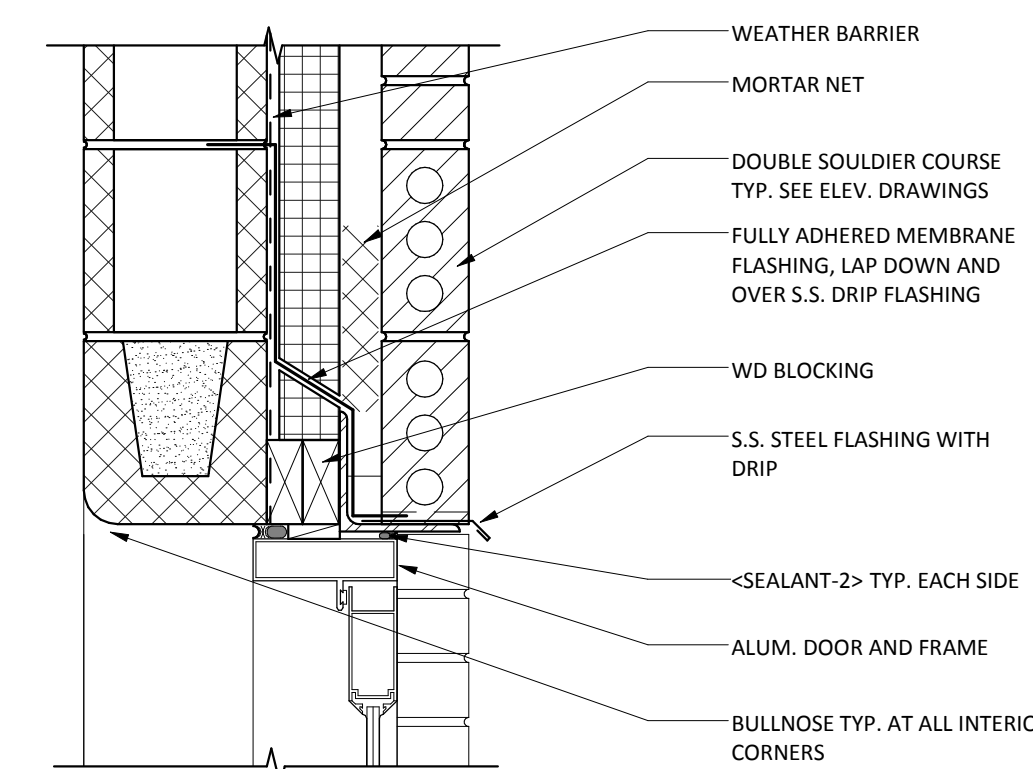

① ALUMINUM DOOR HEAD
1 1/2" = 1'-0"

three inches = one foot
one and one half inches = one foot
one inch = one foot
three quarters inch = one foot
one half inch = one foot
three eighths inch = one foot
one quarter inch = one foot
one eighth inch = one foot

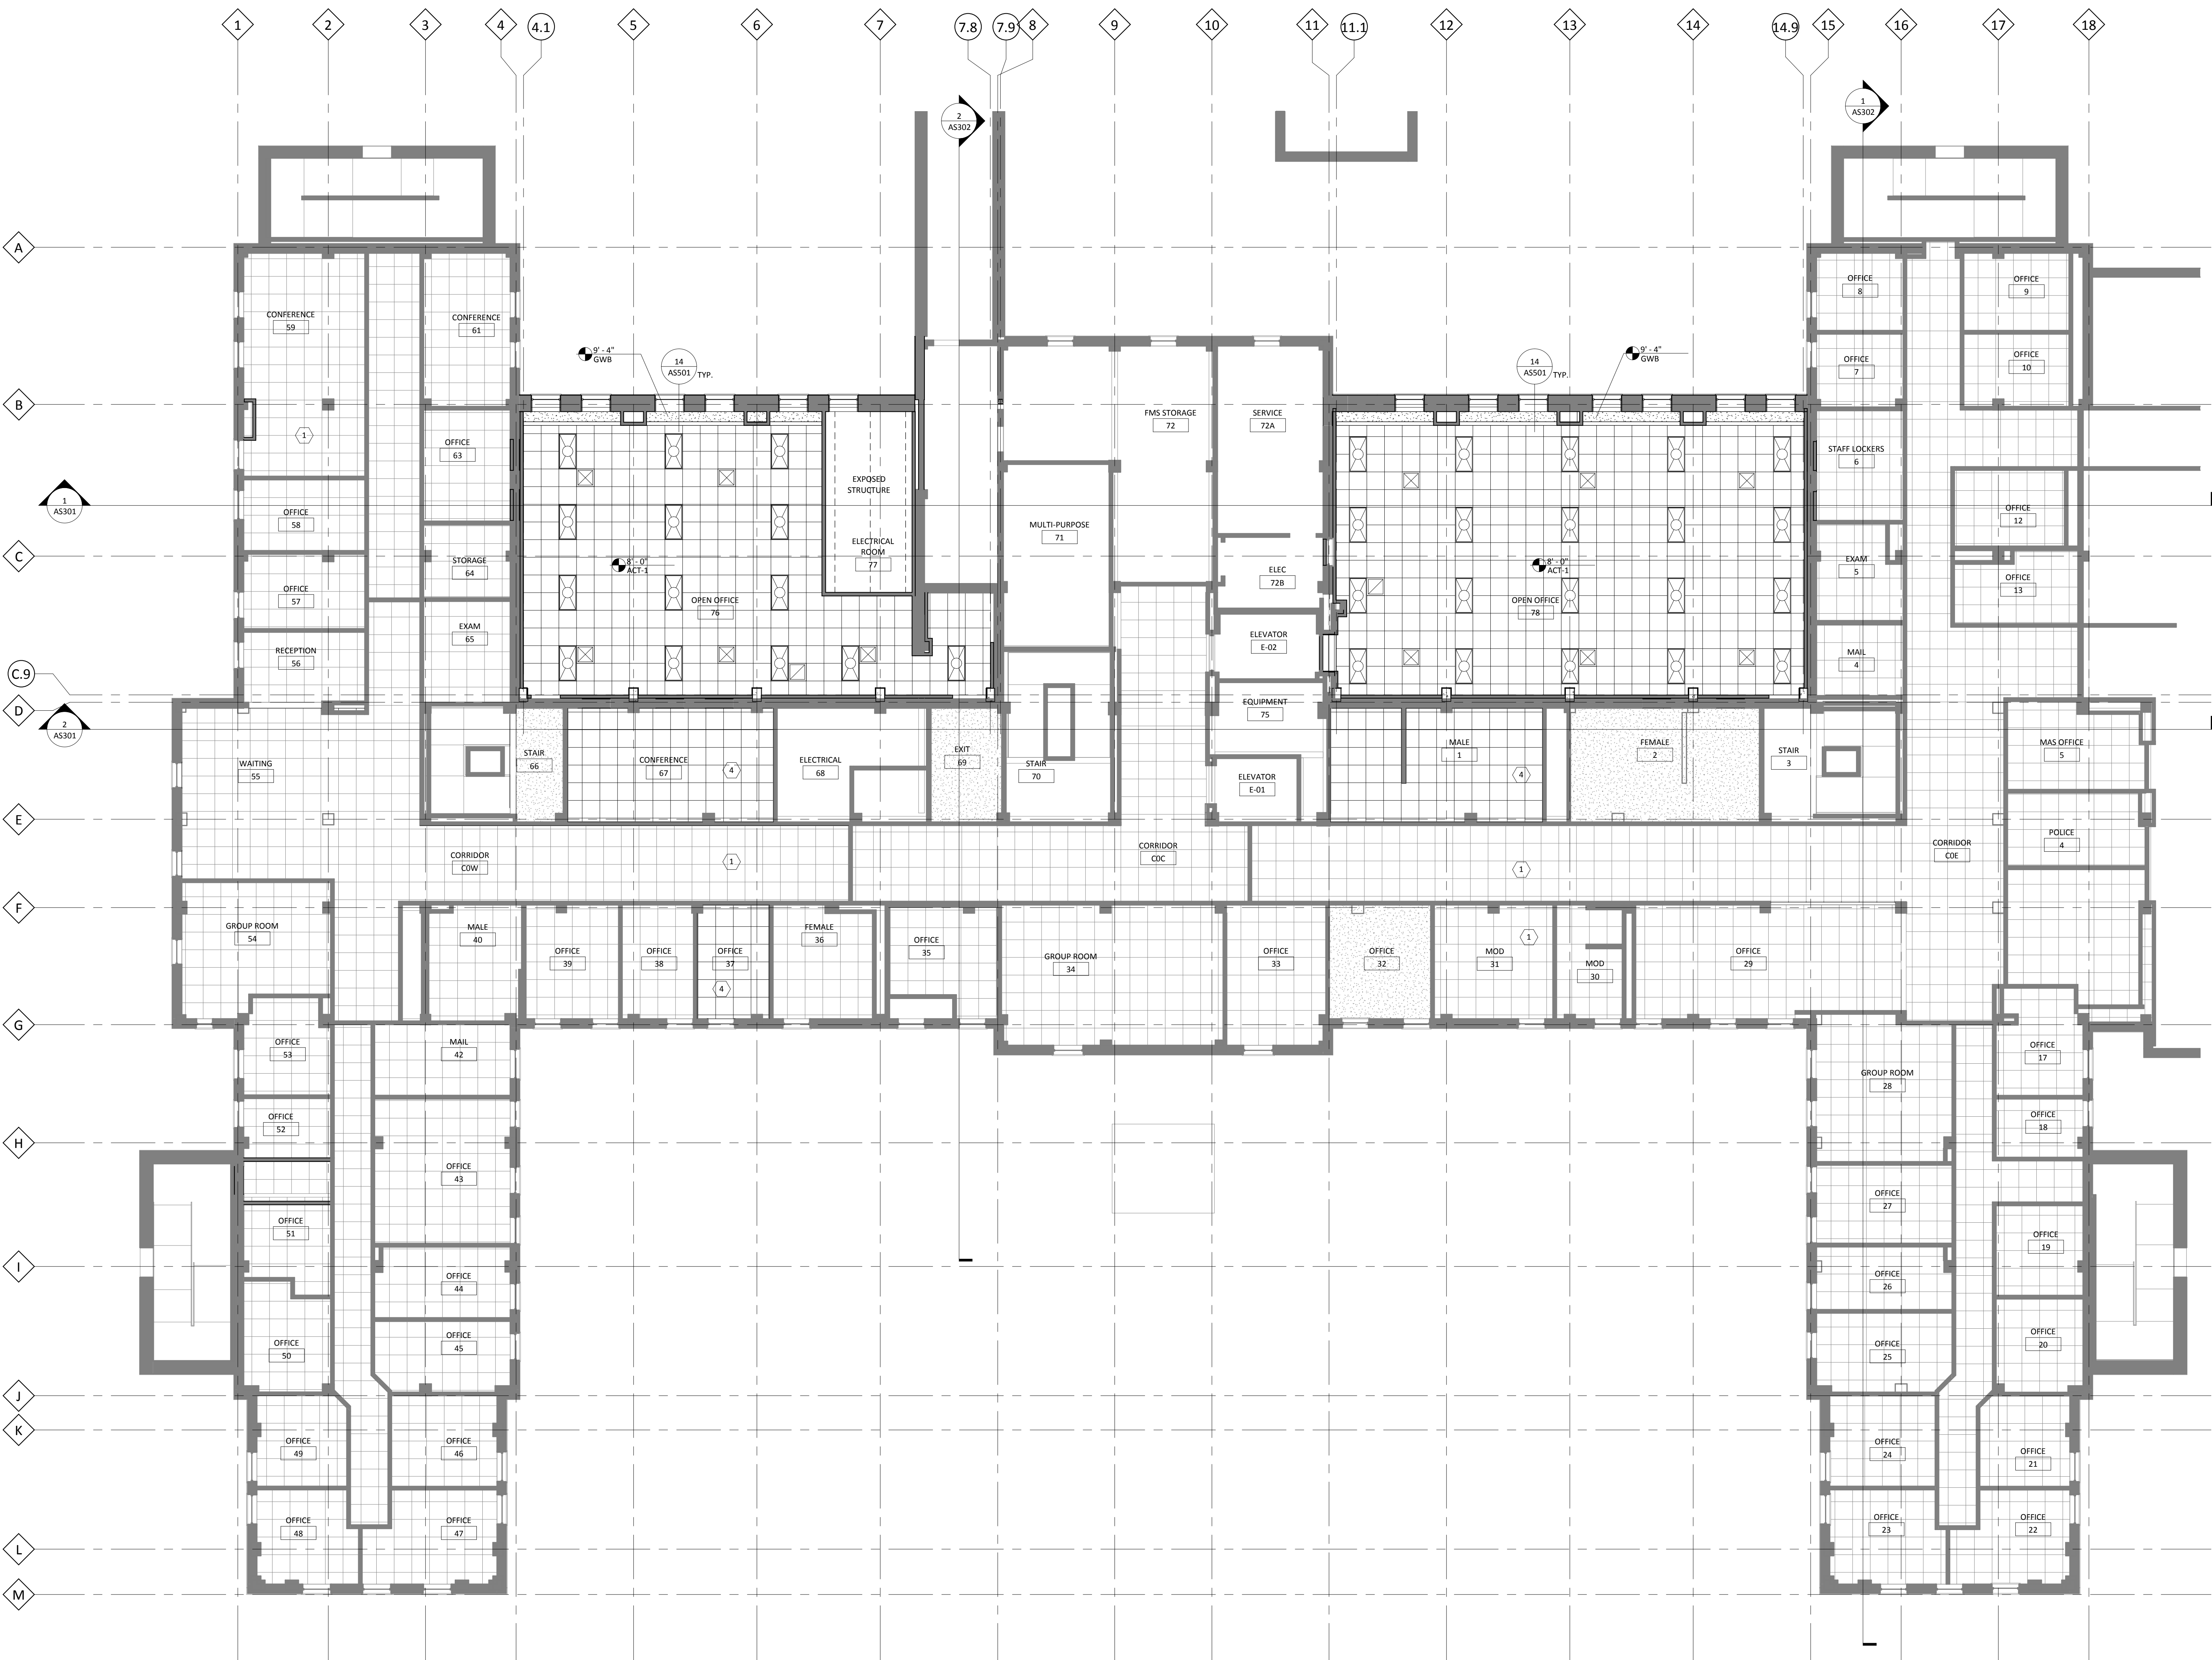

REFLECTED CEILING PLAN KEYNOTES	
NO.	NOTE
1	SALVAGE AND REINSTALL EXIST. ACT CEILING WHERE REQUIRED FOR NEW CONSTRUCTION. REPLACE ANY DAMAGED CEILING TILES TO MATCH EXIST.
2	NEW GWB CEILING INSTALLED TO MATCH ELEVATION OF DEMO'D CEILING. REINSTALL ALL ORIGINAL EXISTING EQUIPMENT, FIXTURES, ETC.
3	INSTALL NEW SLOPED GWB CEILING TO MATCH EXISTING PRIOR TO STAIR REMOVAL.
4	NEW ACT CEILING AT DEMOLOSHED GWB CEILING

RCP SYMBOL LEGEND

	ACOUSTICAL CEILING TILE - REF. TO MATERIAL LEGEND
	GYPSUM WALL BOARD CEILING - PAINTED <PT-1> U.N.O.
	TROFFER LIGHT FIXTURE
	TROFFER LIGHT FIXTURE
	RECESSED CAN LIGHT FIXTURE
	MECHANICAL SUPPLY DIFFUSER
	MECHANICAL RETURN GRILLE

CEILING PLAN GENERAL NOTES

- REFER TO FINISH LEGEND FOR CEILING MATERIAL, MANUFACTURER AND STYLE.
- REFER TO UNIT PLAN SHEETS FOR FURTHER INFORMATION ON PATIENT UNIT CEILINGS.
- PROVIDE MTL FRAMED GWB BULKHEADS WHERE CEILINGS OF DIFFERING ELEVATIONS ABUT.
- REFER TO MECHANICAL DRAWINGS FOR QUANTITY AND TYPE OF DIFFUSERS AND GRILLES. INSTALL IN CEILING WITH A CLEAN, TIGHT FIT.
- ENTIRE PROJECT IS SPRINKLERED. REFER TO FIRE PROTECTION PLANS FOR SYSTEM INFORMATION AND LOCATIONS.
- AT BASEMENT AND LEVEL 1 EXISTING CEILINGS, SALVAGE AND REPLACE ALL CEILINGS THAT ARE OBSTRUCTED BY MECHANICAL, ELECTRICAL OR FIRE PROTECTION WORK. MATCH PRE-EXISTING CONDITIONS U.N.O. PATCH EXIST. GWB CEILINGS AS REQUIRED.
- ALL EXISTING TO REMAIN GRILLES, DIFFUSERS, LIGHTS FIXTURES, ETC. TO BE CLEANED.
- VERIFY EXACT LOCATIONS OF SOFFIT AND CEILING CONTROL JOINTS WITH THE ARCHITECT'S REPRESENTATIVE IN THE FIELD.
- COORDINATE THE LOCATION OF ESCUTCHEON PLATES AT CEILING PANEL PENETRATIONS WITH ELECTRICAL AND MECHANICAL TRADES.
- SEE ELECTRICAL DRAWINGS FOR FIXTURE TYPES AND NIGHT LIGHT LOCATIONS.
- CONTRACTOR SHALL MAINTAIN THE FIRE RATING INTEGRITY OF ALL EXISTING PARTITIONS INDICATED AS FIRE RESISTANCE RATED. ADVISE THE ARCHITECT OF ANY PRE-EXISTING BREACHES DISCOVERED IN THE COURSE OF WORK.
- ALL TOILET ROOMS TO HAVE EXHAUST AIR. COORDINATE LOCATIONS WITH MECHANICAL DRAWINGS.

1 BASEMENT REFLECTED CEILING PLAN
1/8" = 1'-0"

NO.	REVISION	DATE



Alexandria
525 Broadway Street
Alexandria, MN 56308
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facsimile 320.759.9062
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STAMPED:
I hereby certify that this plan
was prepared by me or under my direct supervision and
that I am a duly Licensed Architect under
the laws of the State of Minnesota.

DANIEL J. MILLER, AIA
DATE: 12-20-2013
REG. NO. 14428

DRAWING TITLE
BASEMENT REFLECTED CEILING
PLAN

PROJECT TITLE
RECONFIGURE/EXPAND
BUILDINGS 28 & 9 FOR
RESIDENTIAL REHABILITATION
TREATMENT PROGRAM

BUILDING No. 28
DESIGNED BY DJM
DRAWN ADB
LOCATION
ST. CLOUD VA MEDICAL CENTER
ST. CLOUD, MN 56303


DATE 12.20.13
PLAT SCALE
PROJECT NO. 656-12-339
CADD FILE
DRAWING NO. AS700

100% CD SET

FOR
CONSTRUCTION



three inches = one foot
one and one half inches = one foot
one inch = one foot
three quarters inch = one foot
one half inch = one foot
three eighths inch = one foot
one quarter inch = one foot
one eighth inch = one foot

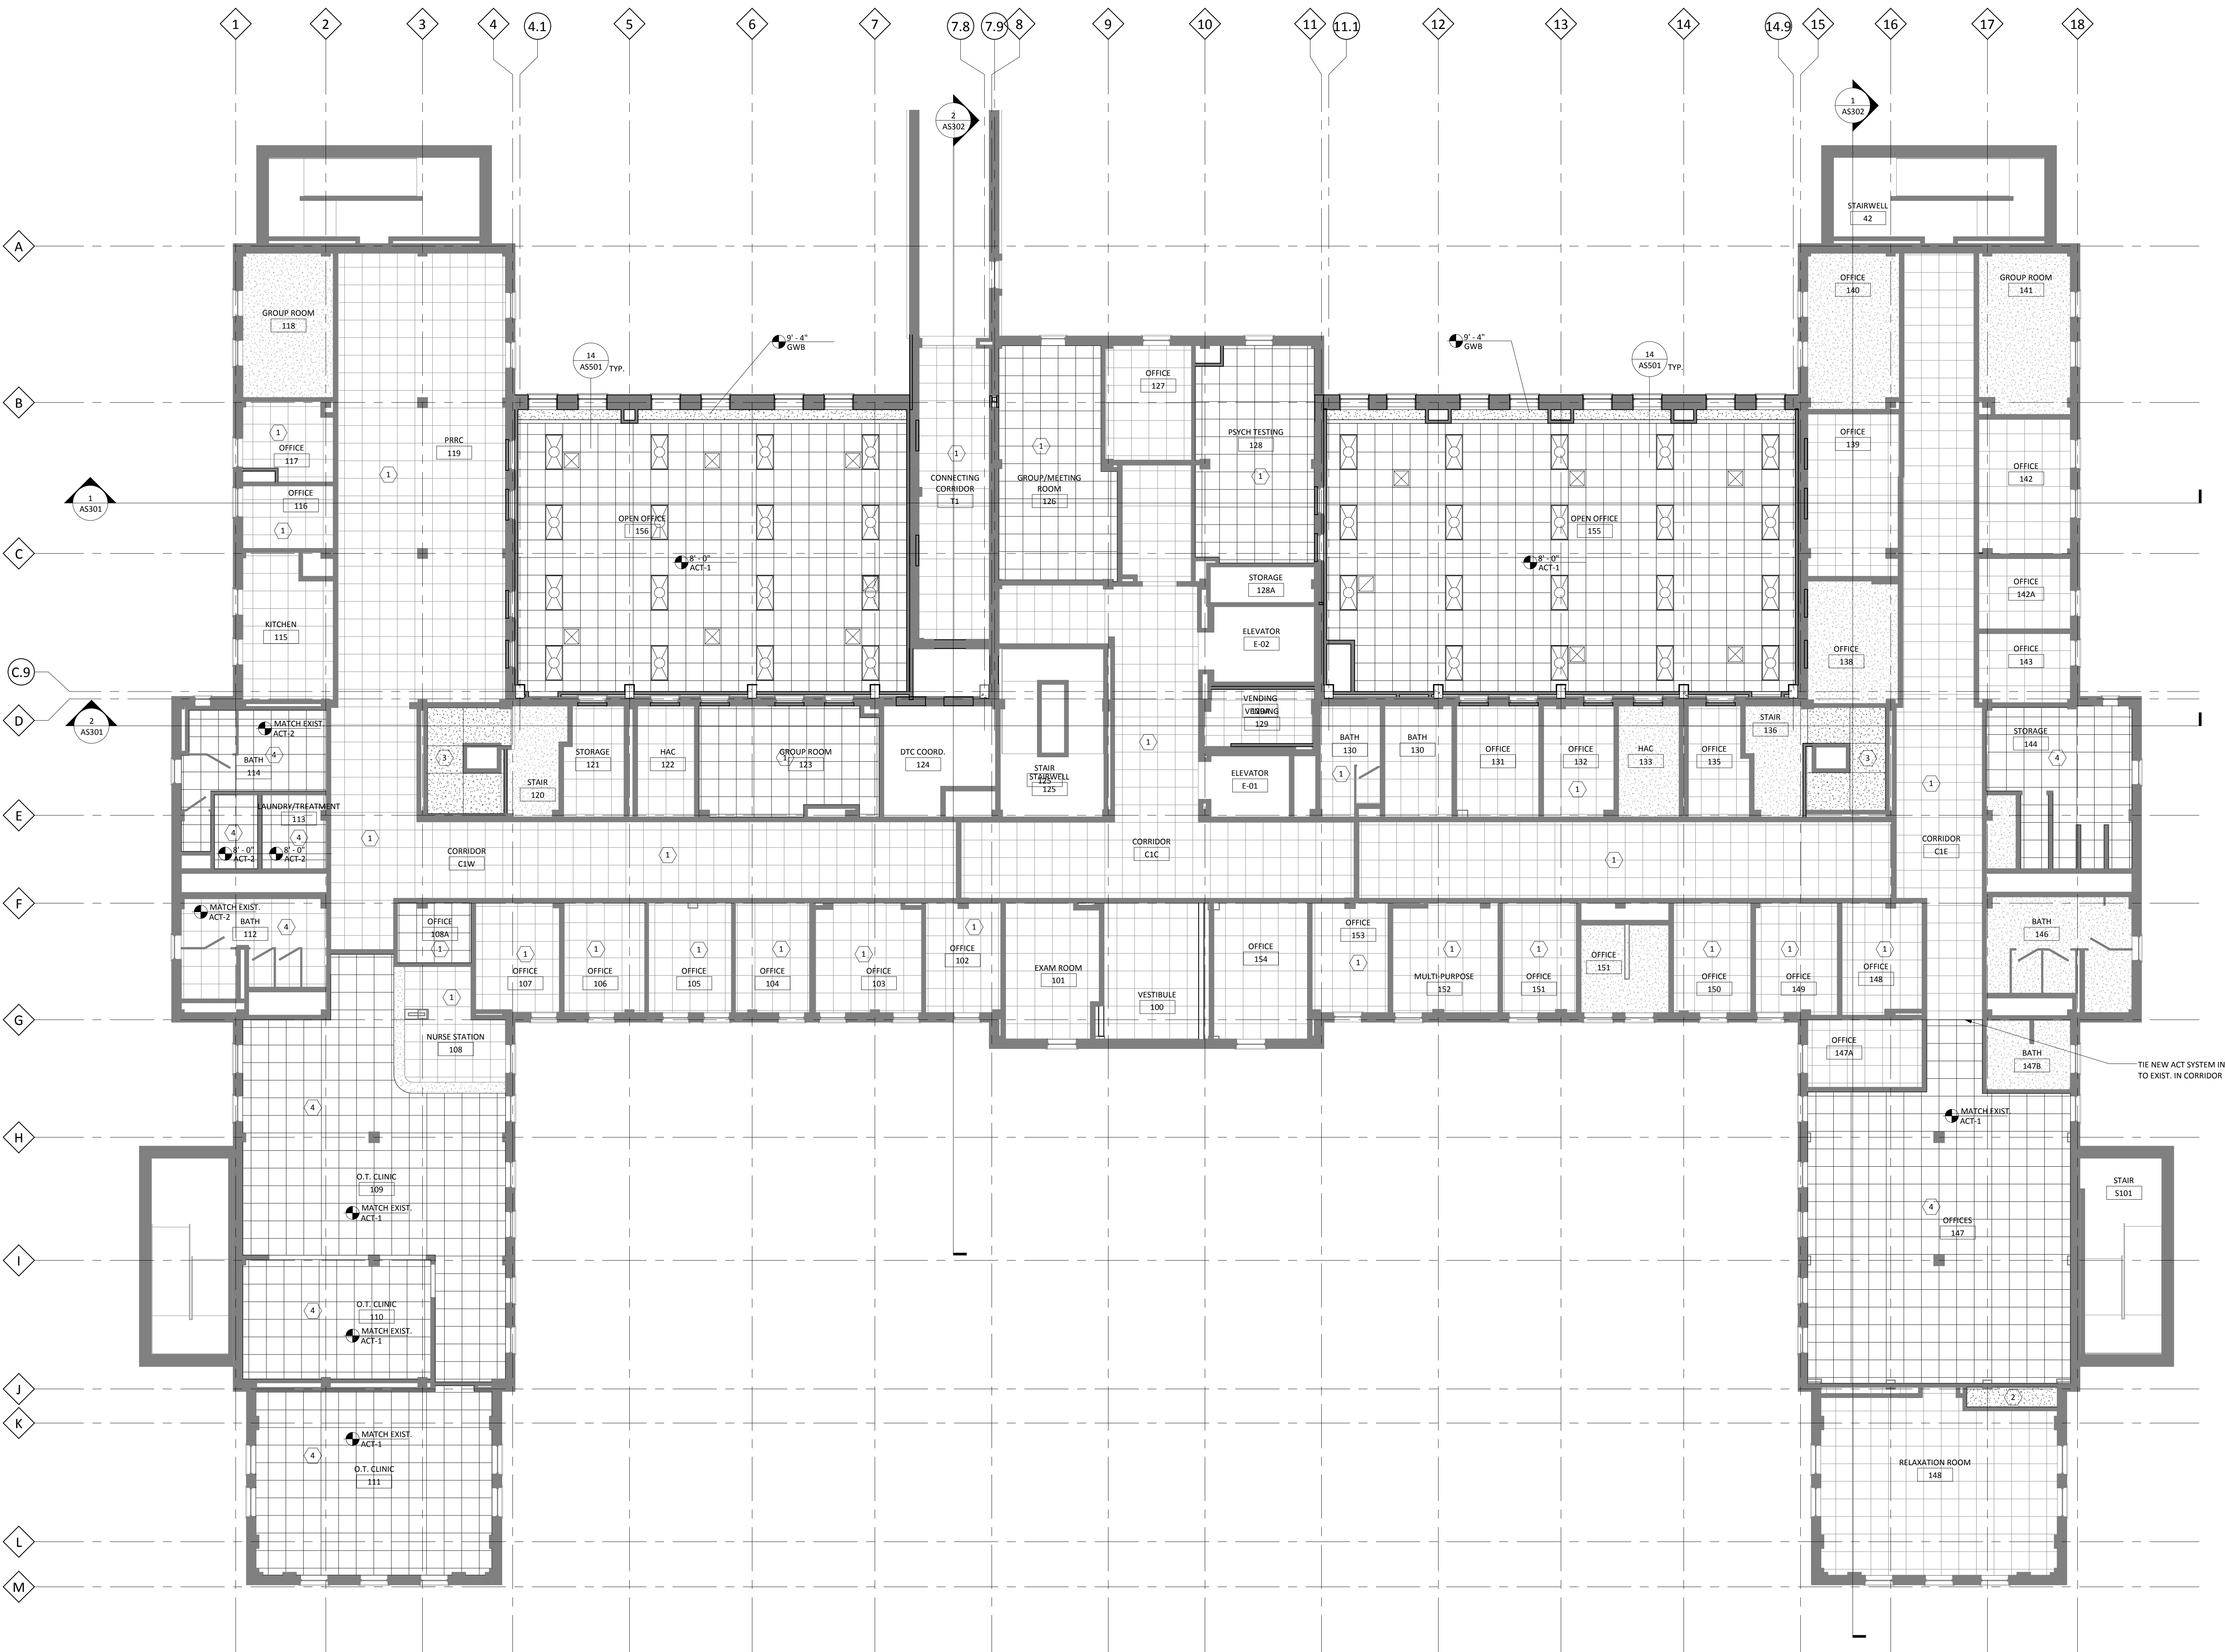

REFLECTED CEILING PLAN KEYNOTES	
NO	NOTE
1	SALVAGE AND REINSTALL EXIST. ACT CEILING WHERE REQUIRED FOR NEW CONSTRUCTION. REPLACE ANY DAMAGED CEILING TILES TO MATCH EXIST.
2	NEW GWB CEILING INSTALLED TO MATCH ELEVATION OF DEMO'D CEILING. REINSTALL ALL ORIGINAL EXISTING EQUIPMENT, FIXTURES, ETC.
3	INSTALL NEW SLOPED GWB CEILING TO MATCH EXISTING PRIOR TO STAIR REMOVAL.
4	NEW ACT CEILING AT DEMOLISHED GWB CEILING

RCP SYMBOL LEGEND	
	ACOUSTICAL CEILING TILE - REF. TO MATERIAL LEGEND
	GYPSUM WALL BOARD CEILING - PAINTED <PT-1> U.N.O.
	TROFFER LIGHT FIXTURE
	TROFFER LIGHT FIXTURE
	RECESSED CAN LIGHT FIXTURE
	MECHANICAL SUPPLY DIFFUSER
	MECHANICAL RETURN GRILLE

- CEILING PLAN GENERAL NOTES**
- A. REFER TO FINISH LEGEND FOR CEILING MATERIAL MANUFACTURER AND STYLE.
 - B. REFER TO UNIT PLAN SHEETS FOR FURTHER INFORMATION ON PATIENT UNIT CEILINGS.
 - C. PROVIDE MTL FRAMED GWB BULKHEADS WHERE CEILINGS OF DIFFERING ELEVATIONS ABUT.
 - D. REFER TO MECHANICAL DRAWINGS FOR QUANTITY AND TYPE OF DIFFUSERS AND GRILLES. INSTALL IN CEILING WITH A CLEAN, TIGHT FIT. ENTIRE PROJECT IS SPRINKLERED. REFER TO FIRE PROTECTION PLANS FOR SYSTEM INFORMATION AND LOCATIONS.
 - E. AT BASEMENT AND LEVEL 1 EXISTING CEILINGS, SALVAGE AND REPLACE ALL CEILINGS THAT ARE OBSTRUCTED BY MECHANICAL, ELECTRICAL, OR FIRE PROTECTION WORK. MATCH PRE-EXISTING CONDITIONS U.N.O.
 - F. PATCH EXIST. GWB CEILINGS AS REQUIRED.
 - G. ALL EXISTING TO REMAIN GRILLES, DIFFUSERS, LIGHTS FIXTURES, ETC. TO BE CLEANED.
 - H. VERIFY EXACT LOCATIONS OF SPLIT AND CEILING CONTROL JOINTS WITH THE ARCHITECT'S REPRESENTATIVE IN THE FIELD.
 - I. COORDINATE THE LOCATION OF ESCUTCHEON PLATES AT CEILING PANEL PENETRATIONS WITH ELECTRICAL AND MECHANICAL TRADES. SEE ELECTRICAL DRAWINGS FOR FUTURE TYPES AND NIGHT LIGHT LOCATIONS.
 - J. THE NEW ACT SYSTEM IN TO EXIST. IN CORRIDOR
 - K. ALL EXISTING PARTITIONS INDICATED AS FIRE RESISTANCE RATED. ADVISE THE ARCHITECT OF ANY PRE-EXISTING BREACHES DISCOVERED IN THE COURSE OF WORK.
 - L. ALL TOILET ROOMS TO HAVE EXHAUST AIR. COORDINATE LOCATIONS WITH MECHANICAL DRAWINGS.

1 FIRST FLOOR REFLECTED CEILING PLAN
1/8" = 1'-0"

NO	REVISION	DATE

VA FORM 08-6231



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facsimile 320.759.9062
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STAMPED:
DESIGNED BY: [Signature]
CHECKED BY: [Signature]
DATE: 12-20-2013
REV. NO.

DRAWING TITLE
FIRST FLOOR REFLECTED CEILING PLAN

PROJECT TITLE
RECONFIGURE/EXPAND BUILDINGS 28 & 9 FOR RESIDENTIAL REHABILITATION TREATMENT PROGRAM
BUILDING No: 28
DESIGNED BY: DJM
CHECKED BY: ADB
DRAWN BY: ADB
LOCATION: ST. CLOUD VA MEDICAL CENTER ST. CLOUD, MN 56303


DATE: 12.20.13
FILE NO.: AS NOTED
PROJECT NO.: 656-12-329
CADD FILE: AS701

100% CD SET

FOR CONSTRUCTION



three inches = one foot
one and one half inches = one foot
one inch = one foot
three quarters inch = one foot
one half inch = one foot
three eighths inch = one foot
one quarter inch = one foot
one eighth inch = one foot

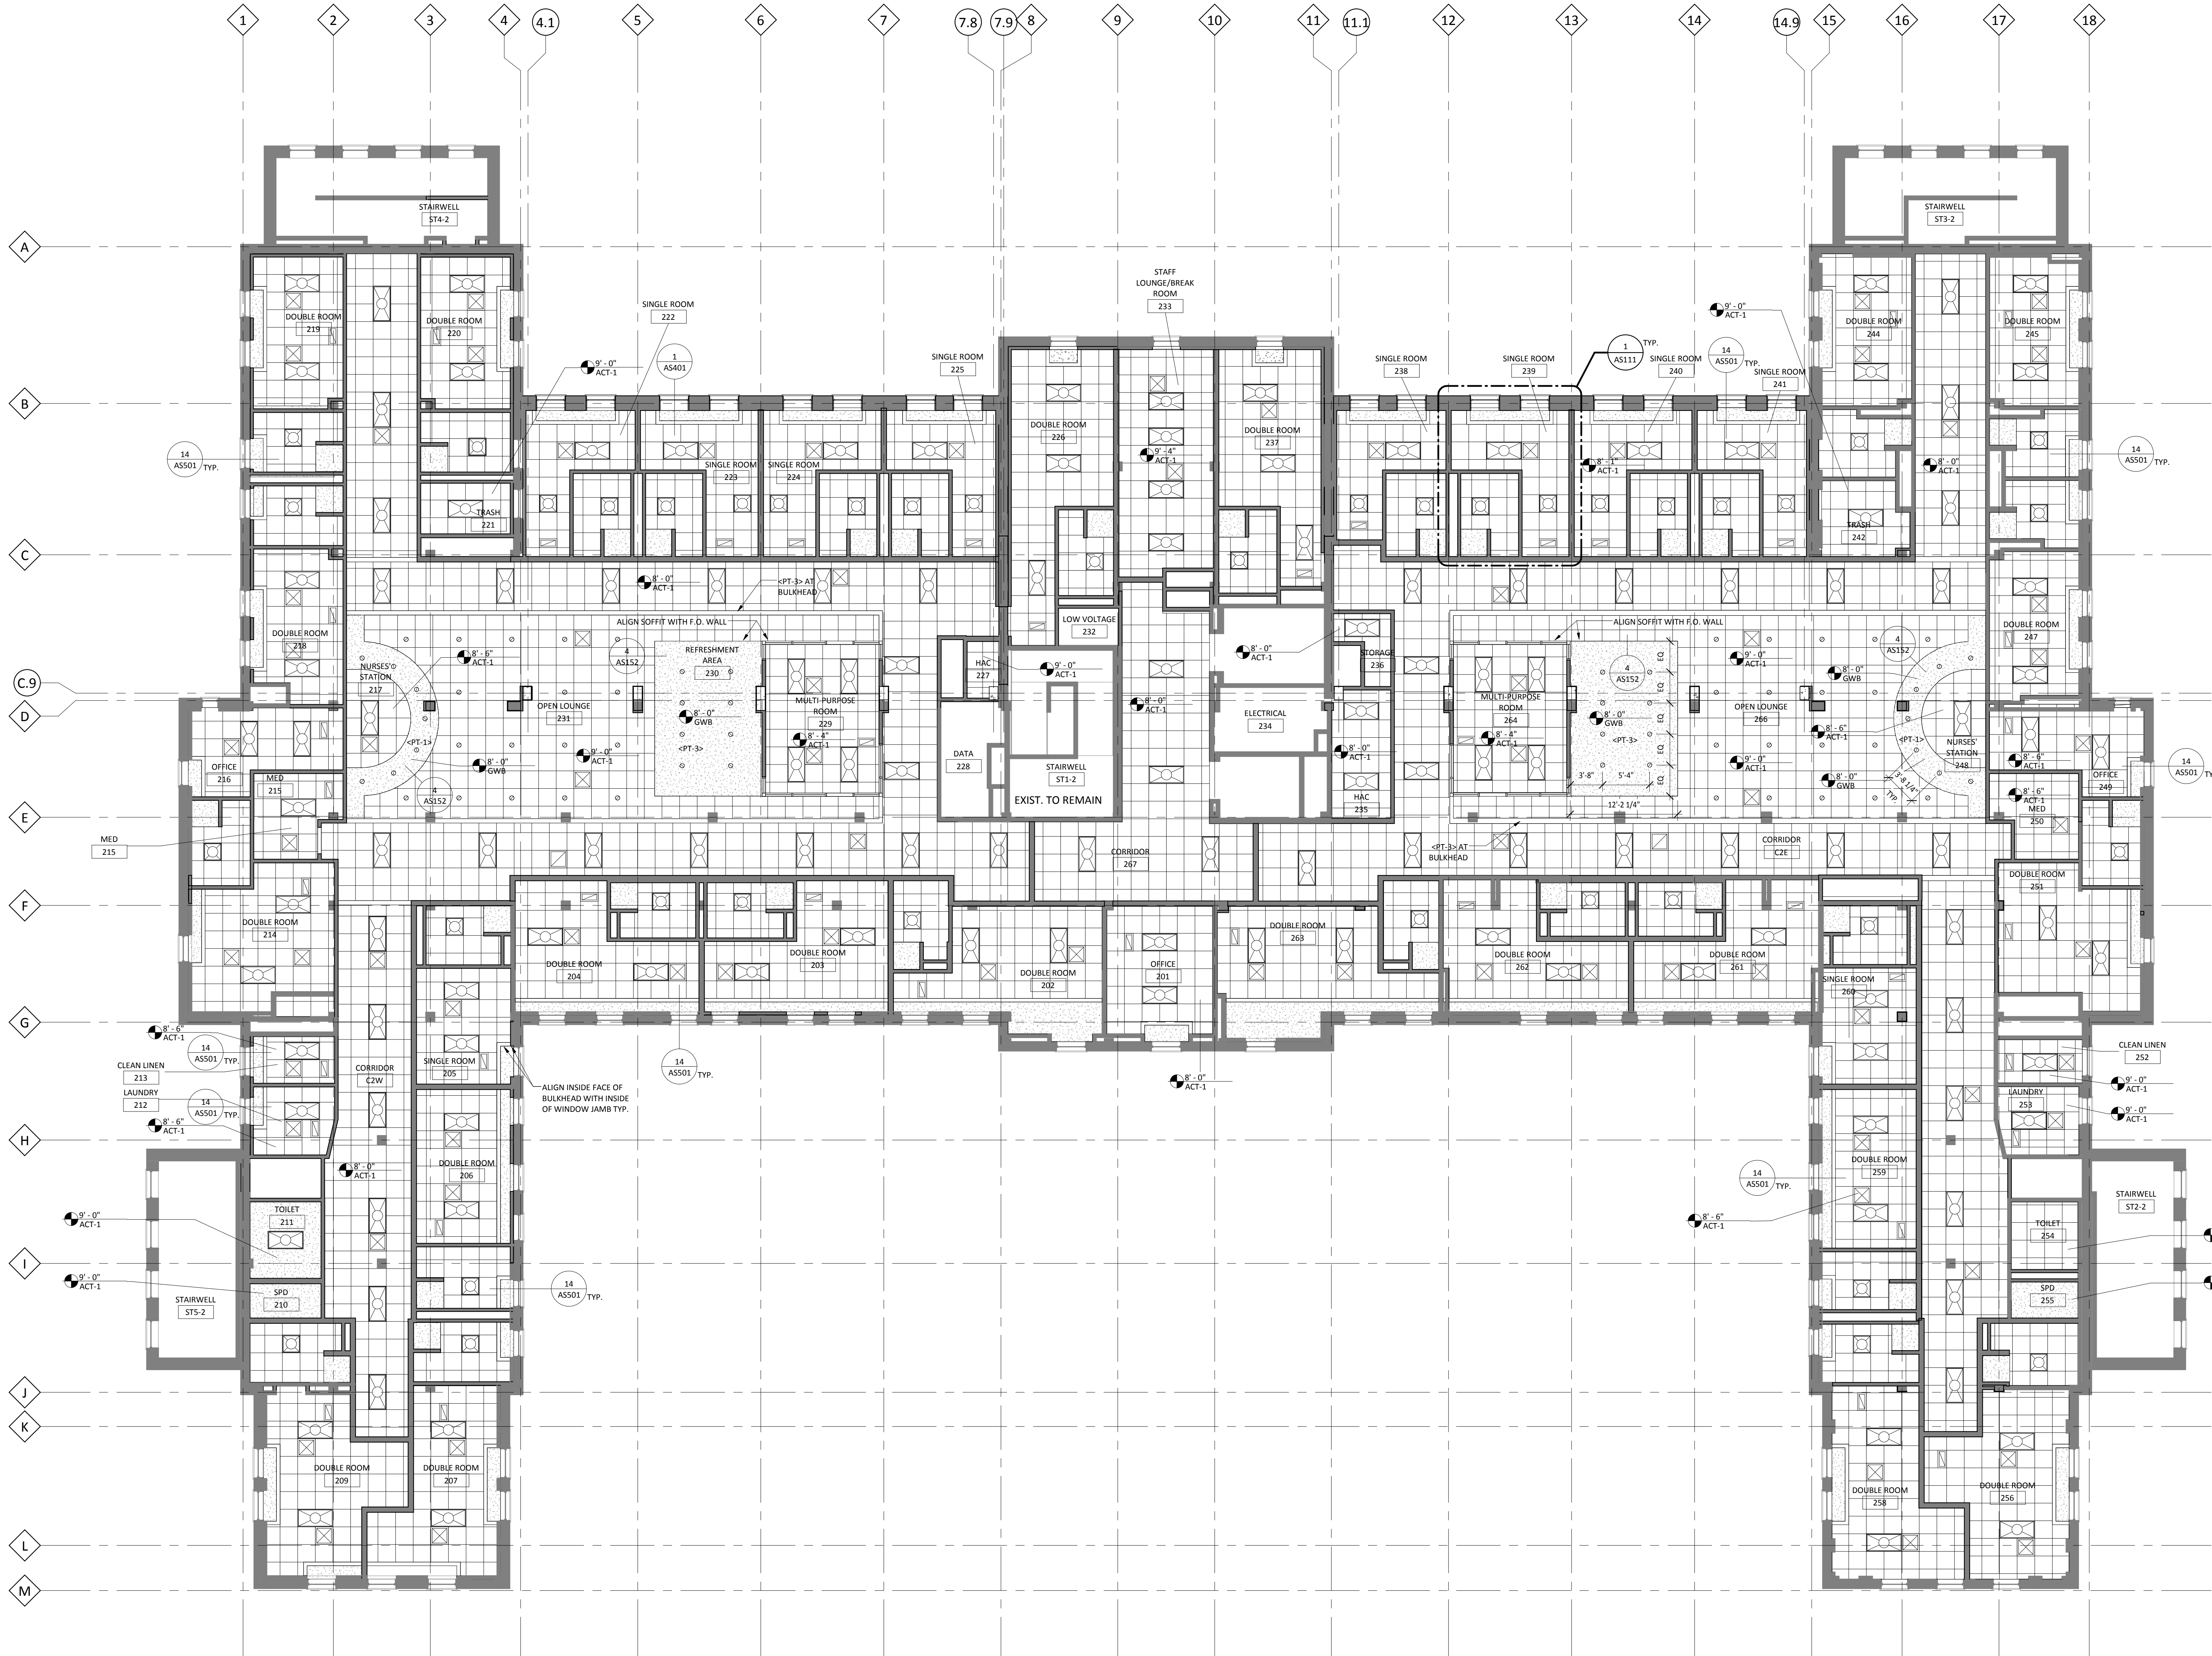

RCP SYMBOL LEGEND


- ACOUSTICAL CEILING TILE - REF. TO MATERIAL LEGEND
- GYPSON WALL BOARD CEILING - PAINTED <PT-1> U.N.O.
- TROFFER LIGHT FIXTURE
- TROFFER LIGHT FIXTURE
- RECESSED CAN LIGHT FIXTURE
- MECHANICAL SUPPLY DIFFUSER
- MECHANICAL RETURN GRILLE

- CEILING PLAN GENERAL NOTES**
- REFER TO FINISH LEGEND FOR CEILING MATERIAL MANUFACTURER AND STYLE.
 - REFER TO UNIT PLAN SHEETS FOR FURTHER INFORMATION ON PATIENT UNIT CEILING.
 - PROVIDE MTL FRAMED GWB BULKHEADS WHERE CEILING OF DIFFERING ELEVATIONS ABUT.
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 - AT BASEMENT AND LEVEL 1 EXISTING CEILING, SALVAGE AND REPLACE ALL CEILING THAT ARE OBSTRUCTED BY MECHANICAL, ELECTRICAL, OR FIRE PROTECTION WORK. MATCH PRE-EXISTING CONDITIONS U.N.O. PATCH EXIST. GWB CEILING AS REQUIRED.
 - ALL EXISTING TO REMAIN GRILLES, DIFFUSERS, LIGHTS FIXTURES, ETC. TO BE CLEANED.
 - VERIFY EXACT LOCATIONS OF SOFFIT AND CEILING CONTROL JOINTS WITH THE ARCHITECTS REPRESENTATIVE IN THE FIELD.
 - COORDINATE THE LOCATION OF ESCUTCHEON PLATES AT CEILING PANEL PENETRATIONS WITH ELECTRICAL AND MECHANICAL TRADES. SEE ELECTRICAL DRAWINGS FOR FIXTURE TYPES AND NIGHT LIGHT LOCATIONS.
 - CONTRACTOR SHALL MAINTAIN THE FIRE RATING INTEGRITY OF ALL EXISTING PARTITIONS INDICATED AS FIRE RESISTANCE RATED. ADVISE THE ARCHITECT OF ANY PRE-EXISTING BREACHES DISCOVERED IN THE COURSE OF WORK.
 - ALL TOILET ROOMS TO HAVE EXHAUST AIR. COORDINATE LOCATIONS WITH MECHANICAL DRAWINGS.

1 SECOND FLOOR REFLECTED CEILING PLAN
1/8" = 1'-0"

NO.	REVISION	DATE

VA FORM 05-6231

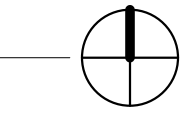

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Alexandria, MN 56308
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STAMPED:
I HAVE REVIEWED THIS PLAN
AND I CERTIFY THAT THE PLAN
REPRESENTS THE DESIGN AND
CONSTRUCTION OF THE PROJECT
AND THAT I AM A LICENSED ARCHITECT
UNDER THE LAWS OF THE STATE OF MINNESOTA.
DANIEL J. MILLER, AIA
DATE: 12-20-2013
REG. NO. 14-0819

DRAWING TITLE
SECOND FLOOR REFLECTED
CEILING PLAN

PROJECT TITLE
RECONFIGURE/EXPAND
BUILDINGS 28 & 9 FOR
RESIDENTIAL REHABILITATION
TREATMENT PROGRAM


BUILDING No. 28
CHECKED BY DJM
DRAWN ADB
LOCATION
ST. CLOUD VA MEDICAL CENTER
ST. CLOUD, MN 56303

DATE 12.20.13
FILE SCALE AS NOTED
PROJECT NO. 656-12-329
CADD FILE
DRAWING NO. AS702


100% CD SET

FOR CONSTRUCTION



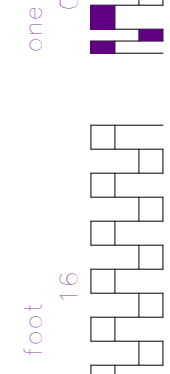

**FOR
CONSTRUCTION**

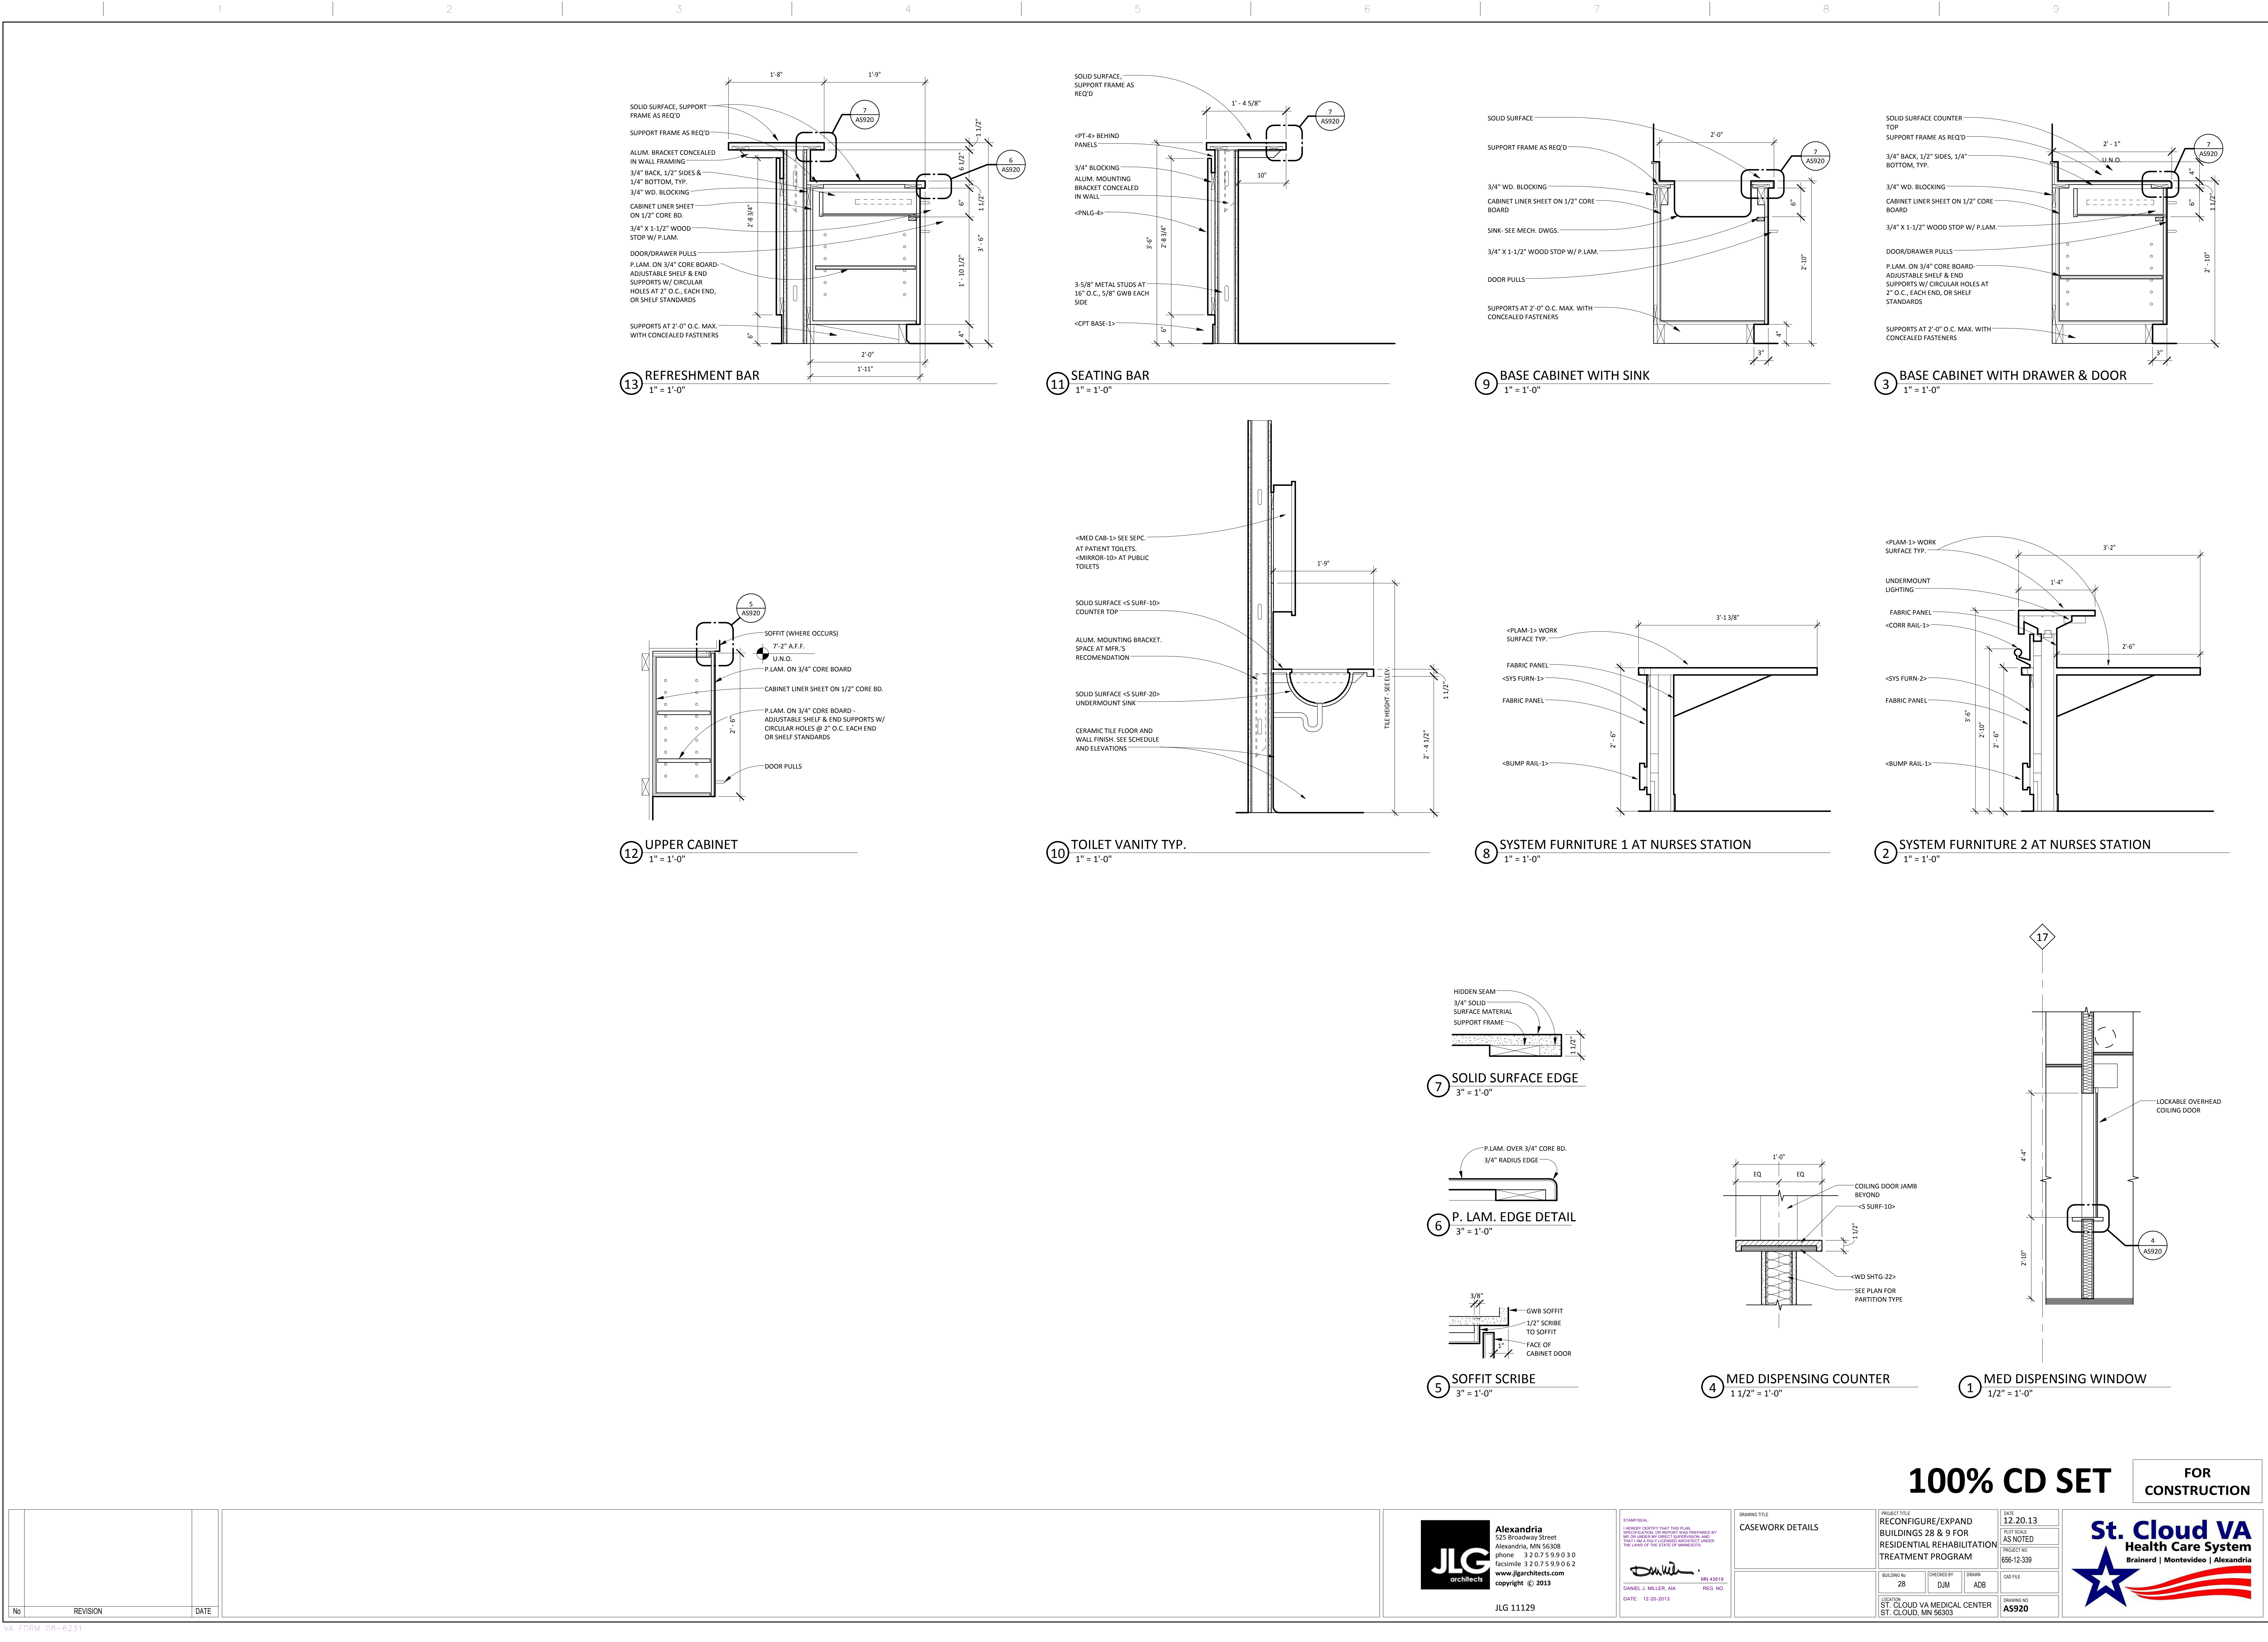

one eighth inch = one foot
one quarter inch = one foot
three eighths inch = one foot
one half inch = one foot
three quarters inch = one foot
one inch = one foot
one and one half inches = one foot
two inches = one foot
three inches = one foot
four inches = one foot
five inches = one foot
six inches = one foot
seven inches = one foot
eight inches = one foot
nine inches = one foot
ten inches = one foot
eleven inches = one foot
twelve inches = one foot
thirteen inches = one foot
fourteen inches = one foot
fifteen inches = one foot
sixteen inches = one foot
seventeen inches = one foot
eighteen inches = one foot
nineteen inches = one foot
twenty inches = one foot
twenty one inches = one foot
twenty two inches = one foot
twenty three inches = one foot
twenty four inches = one foot
twenty five inches = one foot
twenty six inches = one foot
twenty seven inches = one foot
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twenty nine inches = one foot
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sixty eight inches = one foot
sixty nine inches = one foot
seventy inches = one foot
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seventy nine inches = one foot
eighty inches = one foot
eighty one inches = one foot
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eighty five inches = one foot
eighty six inches = one foot
eighty seven inches = one foot
eighty eight inches = one foot
eighty nine inches = one foot
ninety inches = one foot
ninety one inches = one foot
ninety two inches = one foot
ninety three inches = one foot
ninety four inches = one foot
ninety five inches = one foot
ninety six inches = one foot
ninety seven inches = one foot
ninety eight inches = one foot
ninety nine inches = one foot
one hundred inches = one foot

Material and Finish Schedule								
Mark	Spec Section	Material Description	Manufacturer	Product	Color/Finish	Size	Special Instructions	Location Comments
ACT-1	095100	Acoustical Ceiling Tile	USG	Radar Clima Plus 2210	White	24" x 24"	Square Edge	Public Spaces, Patient Units
ACT-2	095100	Acoustical Ceiling Tile	USG	ClimaPlus	White	24" x 24"	Vinyl faced sheetrock panel, square edge; Aluminum grid	Patient Toilet Rooms
CER TILE-10	093000	Ceramic Tile	DALTILE	WALL TILE	White	3" x 6"	Running bond typ. See elev.	Wall tile in patient room toilets
CER TILE-11	093000	Ceramic Tile	DALTILE	Modern Dimensions	Matte Urban Putty 0761	3" x 6"	Soldier course - See Elev.	Accent wall tile in patient room toilets
CER TILE-12	093000	Ceramic Tile	DALTILE	FESTIVA WALL TILE	Willow	3" x 6"	Soldier course - See Elev.	Accent wall tile in public room toilets
CER TILE-20	093000	Ceramic Tile	DALTILE	MOSAIC FLOOR TILE	Pepper White	2" x 2"		Floor tile in toilet rooms
CER TILE-21	093000	Ceramic Tile	DALTILE	MOSAIC FLOOR TILE	Urban Putty	2" x 2"		Accent floor tile in public toilet rooms
CER TILE-22	093000	Ceramic Tile	DALTILE	MOSAIC FLOOR TILE	Suede Grey	2" x 2"		Accent floor tile in patient toilet rooms
CONC SLR-1	030000	Concrete Sealer	-	-	Clear	-		Mech/Elec support spaces
CORN GRD-2	102601	Corner Guard	Acrovyn	SM-20NA	Eggshell #100	NA		All outside corners TYP.
CORR RAIL-1	102601	Corridor Rail	Acrovyn	HRB 10CN	Eggshell #100	NA		Public corridors
CPT BASE-1	096800	Carpet wall base	J+J INVISION	TBD	TBD	4"		Public spaces and patient rooms
CPT TILE-1	096800	Carpet Tile	J+J INVISION	City Blocks	1304 Harvard Square	24" x 24"	Quarter Turn Installation	Public spaces and patient rooms
CPT-1	096800	Carpet	J+J INVISION	Pay Day	1408 High Roller	-	Broadloom	Public Spaces
CRASH RAIL-1	102601	Crash Rail	Acrovyn	SCR-40N	Eggshell #100	NA		Public corridors
FLR MAT-1	124800	Walk Off Mat	Kadee Industries	Alum. Rollout Mat with Vinyl Inserts	TBD	See Finish Plan		Entry Vestibule
PLAM CTOP-1	123600	Plastic laminate		TBD	TBD	3" x 6"		Wall tile in patient room toilets
PNLG-4	06200	Finished Wood Paneling	--	--	Select White Maple, Transparent Finish	See Drawings		Open Space Casework
PT-1	099000	Paint	Benjamin Moore	Eco Spec	White 962	--		Wall paint in support spaces
PT-2	099000	Paint	Benjamin Moore	Eco Spec	Shaker Beige HC-18	--		Field paint in public areas
PT-3	099000	Paint	Benjamin Moore	Interior/Low VOC	Smokey Mountain AC-18	--		Field paint in patient units
PT-4	099000	Paint	Benjamin Moore	Super Spec	Shaker Beige HC-45	--		HM Door Frames
RB BASE-1	096500	Rubber Wall Base	Johnsonite		Fawn	4"		Wall base at carpet and VCT floors
RB TRANS-1	096500	Rubber transition strip	Johnsonite		Fawn			Transition between carpet and VCT
S SURF-10	123600	Solid Polymer Fabrication	Corian		Beige Fieldstone	1/2" Thickness		Window sills
S SURF-20	123600	Solid Polymer Fabrication	Corian		White	1/2" Thickness	Undermount Sinks	Tranistions, counters, sinks
TILE TRIM-10	093000	Metal tile trim	Schleuter	Quadec	Clear anodized aluminum, satin/mat	5/16"		Patient unit toilets, public toilets
VCT-1	096500	Vinyl Composite Tile	ARMSTRONG	Standard Excelon	Camel Beige 51805	12" x 12"		Public Spaces
VCT-2	096500	Vinyl Composite Tile	ARMSTRONG	Standard Excelon	Fortress White	12" x 12"		Public Spaces

ROOM FINISH SCHEDULE									
ROOM NUMBER	ROOM NAME	FLOOR	BASE	WALLS				CEILING	REMARKS
				NORTH	EAST	SOUTH	WEST		
15	CORRIDOR							SEE RCP	
76	OPEN OFFICE	CPT-1	CPT BASE-1	PT-2	PT-2	PT-4	PT-2	SEE RCP	
77	ELECTRICAL ROOM	CONC SLR-1	RB BASE-1	PT-1	PT-1	PT-1	PT-1	SEE RCP	
78	OPEN OFFICE	CPT-1	CPT BASE-1	PT-2	PT-2	PT-4	PT-3	SEE RCP	
100	VESTIBULE	FLR MAT-1						SEE RCP	
101	EXAM ROOM							SEE RCP	
102	OFFICE							SEE RCP	
126	GROUP/MEETING ROOM	CPT-2	CPT BASE-1	PT-1	PT-1	PT-1	PT-1	SEE RCP	
129	VENDING							SEE RCP	
151B	Room								
155	OPEN OFFICE	CPT-1	CPT BASE-1	PT-2	PT-2	PT-4	PT-3	SEE RCP	
156	OPEN OFFICE	CPT-1	CPT BASE-1	PT-2	PT-3	PT-4	PT-2	SEE RCP	
201	OFFICE	CPT-1	CPT BASE-1	PT-2	PT-2	PT-3	PT-2	SEE RCP	
208	STORAGE	VCT-2	RB BASE-1	PT-1	PT-1	PT-1	PT-1	SEE RCP	
210	SPD	VCT-2	RB BASE-1	PT-1	PT-1	PT-1	PT-1	SEE RCP	
211	TOILET	CPT-1	CTB-1	PT-1	CWT-1	CWT-1	CWT-1	SEE RCP	
212	LAUNDRY	VCT-2	RB BASE-1	PT-1	PT-1	CER TILE-10	PT-1	SEE RCP	
213	CLEAN LINEN	VCT-2	RB BASE-1	PT-1	PT-1	PT-1	PT-1	SEE RCP	
215	MED	VCT-1	RB BASE-1	PT-1	PT-1	PT-1	PT-3	SEE RCP	
216	OFFICE	CPT-1	CPT BASE-1	PT-1	PT-1	PT-1	PT-3	SEE RCP	
217	NURSES' STATION	CPT-1	CPT BASE-1	SEE WALL FINISH PLAN	SEE WALL FINISH PLAN	SEE WALL FINISH PLAN	SEE WALL FINISH PLAN	SEE RCP	
221	TRASH	VCT-2	RB BASE-1	PT-1	PT-1	PT-1	PT-1	SEE RCP	
227	HAC	VCT-2	RB BASE-1	PT-1	PT-1	PT-1	PT-1	SEE RCP	
228	DATA	VCT-1	RB BASE-1	PT-1	PT-1	PT-1	PT-1	SEE RCP	
229	MULTI-PURPOSE ROOM	CPT TILE-1	CPT BASE-1	PT-4	PT-4	PT-4	PT-4	SEE RCP	
230	REFRESHMENT AREA	VCT-1	RB BASE-1	SEE WALL FINISH PLAN	SEE WALL FINISH PLAN	SEE WALL FINISH PLAN	SEE WALL FINISH PLAN	SEE RCP	
231	OPEN LOUNGE	CPT-1	CPT BASE-1	SEE WALL FINISH PLAN	SEE WALL FINISH PLAN	SEE WALL FINISH PLAN	SEE WALL FINISH PLAN	SEE RCP	
232	LOW VOLTAGE	VCT-2	RB BASE-1	PT-1	PT-1	PT-1	PT-1	SEE RCP	
233	STAFF LOUNGE/BREAK ROOM	CPT-2	CPT BASE-1	PT-3	PT-1	PT-1	PT-1	SEE RCP	
234	ELECTRICAL	VCT-1	RB BASE-1	PT-1	PT-1	PT-1	PT-1	SEE RCP	
235	HAC	VCT-2	RB BASE-1	PT-1	PT-1	PT-1	PT-1	SEE RCP	
236	STORAGE	VCT-2	RB BASE-1	PT-1	PT-1	PT-1	PT-1	SEE RCP	
237	LOW VOLTAGE	VCT-2	RB BASE-1	PT-1	PT-1	PT-1	PT-1	SEE RCP	
242	TRASH	VCT-2	RB BASE-1	PT-1	PT-1	PT-1	PT-1	SEE RCP	
243	PIPE CHASE								
246	PIPE CHASE								
248	NURSES' STATION	CPT-1	CPT BASE-1	SEE WALL FINISH PLAN	SEE WALL FINISH PLAN	SEE WALL FINISH PLAN	SEE WALL FINISH PLAN	SEE RCP	
249	OFFICE	CPT-1	CPT BASE-1	PT-1	PT-3	PT-1	PT-1	SEE RCP	
250	MED	VCT-1	RB BASE-1	PT-1	PT-3	PT-1	PT-1	SEE RCP	
252	CLEAN LINEN	VCT-2	RB BASE-1	PT-1	PT-1	PT-1	PT-1	SEE RCP	
253	LAUNDRY	VCT-2	RB BASE-1	PT-1	PT-1	CER TILE-10	PT-1	SEE RCP	
254	TOILET	CPT-1	CER TILE-10	PT-1	CWT-1	CWT-1	CWT-1	SEE RCP	
255	SPD	VCT-2	RB BASE-1	PT-1	PT-1	PT-1	PT-1	SEE RCP	
264	MULTI-PURPOSE ROOM	CPT TILE-1	CPT BASE-1	PT-2	PT-2	PT-2	PT-2	SEE RCP	
265	REFRESHMENT AREA	VCT-1	RB BASE-1	SEE WALL FINISH PLAN	SEE WALL FINISH PLAN	SEE WALL FINISH PLAN	SEE WALL FINISH PLAN	SEE RCP	
269	OPEN LOUNGE	CPT-1	CPT BASE-1	SEE WALL FINISH PLAN	SEE WALL FINISH PLAN	SEE WALL FINISH PLAN	SEE WALL FINISH PLAN	SEE RCP	
267	CORRIDOR	VCT-1	RB BASE-1	SEE WALL FINISH PLAN	SEE WALL FINISH PLAN	SEE WALL FINISH PLAN	SEE WALL FINISH PLAN	SEE RCP	
C2E	CORRIDOR	CPT-1	CPT BASE-1	SEE WALL FINISH PLAN	SEE WALL FINISH PLAN	SEE WALL FINISH PLAN	SEE WALL FINISH PLAN	SEE RCP	
C2W	CORRIDOR	CPT-1	CPT BASE-1	SEE WALL FINISH PLAN	SEE WALL FINISH PLAN	SEE WALL FINISH PLAN	SEE WALL FINISH PLAN	SEE RCP	
S101	STAIR								
T1	CONNECTING CORRIDOR								

ROOM FINISH SCHEDULE - UNITS								
ROOM NAME	FLOOR	BASE	WALLS				CEILING	REMARKS
			NORTH	EAST	SOUTH	WEST		
SINGLE ROOM	CPT-1	CPT BASE-1	SEE WALL FINISH PLAN	SEE WALL FINISH PLAN	SEE WALL FINISH PLAN	SEE WALL FINISH PLAN	SEE RCP	
DOUBLE ROOM	CPT-1	CPT BASE-1	SEE WALL FINISH PLAN	SEE WALL FINISH PLAN	SEE WALL FINISH PLAN	SEE WALL FINISH PLAN	SEE RCP	
BATHROOM	CER TILE-22	CTB-1	CER TILE-10/PT-5	CER TILE-10/PT-5	CER TILE-10/PT-5	CER TILE-10/PT-5	SEE RCP	

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FOR CONSTRUCTION



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525 Broadway Street
Alexandria, MN 56308
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facsimile 320.759.9062
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STAMPED:
I HEREBY CERTIFY THAT THIS PLAN
PREPARED, DESIGNED, OR PREPARED AND PREPARED BY
ME OR UNDER MY DIRECT SUPERVISION AND
THAT I AM A LICENSED ARCHITECT UNDER
THE LAWS OF THE STATE OF MINNESOTA.

DANIEL J. MILLER, AIA
DATE: 12-20-2013
MIN. CSR#
REG. NO.

DRAWING TITLE
ROOM FINISH SCHEDULE

PROJECT TITLE
RECONFIGURE/EXPAND
BUILDINGS 28 & 9 FOR
RESIDENTIAL REHABILITATION
TREATMENT PROGRAM

BUILDING No
28
CHECKED BY
DJM
DRAWN
ADB
LOCATION
ST. CLOUD VA MEDICAL CENTER
ST. CLOUD, MN 56303

DATE
12.20.13
PROJECT NO.
656-12-339
DOW FILE
1001



three inches = one foot
one and one half inches = one foot
one inch = one foot
three quarters inch = one foot
one half inch = one foot
three eighths inch = one foot
one quarter inch = one foot
one eighth inch = one foot

1 BASEMENT FINISH FLOOR PLAN
1/8" = 1'-0"

FINISH PLAN GENERAL NOTES

- A. PROVIDE CARPET BASE (CPT BASE-1) AT ALL CARPET FLOORING LOCATIONS U.N.O. PROVIDE RUBBER BASE (RB BASE-1) AT ALL VCT FLOORING LOCATIONS U.N.O.
- B. REFER TO UNIT PLANS & ROOM FINISH SCHEDULE FOR FINISH INFORMATION IN PATIENT UNITS.
- C. PROVIDE CORNER GUARDS (CORN GRD-2) AT ALL OUTSIDE CORNERS IN PATIENT ROOMS - SEE UNIT PLANS.
- D. DASHED LINE ——— INDICATES LOCATIONS OF CORRIDOR RAILS (CORR RAIL-1) AND CRASH RAILS (CRASH RAIL-1). PROVIDE 20 GAL. METAL STUD BLOCKING AT ALL RAIL LOCATIONS. SEE WALL FINISH PLAN AND MATERIAL SCHEDULE FOR MORE INFORMATION.
- E. ROOM FINISH TAG:
- | | |
|-------------------|---|
| ROOM NUMBER | → |
| NORTH WALL FINISH | → |
| WEST WALL FINISH | → |
| EAST WALL FINISH | → |
| SOUTH WALL FINISH | → |
| BASE FINISH | → |
| FLOOR FINISH | → |

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NO.	REVISION	DATE



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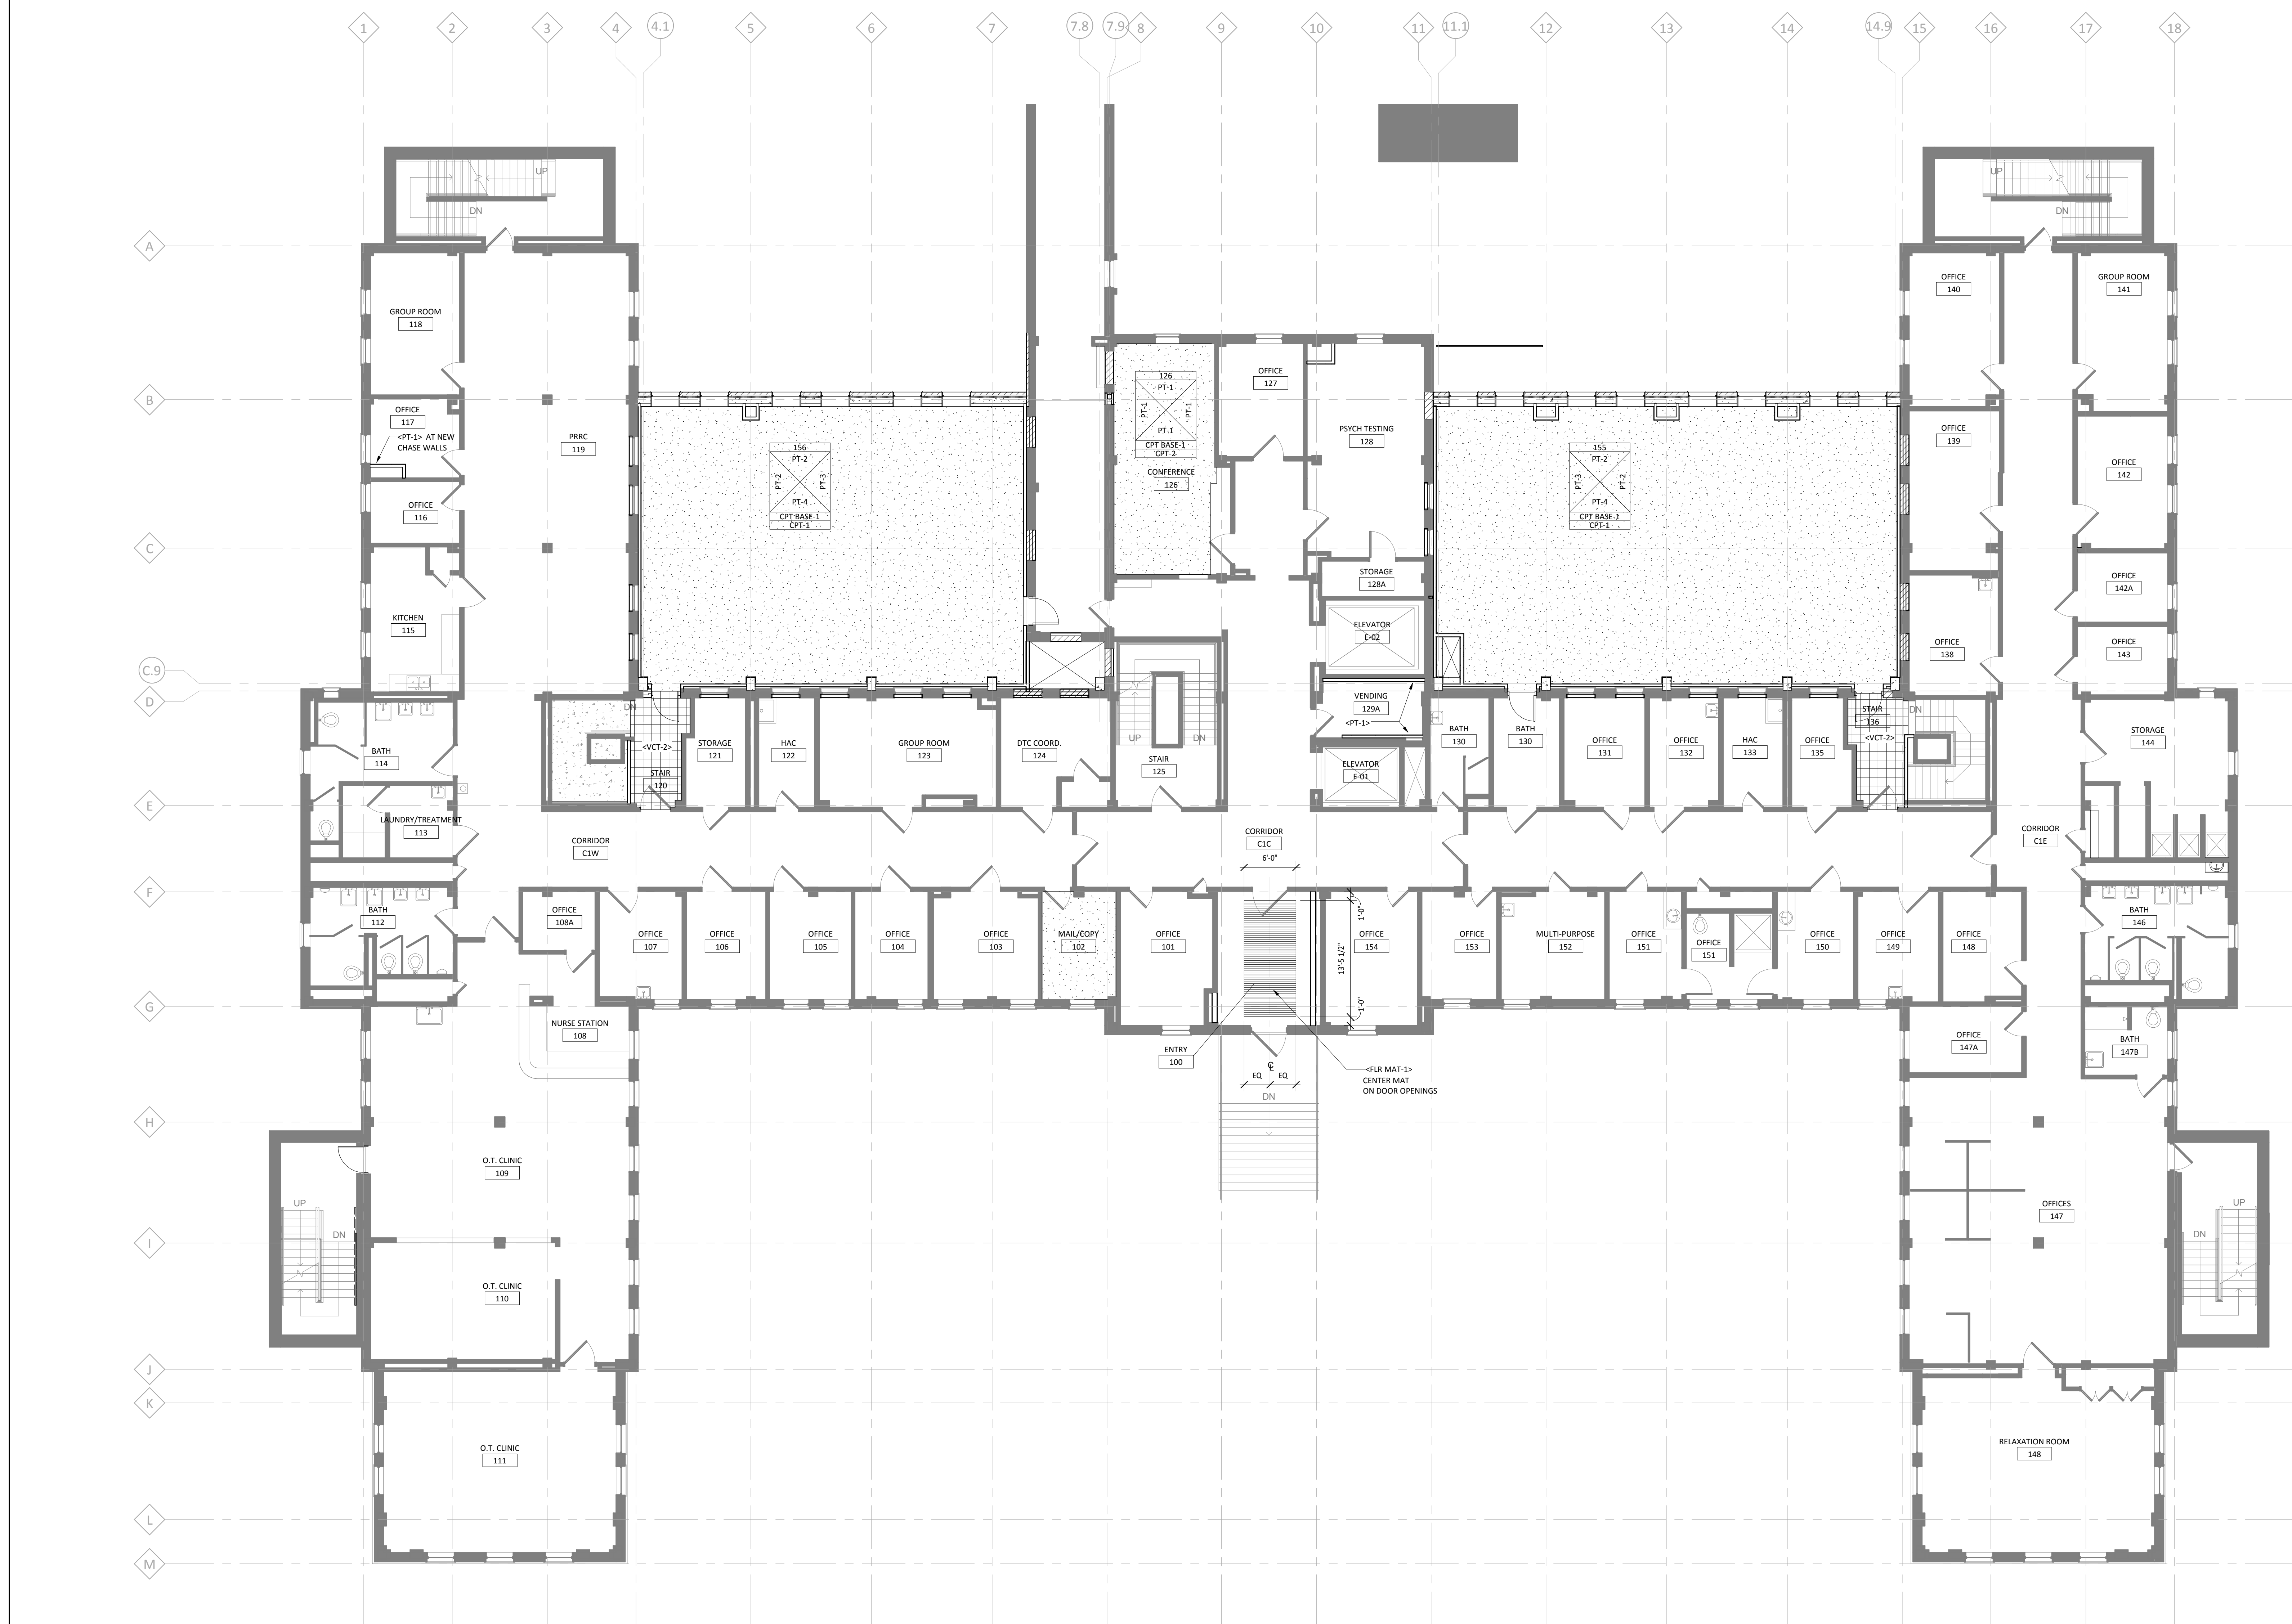
STAMPED:
DANIEL J. MILLER, AIA
DATE: 12-20-2013
REG. NO. MN-0818

DRAWING TITLE
BASEMENT FINISH FLOOR PLAN

PROJECT TITLE
RECONFIGURE/EXPAND
BUILDINGS 28 & 9 FOR
RESIDENTIAL REHABILITATION
TREATMENT PROGRAM

DATE
12.20.13
PROJECT NO.
656-12-339
DRAWING NO.
1100






**FOR
CONSTRUCTION**

[illegible]

three inches = one foot
one inch = one foot
one and one half inches = one foot
one inch = one foot
three quarters inch = one foot
one half inch = one foot
three eighths inch = one foot
one quarter inch = one foot
one eighth inch = one foot

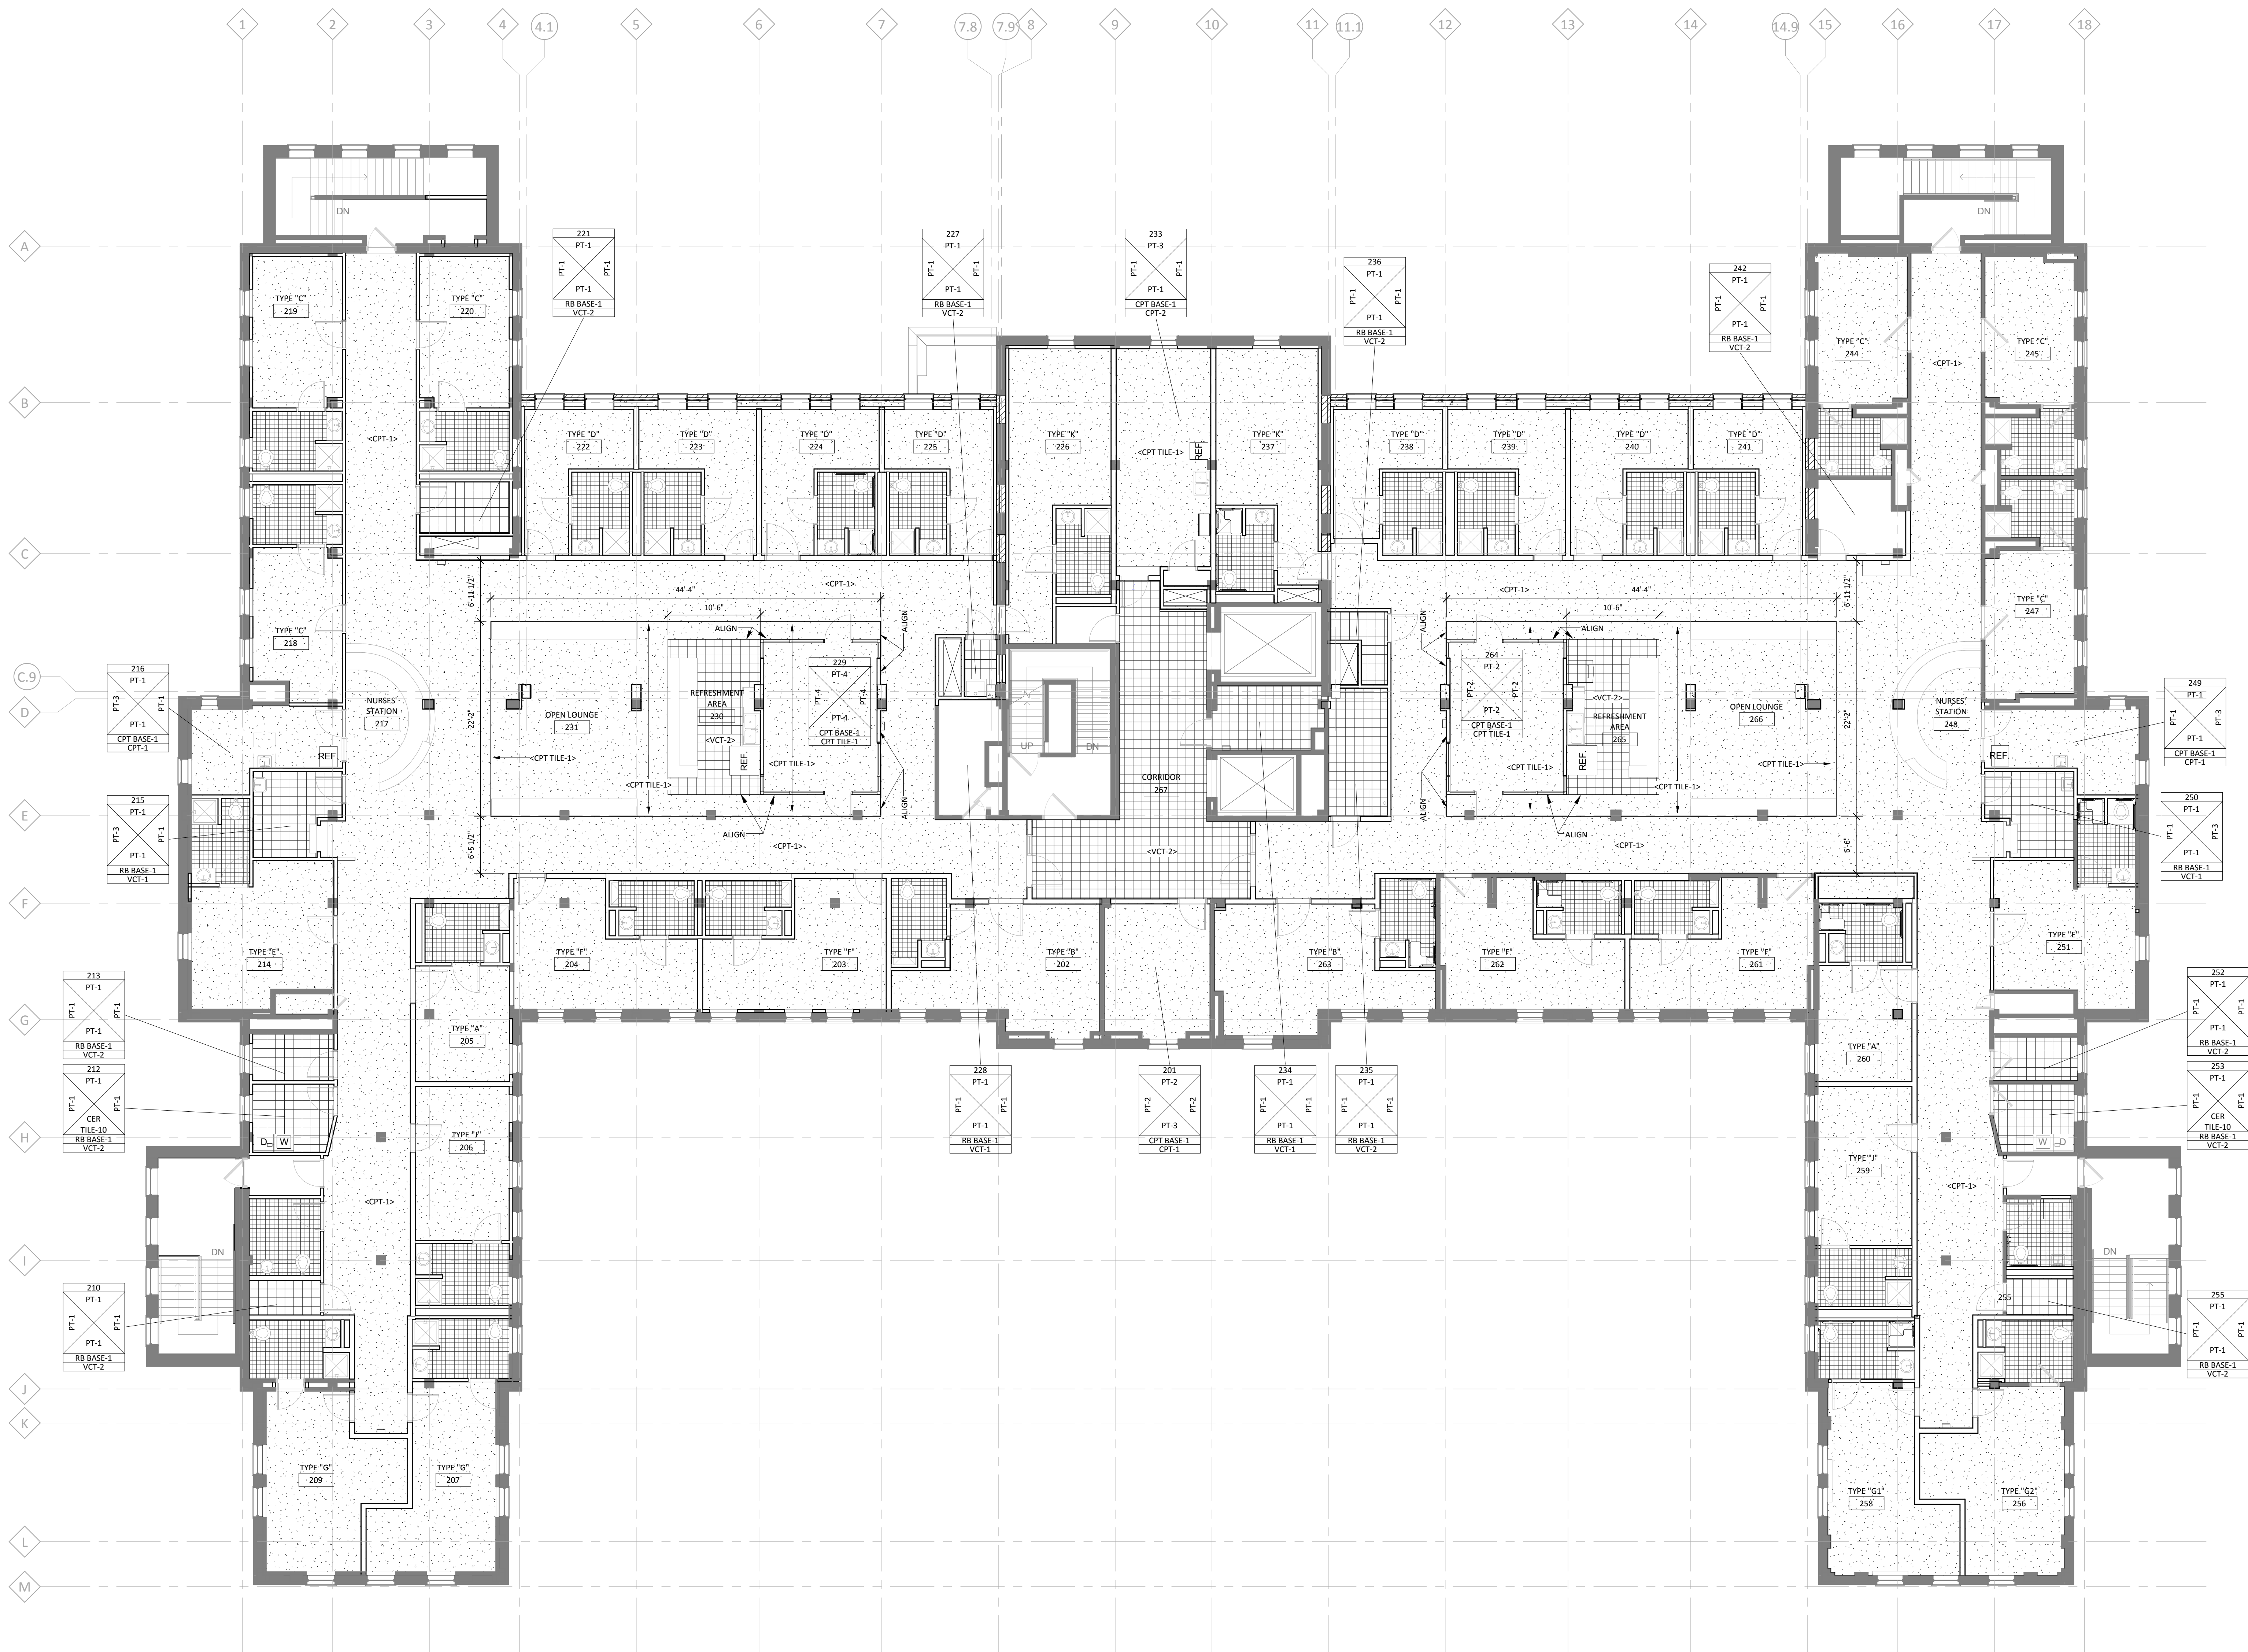

FINISH PLAN GENERAL NOTES

A. PROVIDE CARPET BASE (CPT BASE-1) AT ALL CARPET FLOORING LOCATIONS U.N.O. PROVIDE RUBBER BASE (RB BASE-1) AT ALL VCT FLOORING LOCATIONS U.N.O.

B. REFER TO UNIT PLANS AND ROOM FINISH SCHEDULE FOR FINISH INFORMATION IN PATIENT UNITS.

C. PROVIDE CORNER GUARDS (CORN GRD-2) AT ALL OUTSIDE CORNERS IN PATIENT ROOMS - SEE UNIT PLANS.

D. DASHED LINE ——— INDICATES LOCATIONS OF CORRIDOR RAILS (CORN RAIL-1) AND CRASH RAILS (CRASH RAIL-1). PROVIDE 20 GA. METAL STUD BLOCCING AT ALL RAIL LOCATIONS. SEE WALL FINISH PLAN AND MATERIAL SCHEDULE FOR MORE INFORMATION.

E. ROOM FINISH TAG:

ROOM NUMBER	ROOM NUMBER
NORTH WALL FINISH	NORTH WALL FINISH
WEST WALL FINISH	WEST WALL FINISH
EAST WALL FINISH	EAST WALL FINISH
SOUTH WALL FINISH	SOUTH WALL FINISH
BASE FINISH	BASE FINISH
FLOOR FINISH	FLOOR FINISH

1 SECOND FLOOR FINISH PLAN
1/8" = 1'-0"



NO.	REVISION	DATE

VA FORM 28-6231



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STAMPED:
DANIEL J. MILLER, AIA
DATE: 12-20-2013

DRAWING TITLE
SECOND FLOOR FINISH FLOOR PLAN

PROJECT TITLE
RECONFIGURE/EXPAND BUILDINGS 28 & 9 FOR RESIDENTIAL REHABILITATION TREATMENT PROGRAM

BUILDING NO. 28
CHECKED BY DJM
DRAWN ADB
LOCATION ST. CLOUD VA MEDICAL CENTER ST. CLOUD, MN 56303

DATE 12.20.13
FILED SCALE AS NOTED
PROJECT NO. 656-12-339

DATE FILE
DRAWING NO. 1102

100% CD SET

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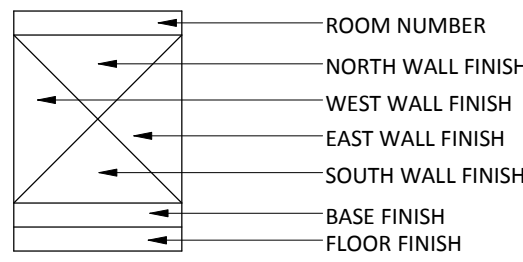


three inches = one foot
one and one half inches = one foot
one inch = one foot
three quarters inch = one foot
one half inch = one foot
three eighths inch = one foot
one quarter inch = one foot
one eighth inch = one foot

1 SECOND FLOOR WALL FINISH PLAN
1/8" = 1'-0"

FINISH PLAN GENERAL NOTES

- PROVIDE CARPET BASE (CPT BASE-1) AT ALL CARPET FLOORING LOCATIONS U.N.O. PROVIDE RUBBER BASE (RB BASE-1) AT ALL VCT FLOORING LOCATIONS U.N.O.
- REFER TO UNIT PLANS & ROOM FINISH SCHEDULE FOR FINISH INFORMATION IN PATIENT UNITS.
- PROVIDE CORNER GUARDS (CORN GRD-2) AT ALL OUTSIDE CORNERS IN PATIENT ROOMS - SEE UNIT PLANS.
- DASHED LINE — INDICATES LOCATIONS OF CORRIDOR RAILS (CORN RAIL-1) AND CRASH RAILS (CRASH RAIL-1). PROVIDE 20 GA. METAL STUD BLOCKING AT ALL RAIL LOCATIONS. SEE WALL FINISH PLAN AND MATERIAL SCHEDULE FOR MORE INFORMATION.
- ROOM FINISH TAG:



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STAMPED:
DANIEL J. MILLER, AIA
DATE: 12-20-2013

DRAWING TITLE
WALL FINISH PLAN

PROJECT TITLE
RECONFIGURE/EXPAND
BUILDINGS 28 & 9 FOR
RESIDENTIAL REHABILITATION
TREATMENT PROGRAM

BUILDING No. 28
CHECKED BY DJM
DRAWN ADB
LOCATION
ST. CLOUD VA MEDICAL CENTER
ST. CLOUD, MN 56303

DATE
12.20.13
PROJECT NO.
656-12-339

NO. 1202
DRAWING NO.



one eighth inch = one foot
one quarter inch = one foot
three eighths inch = one foot
one half inch = one foot
three quarters inch = one foot
one inch = one foot
one and one half inches = one foot
two inches = one foot
three inches = one foot



Furniture Schedule			
Type Mark	Model	Description	Approximate Size
B1		PATIENT BED	84"L x 40"W
C1		CHAIR	
D1		DESK	48"W x 24"D x 30"H
S1		STOOL	
T1		NIGHTSTAND	18" x 18 1/2" x 24"H
T2		ROUND TABLE	36" DIAMETER
W1		WARDROBE	36"W x 24"D x 60"H

1 LEVEL TWO FURNITURE PLAN
1/8" = 1'-0"
DRAWING FOR REFERENCE ONLY: FFE BY VA

No	REVISION	DATE

VA FORM 05-6231



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STAMPED
I hereby certify that this plan
was prepared or prepared by
me or under my direct supervision
and that I am a duly licensed architect
under the laws of the State of Minnesota.

DANIEL J. MILLER, AIA
DATE: 12-20-2013
REG. NO. 19318

DRAWING TITLE
LEVEL 2 FURNITURE PLAN

PROJECT TITLE
RECONFIGURE/EXPAND
BUILDINGS 28 & 9 FOR
RESIDENTIAL REHABILITATION
TREATMENT PROGRAM

BUILDING No. 28
CHECKED BY DJM
DRAWN ADB
DATE: 12-20-2013
REG. NO. 19318

DATE
12.20.13
FIRST SCALE
AS NOTED
PROJECT NO.
656-12-339

DWG FILE
DRAWING NO.
1302

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